

Business Services Contracts Office

5735 47th Avenue ● Sacramento, CA 95824 (916) 643-2464

Rose Ramos, Chief Business Officer Robert Aldama, Purchasing Manager II

ADDENDUM NO. 3

Date: August 21, 2023

Issued by: Sacramento City Unified School District

Project: Project #: 0146-465

0146-465 Isador Cohen ES / Rosemont HS Security Improvements: Group 1

This addenda shall supersede the original Information, attachments, and specifications regarding **Project No. 0146-465** where it adds to, deletes from, clarifies or otherwise modifies them. All other conditions and any previous addenda shall remain unchanged.

Part A - Bidder Questions

QUESTION #1: Per the "notice to bidders" The District will only receive bids submitted electronically through eBuilder. Per the "instructions to bidders": District will receive sealed bids from bidders as stipulated in the Notice to Bidders. Bids may also be submitted electronically in E-Builder.

- a. All bids must be sealed in an envelope, marked with the name and address of the Bidder, name of the Project, the Project Number and/or bid number, and time of bid opening.
- b. Bids must be submitted to the District Office at 5737 47th Avenue, Sacramento, CA by date and time shown in the Notice to Bidders.

Please confirm that bids only need to be submitted through e-Builder.

RESPONSE: Confirmed, bids only need to be submitted to eBuilder.

QUESTION #2: If submitted through e-Builder, does the original bid bond need to be sent directly to the district as well as uploaded to e-builder? If so, please provide contact information

RESPONSE: A copy of the bond needs to be provided and original mailed.

QUESTION #3: What is to be entered on the response form "step 3 additional info" in the qualifications text box?

RESPONSE: Field can be left blank. Not applicable for this project.

Page 1 of 3

Project No: 0146-465 Isador Cohen ES / Rosemont HS Security Improvements: Group 1 <u>ADDENDUM NO. 3</u>

QUESTION #4: Please confirm that OCIP Insurance Forms are not required as part of the bid form as stated in Item 7.

- 7. The following documents are attached hereto:
 - Bid Bond on the District's form or other security
 - Designated Subcontractors list
 - Site Visit Verification
 - Non-Collusion Declaration
 - Iran Contracting Act Certification
 - OCIP Insurance Forms

RESPONSE: OCIP Insurance Forms are not required.

Part B – Drawings & Specifications

Isador Cohen ES

Sheet C0.0

- Project description updated.

Sheet C1.0.1

- Site access plan updated with additional references.
- Gate legend added.
- General access notes added.
- Typical gate clearance details added.

Sheet C1.0.2

- Site fire plan updated with additional references.
 - Multi-purpose egress analysis provided.

Sheet C2.1

- Surface repair general note added.
- Two new pedestrian gates added.

Sheet C3.1

- Two new pedestrian gates added & view 1 and 2 added to detail.

Sheet C4.1

- Details 5 updated within additional code require information.

Rosemont HS

Sheet C0.0

Project description updated.

Sheet C1.0.1

- Site access plan updated with additional references.
- Gate legend added.
- General access notes added.
- Typical gate clearance details added.

Sheet C1.0.2

Project No: 0146-465 Isador Cohen ES / Rosemont HS Security Improvements: Group 1 <u>ADDENDUM NO. 3</u>

- Site fire plan updated with additional references.
- Multi-purpose egress analysis provided.

Sheet C1.1

- Additional demolition shown for installation of new flatwork in view 1 near north most gate.

Sheet C2.1

- Additional flatwork shown in view 2 near north most gate.
- Surface repair general note added.

Sheet C3.1

- View 1 updated to change gate type in 2 locations.
- View 2 updted to change gate type in 2 locations.
- Ornamental fence note 2 updated.
- Ornamental fence note 3 updated to include additional detail reference.
- Chain link fence note 32 removed as it is no longer used.
- Chain link fence note 34 removed as it is no longer used.

Sheet C4.1.

- Detail 5 updated to include additional code information.

Sheet C4.2

- Detail 4 modified and detail 5 and 6 added.

Sheet C4.3

- Detail 4 modified and detail 5 and 6 added.
- Details 2 thru 5 eliminated.
- New detail 6 re-numbered to detail 2.

List of Attachments

AD3.01 – Isador Cohen – Addendum No.1 Drawings (6 Pages)

AD3.02 – Rosemont – Addendum No.1 Drawings (9 Pages)

END OF ADDENDUM NO. 3


Acknowledgement of this Addendum will be required at time of bid.

ISADOR COHEN ELEMENTARY SCHOOL 2023 FENCING

9025 Salmon Falls Drive Sacramento, CA 95826






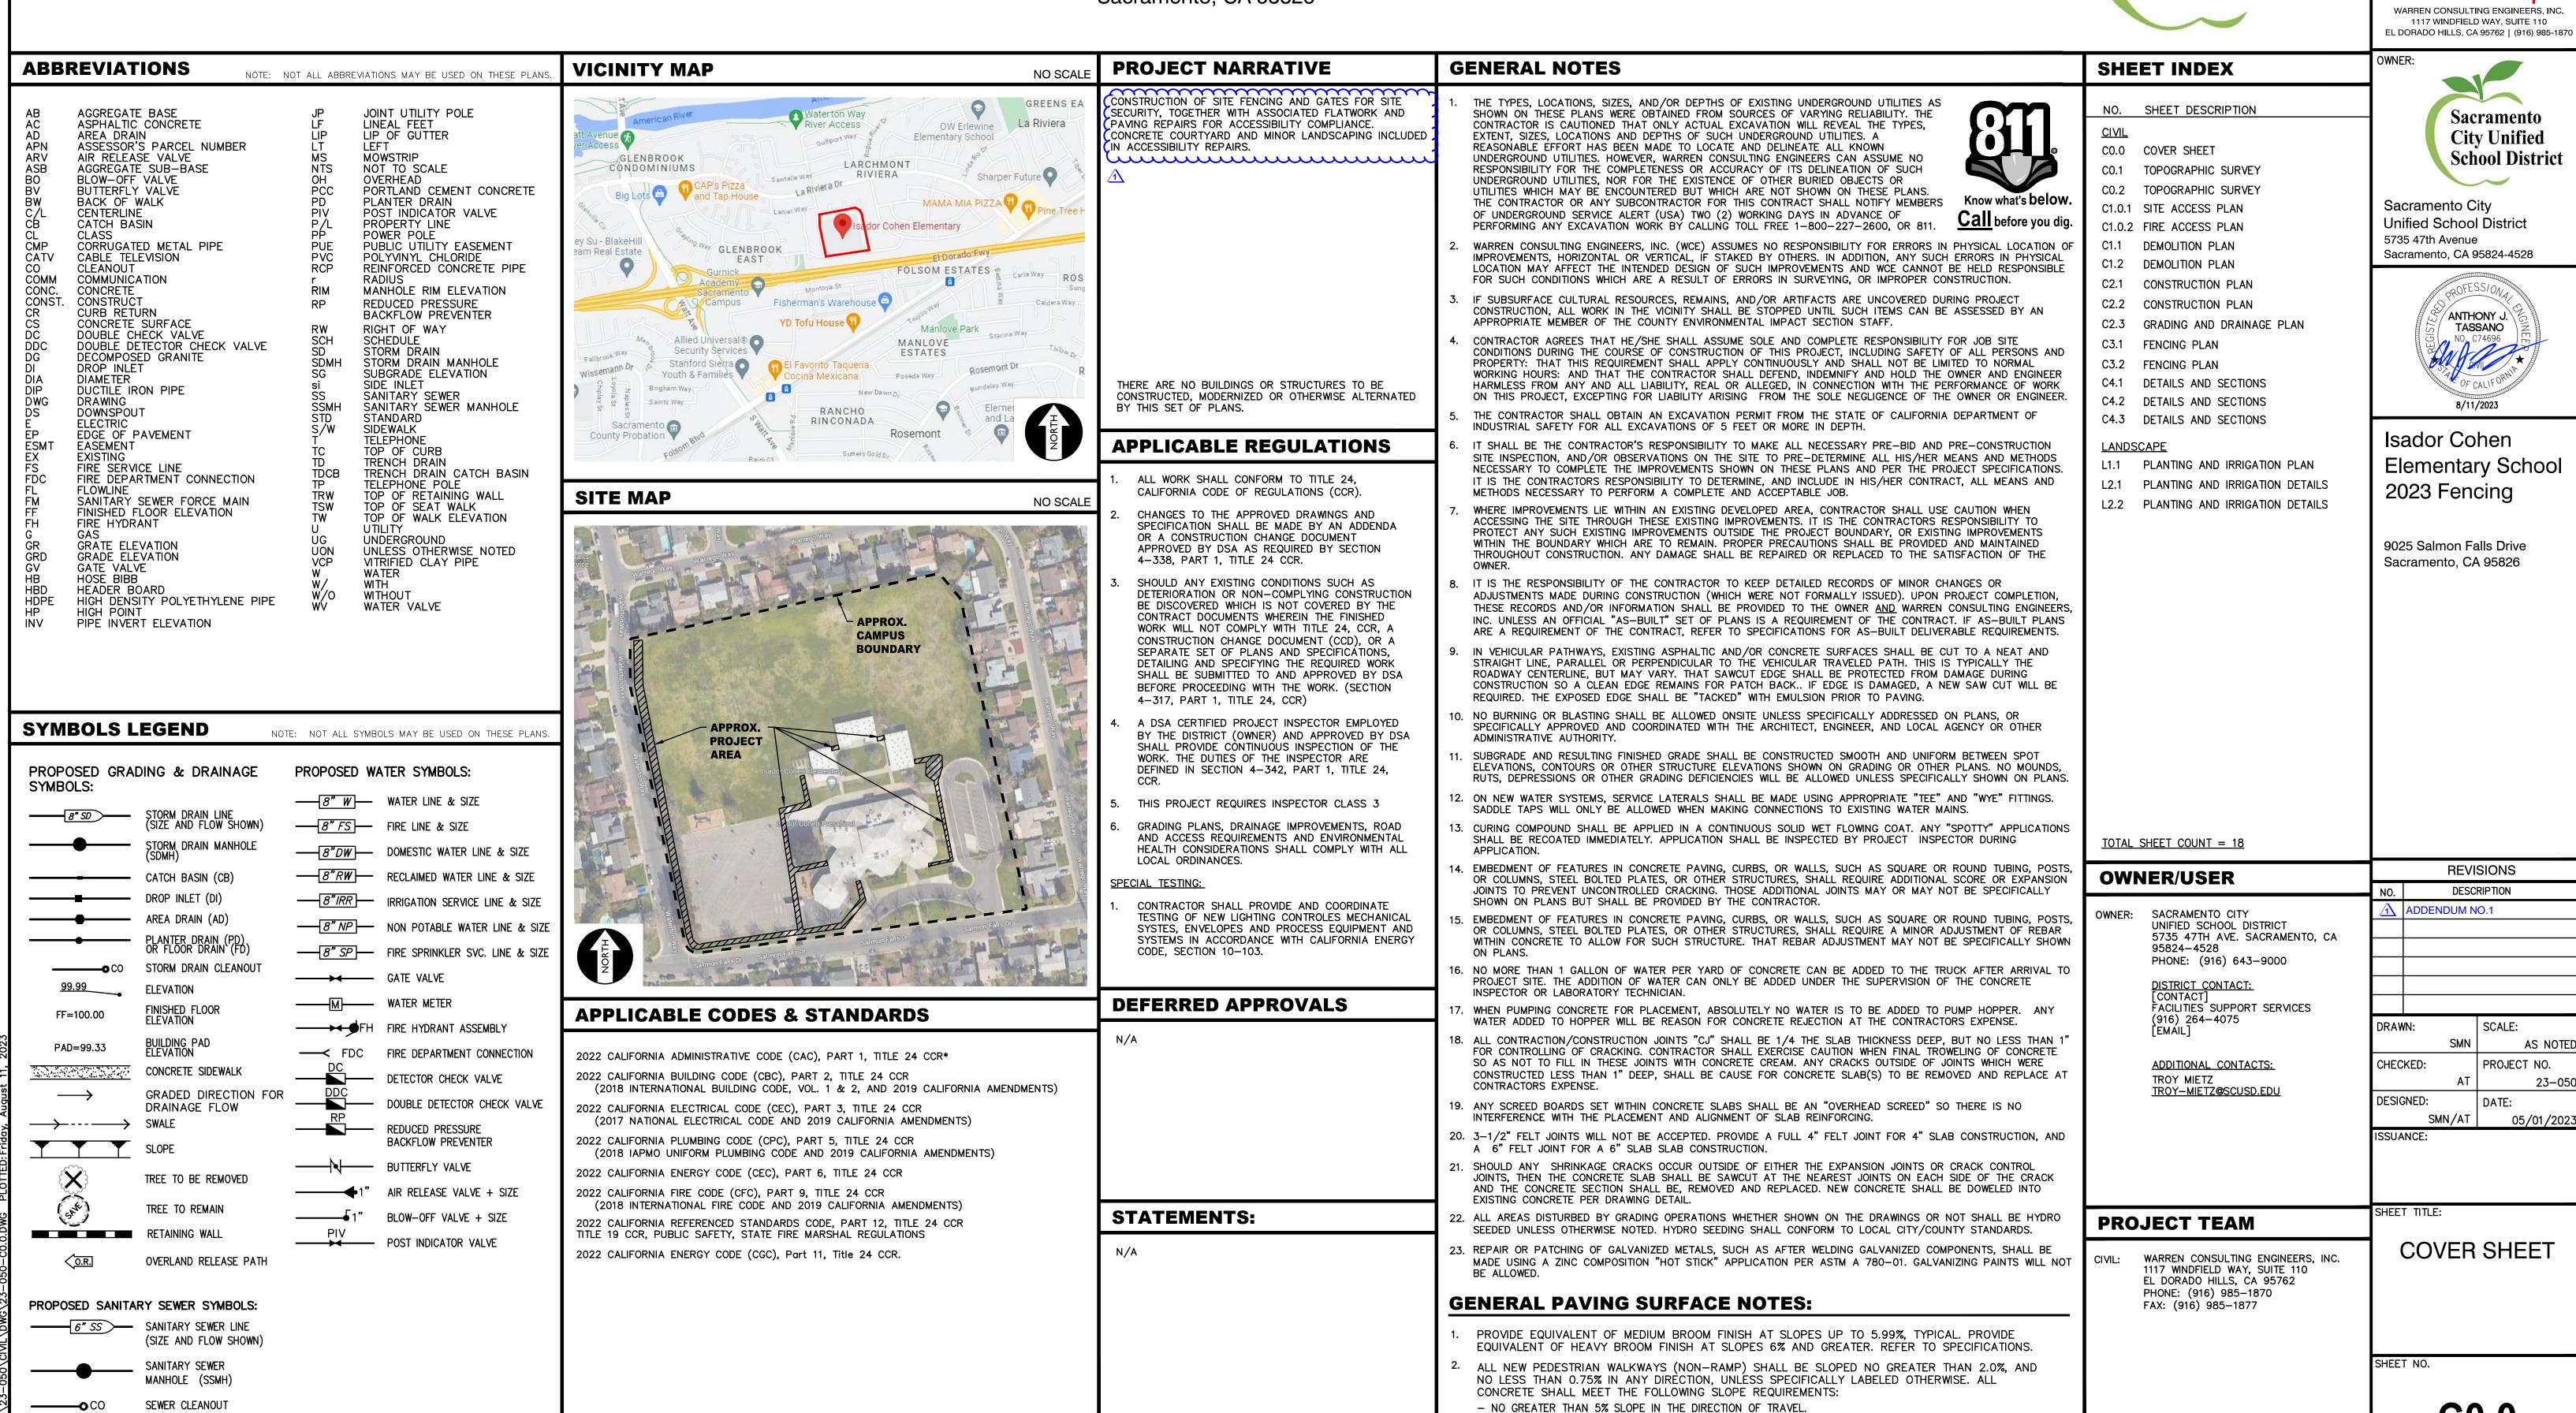

- NO GREATER THAN 2% SLOPE CROSSING THE DIRECTION OF TRAVEL.

NO GREATER THAN 2% SLOPE IN ANY DIRECTION IN COURTYARD OR PLAZA AREAS.

FLUSHER BRANCH

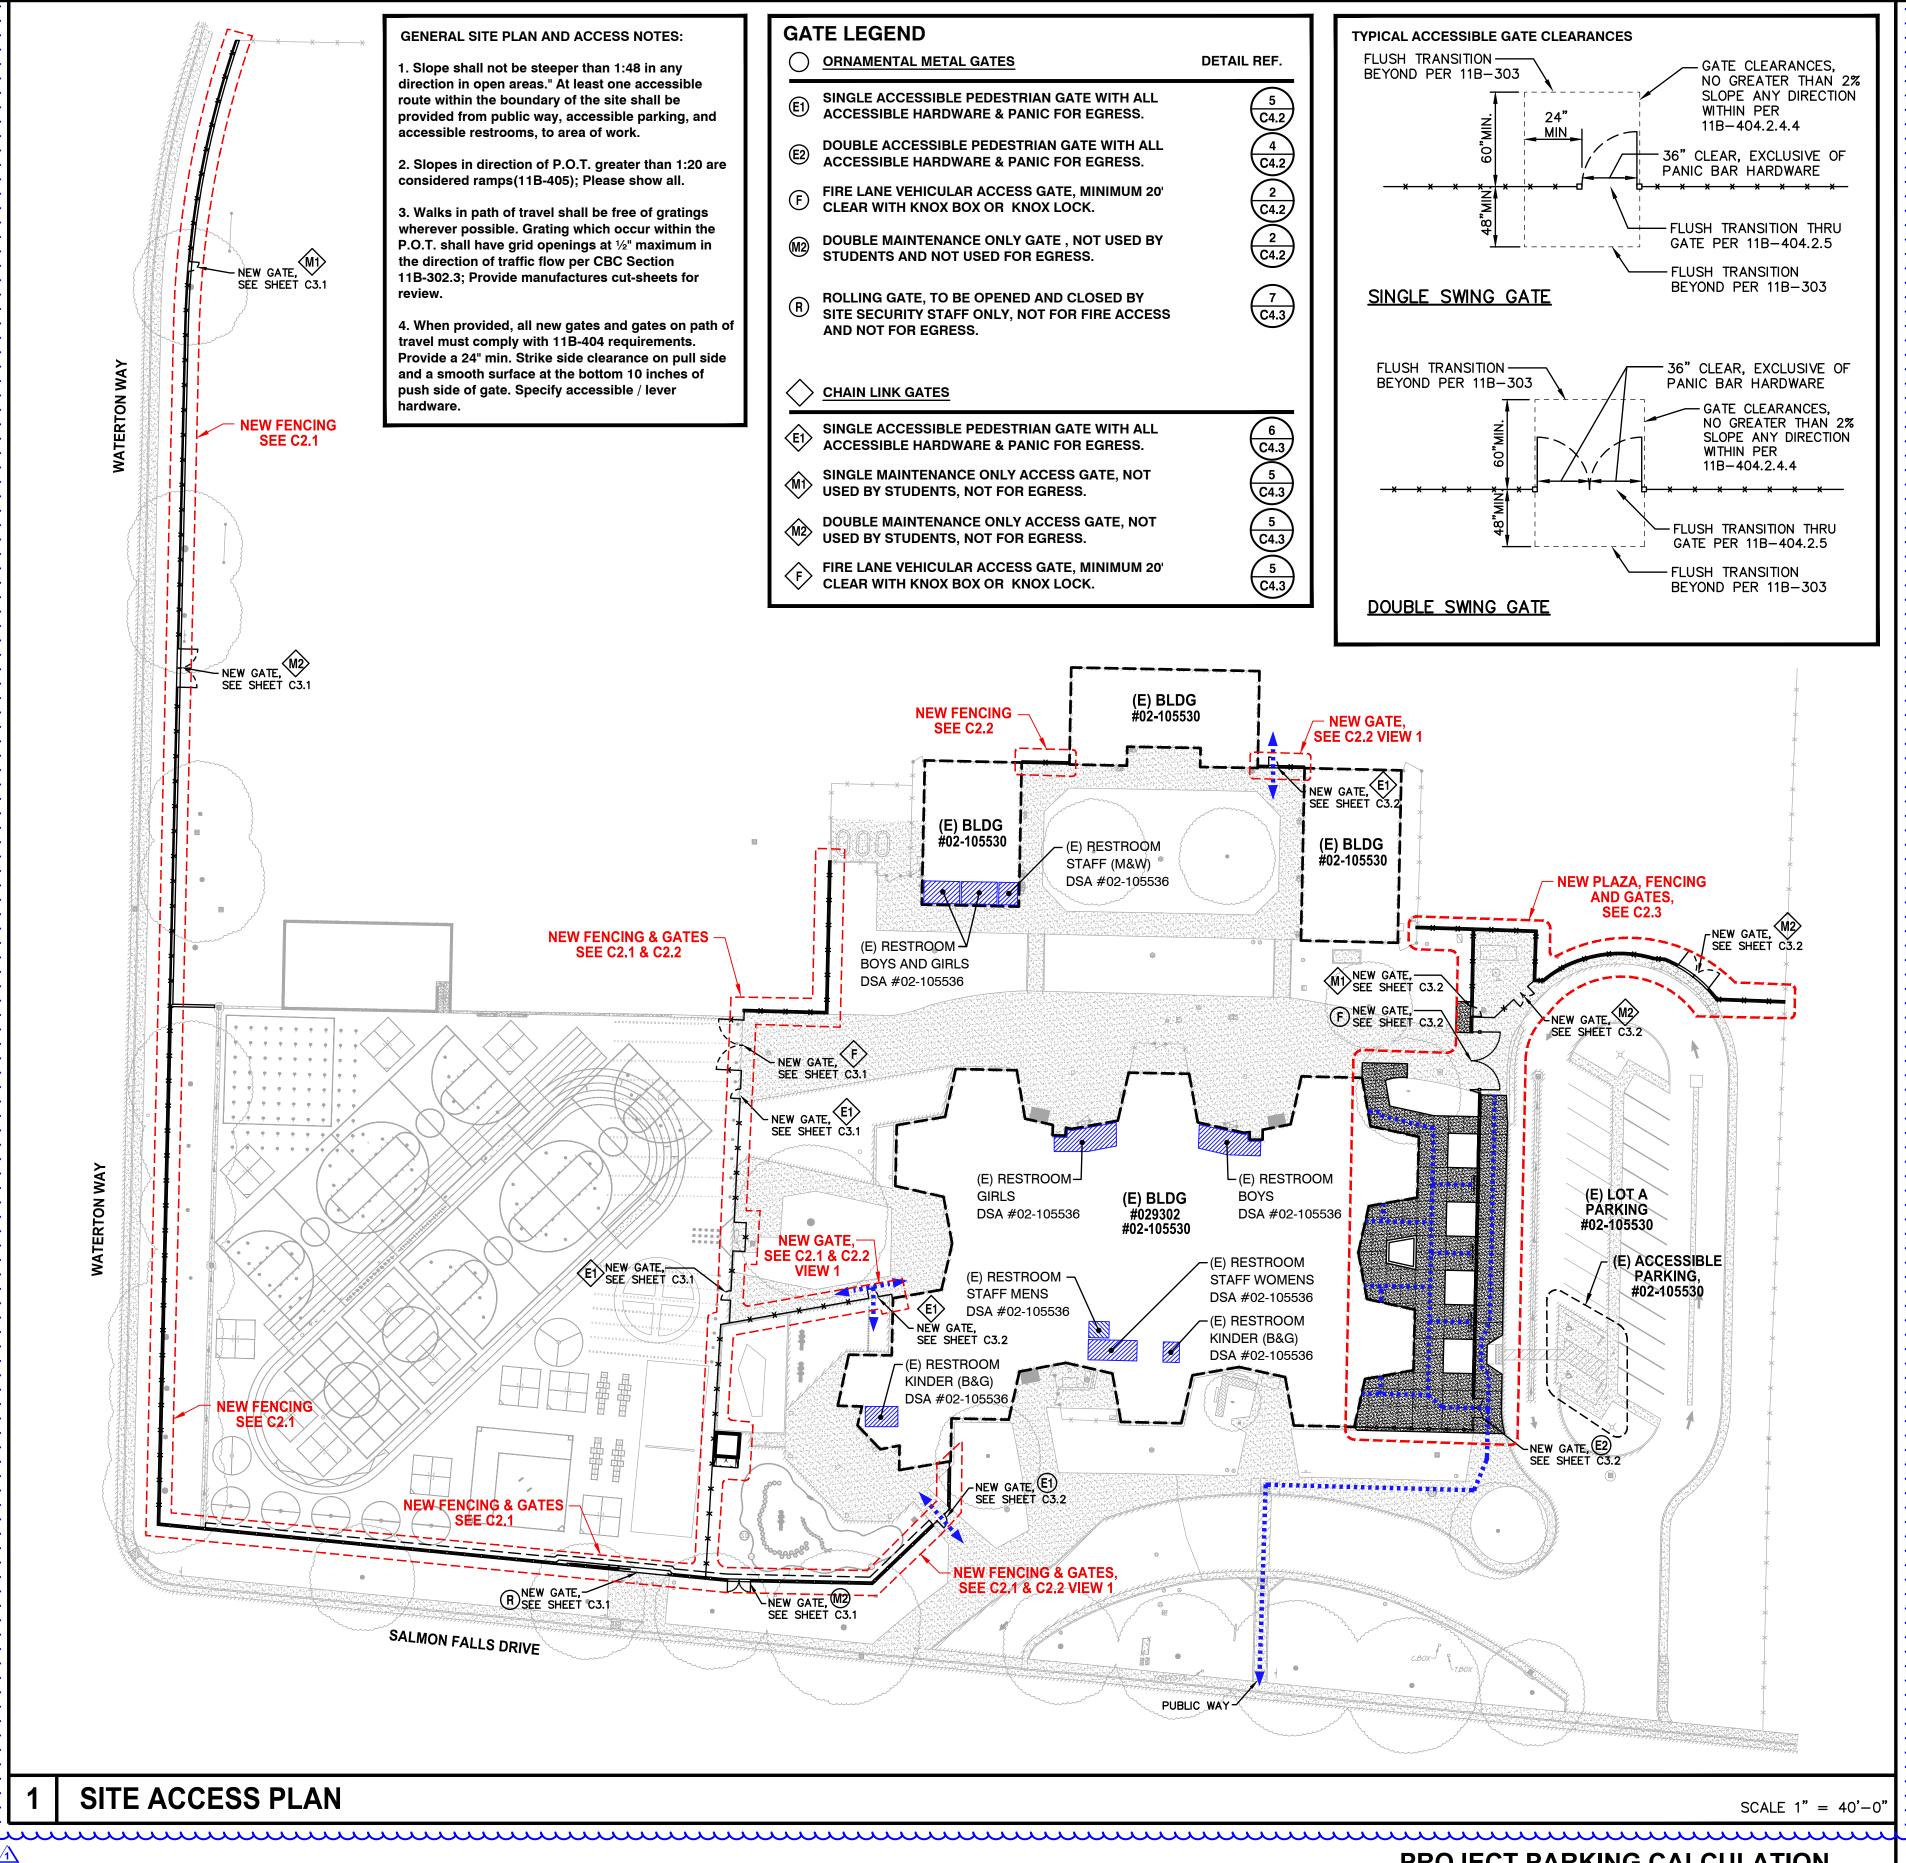

PROJECT PARKING CALCULATION

| PARKING LOT A PARKING TOTALS | EXISTING | PROPOSED |
|---|----------|----------|
| STANDARD PARKING STALLS ACCESSIBLE PARKING SPACES | 23 2 | 23 2 |
| OVERALL TOTAL PARKING SPACES | 25 | 25 |

| OVERALE TOTAL FARRING SEAGLS | 25 | 25 |
|---|----------|----------|
| (E) ACCESSIBLE SPACE REQUIREMENTS | REQUIRED | PROVIDED |
| REQUIRED ACCESSIBLE SPACES (CAR) | 0 | 1 |
| REQUIRED ACCESSIBLE SPACES (VAN) | 1 | 1 |
| TOTAL REQUIRED ACCESSIBLE SPACES (PER 2019 CBC SECTION 11B-208.2) | 1 | 2 |

FENCEING ONLY PROJECT ACCESSIBLE PATH OF TRAVEL

IN ACCORDANCE WITH DSA IR A-22, ITEM NO. 12, KEYNOTE 4, THE ACCESSIBLE PATH OF TRAVEL REVIEW SHALL BE LIMITED TO WHERE NEW FENCES AND GATES AFFECT/CROSS AN ACCESSIBLE PATH OF TRAVEL.

DSA PR-1501

"Design Professional in General Responsible Charge Statement:

The POT identified in these construction documents meets the requirements of the current applicable California Building Code (CBC) accessibility provisions for path of travel requirements for alterations, additions and structural repairs. As part of the design of this project, the POT was examined and any elements, components or portions of the POT that were determined to be noncompliant with the CBC have been identified and the corrective work necessary to bring them into compliance has been included within the scope of this project's work through details, drawings and specifications incorporated into these construction documents. Any noncompliant elements, components or portions of the POT that will not be corrected by this project based on valuation threshold limitations or a finding of unreasonable hardship are indicated in these construction documents.

During construction, if POT items within the scope of the project represented as CBC compliant are found to be nonconforming beyond reasonable construction tolerances, the items shall be brought into compliance with the CBC as a part of this project by means of a construction

ACCESSIBLE PATH OF TRAVEL (P.O.T.)

TO THE BEST OF THE KNOWLEDGE OF THE ARCHITECT AND/OR ENGINEER, OR THE DISTRICT, THE PATH OF TRAVEL (P.O.T.) AS INDICATED, IS A BARRIER FREE ACCESS ROUTE CONFORMING TO THE FOLLOWING:

- THERE ARE NO ABRUPT LEVEL CHANGES EXCEEDING 1/2" IF BEVELED AT 1V:2H MAX SLOPE, OR VERTICAL LEVEL CHANGES NOT EXCEEDING 1/4" MAX.
- THE MINIMUM WIDTH OF THE P.O.T. IS 48" AT ANY GIVEN POINT. (11B-403.5.1)
- THE SURFACE OF THE P.O.T. STABLE, FIRM, AND SLIP RESISTANT. (11B-403.2)
- THE MAXIMUM SLOPE IN THE DIRECTION OF TRAVEL IS 5.0% (11B-403.3), UNLESS OTHERWISE INDICATED, WITH THE FOLLOWING EXCEPTIONS:
- A. THE SLOPED PORTION OF "RAMP" DOES NOT EXCEED 8.33% (1V:12H) IN THE DIRECTION OF TRAVEL (11B-405.2).
- B. THE SLOPED PORTION OF A "CURB RAMP" DOES NOT EXCEED 8.33% (1V:12H) IN THE DIRECTION OF TRAVEL (11B-406.2.1 AND 11B-406.3.1).
- THE CROSS SLOPE OF THE ACCESSIBLE PATH OF TRAVEL DOES NOT EXCEED 2% AT ANY GIVEN POINT (11B-403.3).
- THE ACCESSIBLE PATH OF TRAVEL SHALL BE MAINTAINED FREE OF OVERHANGING OBSTRUCTIONS TO 80" MINIMUM (11B-307).
- THERE ARE NO PROTRUDING OBJECTS GREATER THAN 4" PROJECTION FROM WALL AND ABOVE 27" AND LESS THAN 80" (11B-307).
- PASSING SPACES AT LEAST 60"X60" ARE LOCATED NOT MORE THAT 200' APART. (11B-403.5.3) 9. PARTS OF P.O.T. WITH CONTINUOUS GRADIENTS HAVE 60" LEVEL AREAS NOT MORE THAN 400'
- APART. (11B-407.3) 10. THERE IS NO DROP-OFF OVER 4" AT THE EDGE OF WALK OR LANDING. (11B-303.5)
- . ARCHITECT AND CONTRACTOR SHALL VERIFY THAT ALL BARRIERS ON THE INDICATED PATH OF TRAVEL HAVE BEEN REMOVED.
- 12. THERE ARE NO GRATINGS WITHIN THE PATH OF TRAVEL WITH GRATE OPENINGS EXCEEDING 1/2" IN THE DIRECTION OF TRAVEL. (11B-302.3)

LEGEND

EXISTING BUILDING NOT MODERNIZED BY THIS APPLICATION. STORAGE CONTAINER / SHED

ACCESSIBLE PATH OF TRAVEL (P.O.T.) LIMIT/END OF PATH OF TRAVEL THIS PROJECT. —— PATH OF TRAVEL CONTINUATION INTO ACCESSIBLE

NEW CONCRETE WALKWAY (SEE SHEET C2.1)

EXISTING CONCRETE WALKWAY (SEE SHEET CO.1-CO.2 & C2.1)

SCOPE OF PROJECT — -- PROPERTY LINE

Know what's below.

---- ROAD CENTERLINE ST STORAGE, SHED/CONTAINER

ACCESSIBLE RESTROOM (PROJECT COMPLIANCE)


Call before you dig. THIS DRAWING MAY HAVE BEEN ENLARGED OR REDUCED.

1117 WINDFIELD WAY, SUITE 110 EL DORADO HILLS, CA 95762 | (916) 985-1870





Sacramento City **Unified School District** 5735 47th Avenue Sacramento, CA 95824-4528

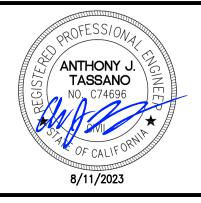

Isador Cohen **Elementary School** 2023 Fencing

9025 Salmon Falls Drive Sacramento, CA 95826

REVISIONS DESCRIPTION ADDENDUM NO.1


DRAWN: SCALE: AS NOTE PROJECT NO. CHECKED: 23-050 DESIGNED: SMN/AT 05/01/2023

SHEET TITLE:

ISSUANCE:

SITE ACCESS **PLAN**

C1.0.1

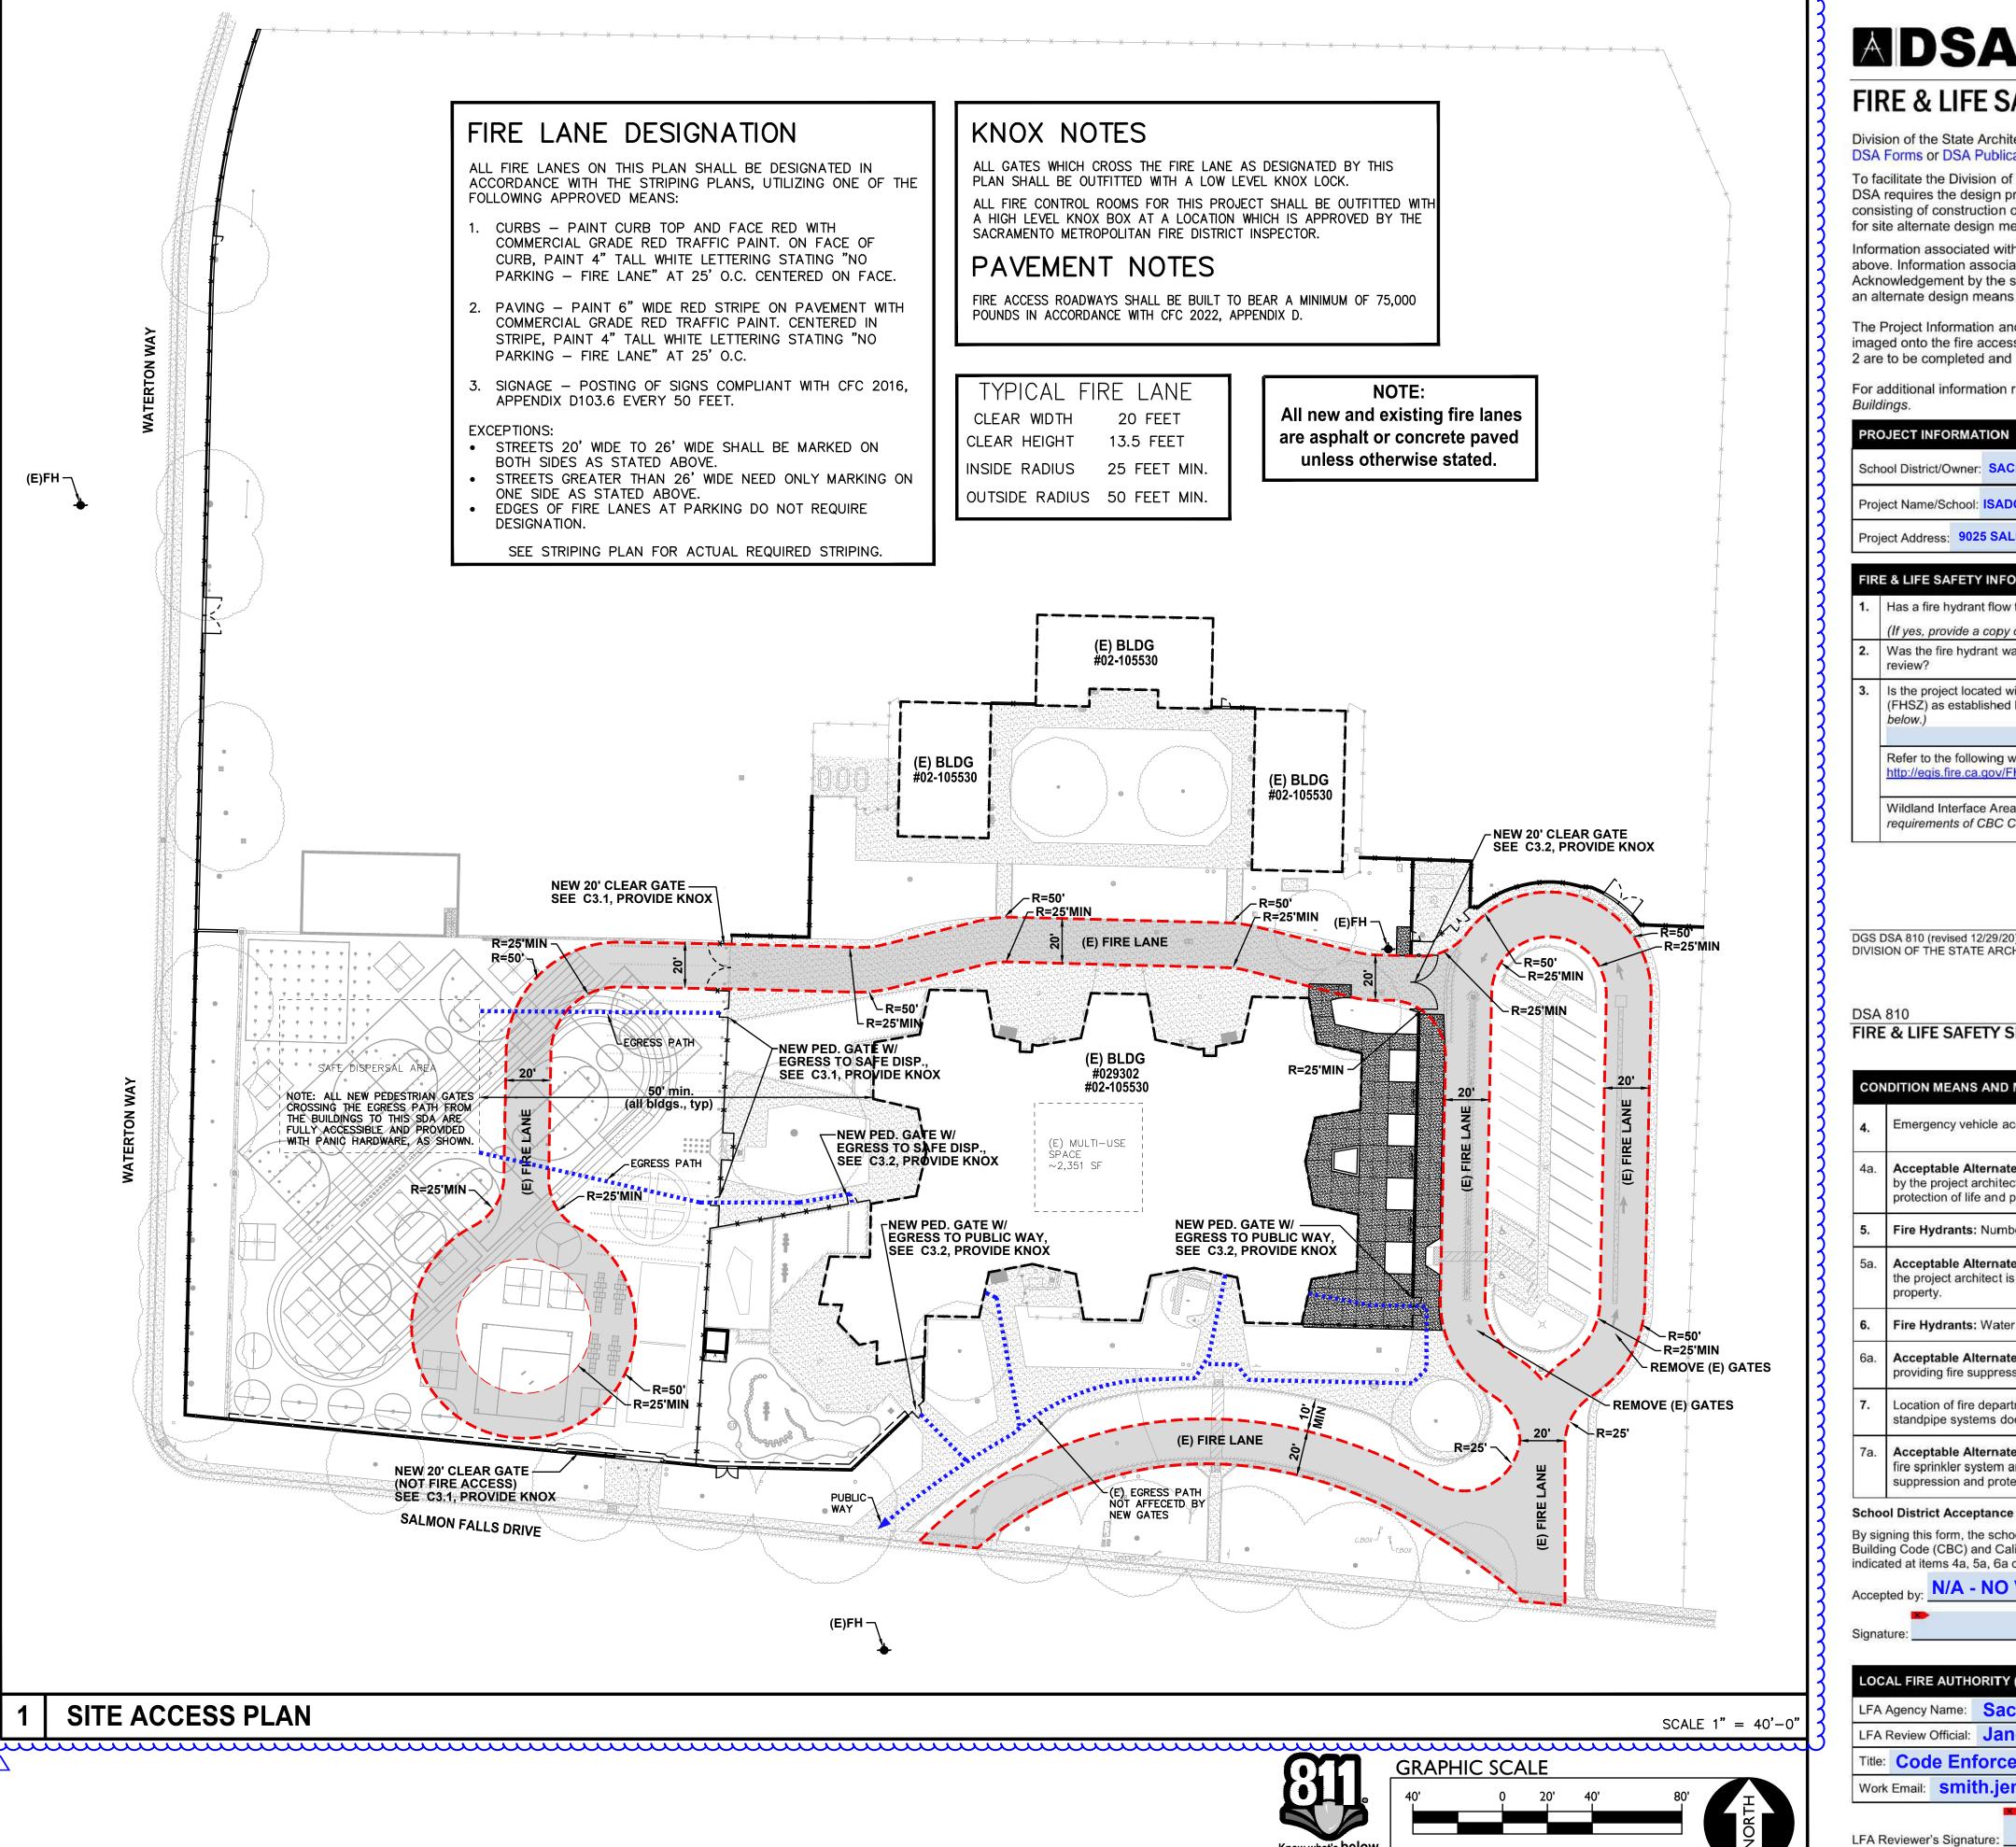

Know what's below. <u>Call</u> before you dig.

THIS DRAWING MAY HAVE BEEN ENLARGED OR REDUCED.

ADSA

FIRE & LIFE SAFETY SITE CONDITIONS SUBMITTAL


Division of the State Architect (DSA) documents referenced within this publication are available on the DSA Forms or DSA Publications webpages.

To facilitate the Division of the State Architect's (DSA) fire and life safety plan review of project site conditions, DSA requires the design professional to provide the following information at time of project submittal for projects consisting of construction of a new campus, construction of new building(s), additions to existing buildings, and for site alternate design means for fire department emergency vehicle access, and fire suppression water supply.

Information associated with compliance items 1 through 3 below is to be provided for all project types indicated above. Information associated with items 4 through 7 is to be completed when an alternate means is utilized. Acknowledgement by the school district and signature from the Local Fire Authority (LFA) is only required when an alternate design means is being requested.

The Project Information and Fire & Life Safety Information sections are to be completed for all projects and imaged onto the fire access site plan. When an alternate design/means is proposed, all sections on pages 1 and 2 are to be completed and imaged on the fire access site plan.

For additional information refer to the instructions at the end of this form and DSA Policy PL 09-01: Fire Flow for

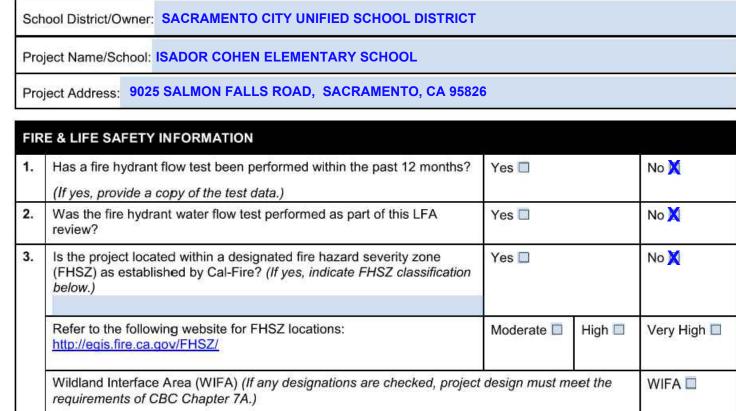

DGS DSA 810 (revised 12/29/20) Page 1 of 4 STATE OF CALIFORNIA DIVISION OF THE STATE ARCHITECT DEPARTMENT OF GENERAL SERVICES

FIRE & LIFE SAFETY SITE CONDITIONS SUBMITTAL

| CON | IDITION MEANS AND METHODS RESOLUTION | ALTE | RNATE | ACCEPT | ΞD |
|-----|--|------|-------|--------|----|
| 4. | Emergency vehicle access roadways do not meet CFC requirements. | Yes | No | N/A | N/ |
| 4a. | Acceptable Alternate: Emergency vehicle and personnel access as proposed by the project architect is acceptable for providing fire suppression and protection of life and property. | | | ^ | |
| 5. | Fire Hydrants: Number and spacing does not meet CFC requirements. | 2. | | X | |
| 5a. | Acceptable Alternate: Number of fire hydrants and spacing as proposed by the project architect is acceptable for fire suppression and protection of life and property. | | | | |
| 6. | Fire Hydrants: Water flow and pressure are less than CFC minimum. | ė | | X | |
| 6a. | Acceptable Alternate: The available flow and pressure is acceptable for providing fire suppression and protection of life and property. | | | | |
| 7. | Location of fire department connection(s) serving fire sprinkler systems or standpipe systems does not meet CFC requirements. | | | X | |
| 7a. | Acceptable Alternate: The location of fire department connection serving the fire sprinkler system and/or standpipe system is acceptable for providing fire suppression and protection of life and property. | | | | |

School District Acceptance of Acceptable Design Alternates

By signing this form, the school district acknowledges and accepts the proposed design as an alternative to California Building Code (CBC) and California Fire Code (CFC) minimum requirements, as indicated by one or more of the conditions indicated at items 4a, 5a, 6a or 7a, for providing fire and life safety protection of life and property.

N/A - NO VARIANCE PROPOSED Signature:

| LFA Agency Name | Sacramento Metro Fire | | |
|--------------------|----------------------------|-------------|----------------|
| LFA Review Officia | Janea Smith | | |
| Title: Code El | nforcement Supevisor | Work Phone: | (916) 859-4319 |
| Work Email: SM | ith.jenae@metrofire.ca.gov | | |


DGS DSA 810 (revised 12/29/20) Page 2 of 4 STATE OF CALIFORNIA DIVISION OF THE STATE ARCHITECT DEPARTMENT OF GENERAL SERVICES

1117 WINDFIELD WAY, SUITE 110 EL DORADO HILLS, CA 95762 | (916) 985-1870

OWNER:



Sacramento City **Unified School District** 5735 47th Avenue Sacramento, CA 95824-4528

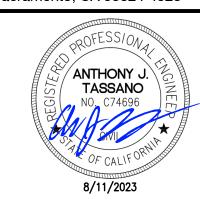

Isador Cohen **Elementary School** 2023 Fencing

9025 Salmon Falls Drive Sacramento, CA 95826

REVISIONS DESCRIPTION ADDENDUM NO.1

DRAWN: SCALE: AS NOTE CHECKED: PROJECT NO. 23-050 DESIGNED: 05/01/2023


SHEET TITLE:

ISSUANCE:

FIRE ACCESS **PLAN**

SHEET NO.

C1.0.2

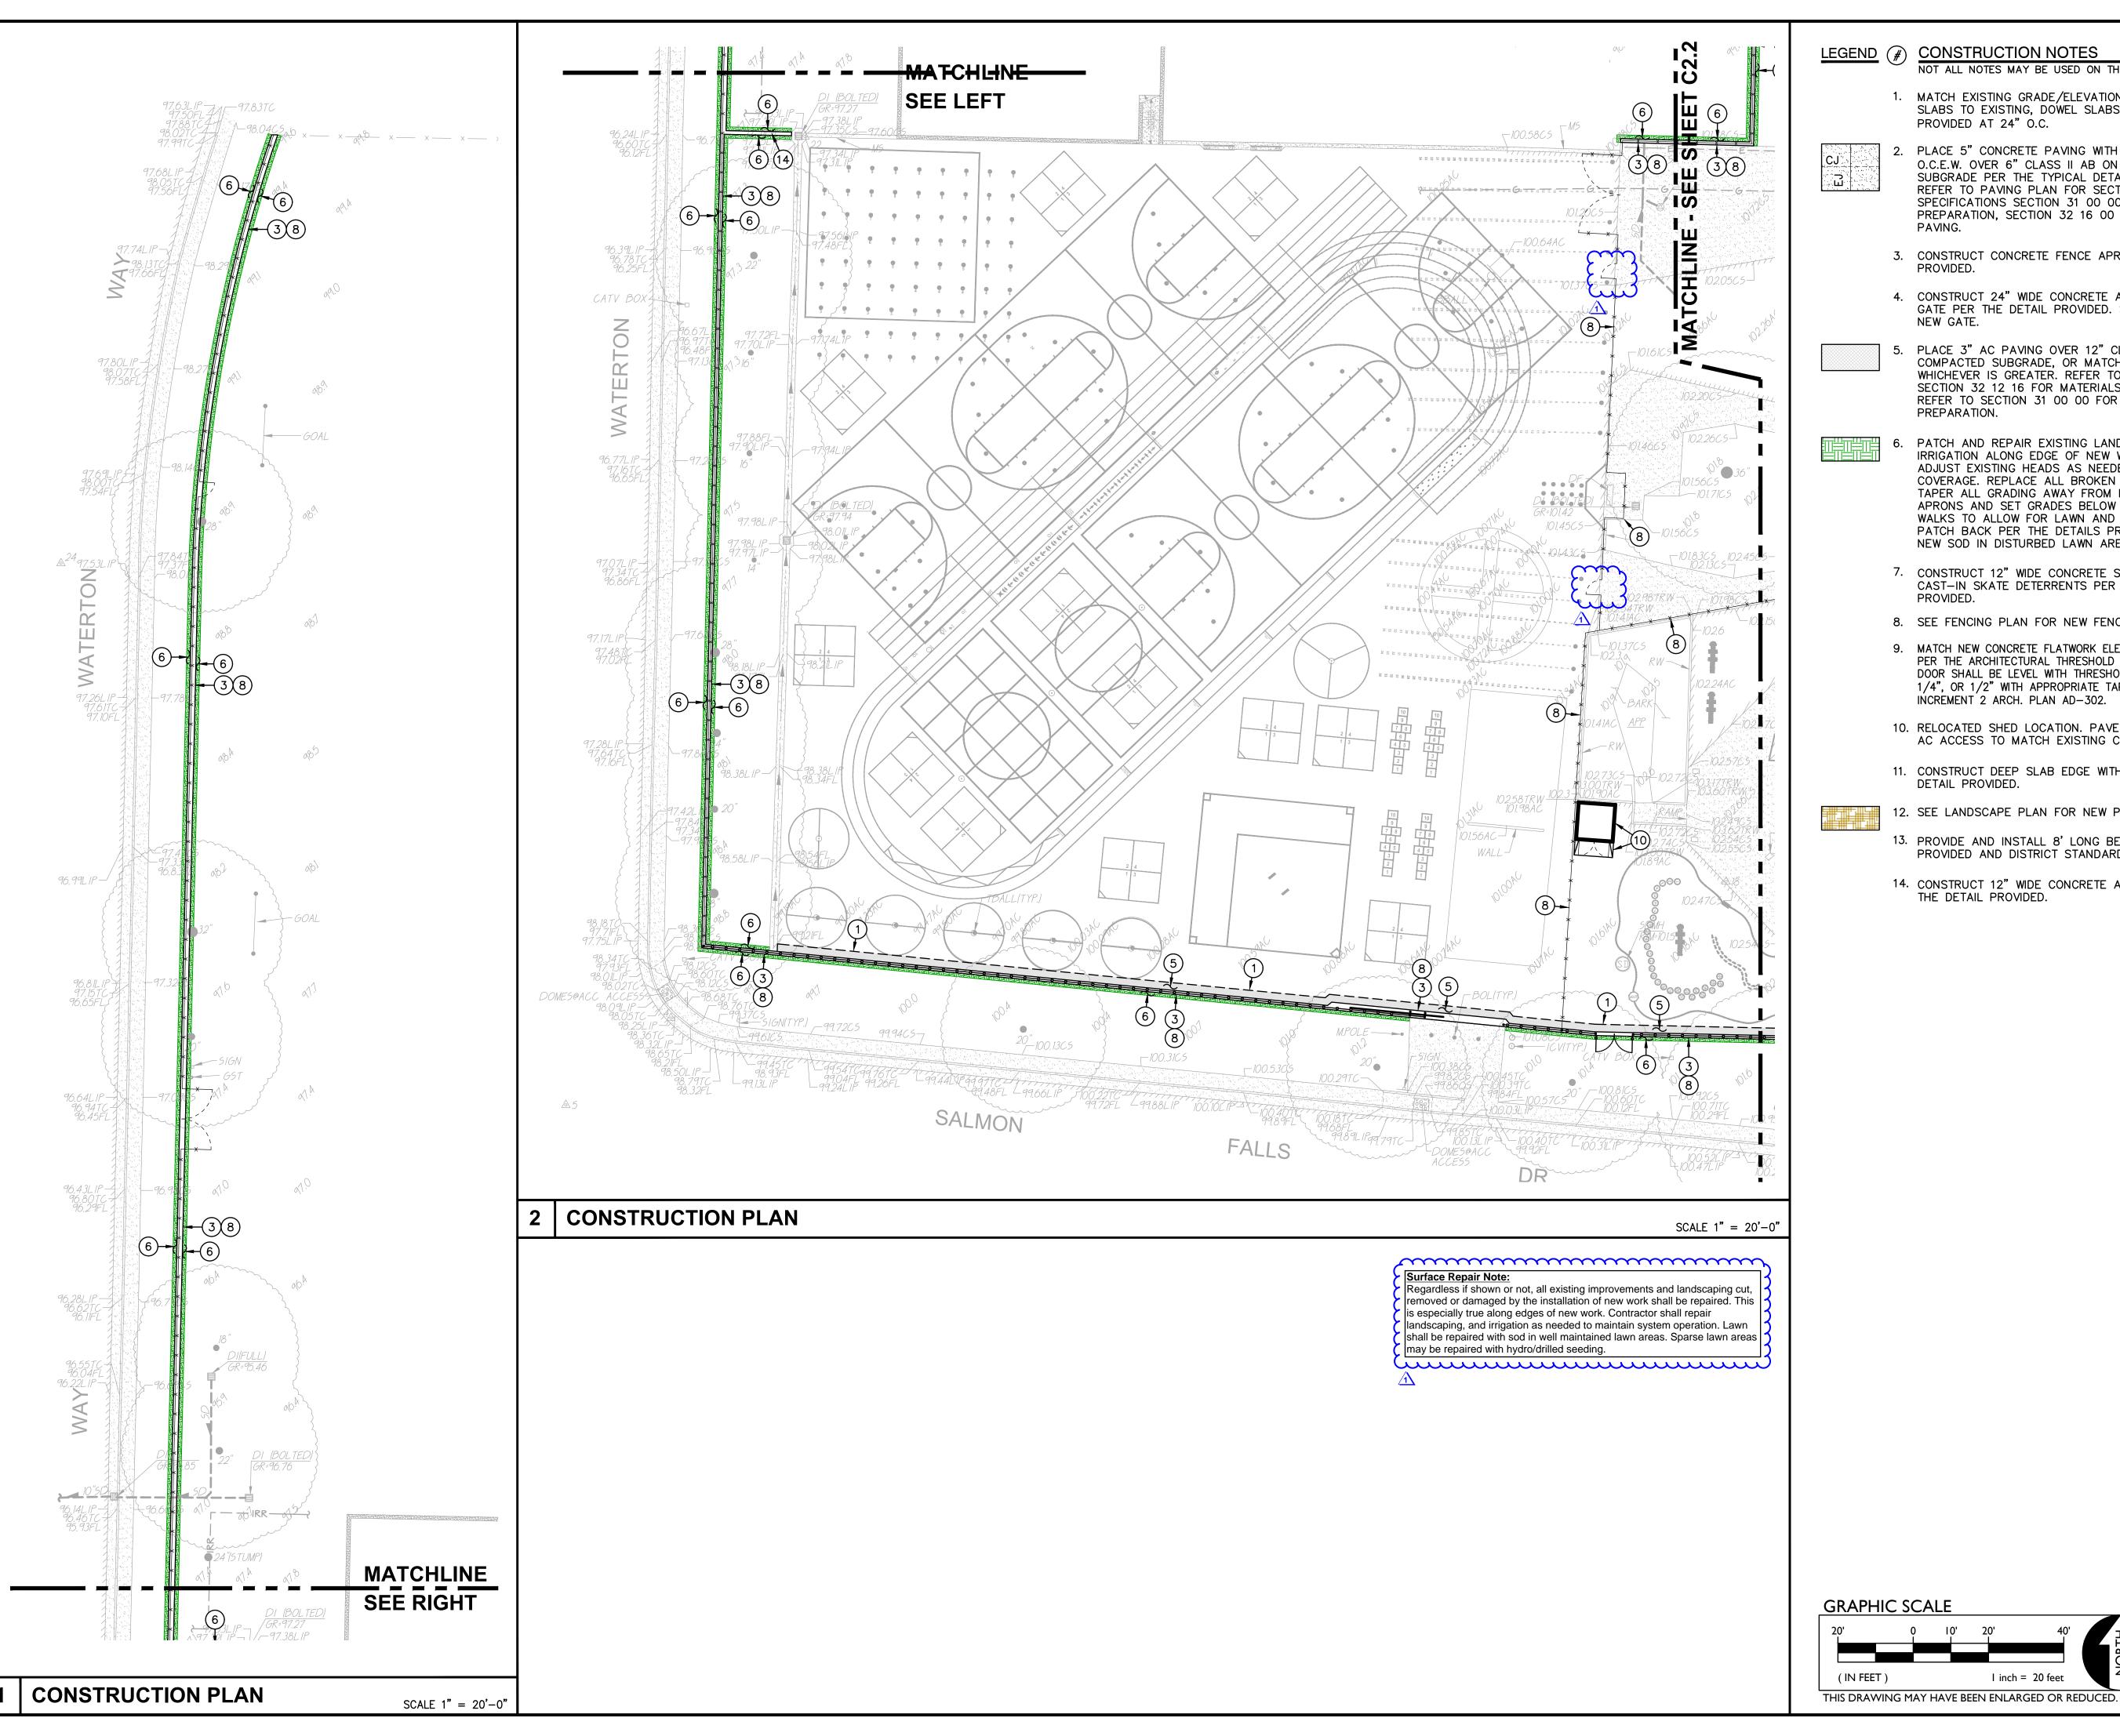


LEGEND (#) CONSTRUCTION NOTES

NOT ALL NOTES MAY BE USED ON THIS SHEET


1. MATCH EXISTING GRADE/ELEVATION. WHEN MATCHING NEW SLABS TO EXISTING, DOWEL SLABS PER THE DETAIL PROVIDED AT 24" O.C.

PLACE 5" CONCRETE PAVING WITH #4 REBAR AT 24"

O.C.E.W. OVER 6" CLASS II AB ON COMPACTED
SUBGRADE PER THE TYPICAL DETAILS PROVIDED.
REFER TO PAVING PLAN FOR SECTIONS. REFER TO
SPECIFICATIONS SECTION 32 16 OD FOR CONCRETE PREPARATION, SECTION 32 16 00 FOR CONCRETE

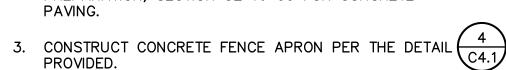

4. CONSTRUCT 24" WIDE CONCRETE APRON AT NEW ROLLING 7
GATE PER THE DETAIL PROVIDED. SEE FENCING PLAN FOR C4.1 NEW GATE.

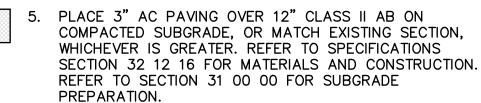

PATCH AND REPAIR EXISTING LANDSCAPING AND IRRIGATION ALONG EDGE OF NEW WORK. RELOCATE AND 2 ADJUST EXISTING HEADS AS NEEDED TO MAINTAIN COVERAGE. REPLACE ALL BROKEN HEADS RELOCATED. TAPER ALL GRADING AWAY FROM NEW CURBS AND APRONS AND SET GRADES BELOW APRONS, CURBS AND WALKS TO ALLOW FOR LAWN AND OTHER PLANTING PATCH BACK PER THE DETAILS PROVIDED. PROVIDE NEW SOD IN DISTURBED LAWN AREAS.



8. SEE FENCING PLAN FOR NEW FENCING AND GATES.

9. MATCH NEW CONCRETE FLATWORK ELEVATION TO DOORWAY THRESHOLD PER THE ARCHITECTURAL THRESHOLD DETAILS. LANDING EACH SIDE OF DOOR SHALL BE LEVEL WITH THRESHOLD TRANSITION NOT EXCEEDING 1/4", OR 1/2" WITH APPROPRIATE TAPER PER 11B-303. SEE INCREMENT 2 ARCH. PLAN AD-302.

10. RELOCATED SHED LOCATION. PAVE SURFACE APPLIED TOPEKA AC ACCESS TO MATCH EXISTING CONDITIONS.

11. CONSTRUCT DEEP SLAB EDGE WITH FENCING PER THE (C4.1)



12. SEE LANDSCAPE PLAN FOR NEW PLANTING.

13. PROVIDE AND INSTALL 8' LONG BENCH PER THE DETAIL C4.1 PROVIDED AND DISTRICT STANDARD SPECIFICATIONS.

14. CONSTRUCT 12" WIDE CONCRETE APRON (NO FENCE) PER (4.1) SIM THE DETAIL PROVIDED.



OWNER:



EL DORADO HILLS, CA 95762 | (916) 985-1870

Sacramento City **Unified School District** 5735 47th Avenue Sacramento, CA 95824-4528



Isador Cohen Elementary School 2023 Fencing

9025 Salmon Falls Drive Sacramento, CA 95826

| REVISIONS |
|---------------|
| DESCRIPTION |
| ADDENDUM NO.1 |
| |

| DRAWN: | SCALE: |
|-----------|-------------|
| SMN | AS NOTED |
| CHECKED: | PROJECT NO. |
| AT | 23-050 |
| DESIGNED: | DATE: |
| SMN/AT | 05/01/2023 |

SHEET TITLE:

ISSUANCE:

GRADING


PLAN


SHEET NO.

Know what's below.

<u>Call</u> before you dig.

C2.1

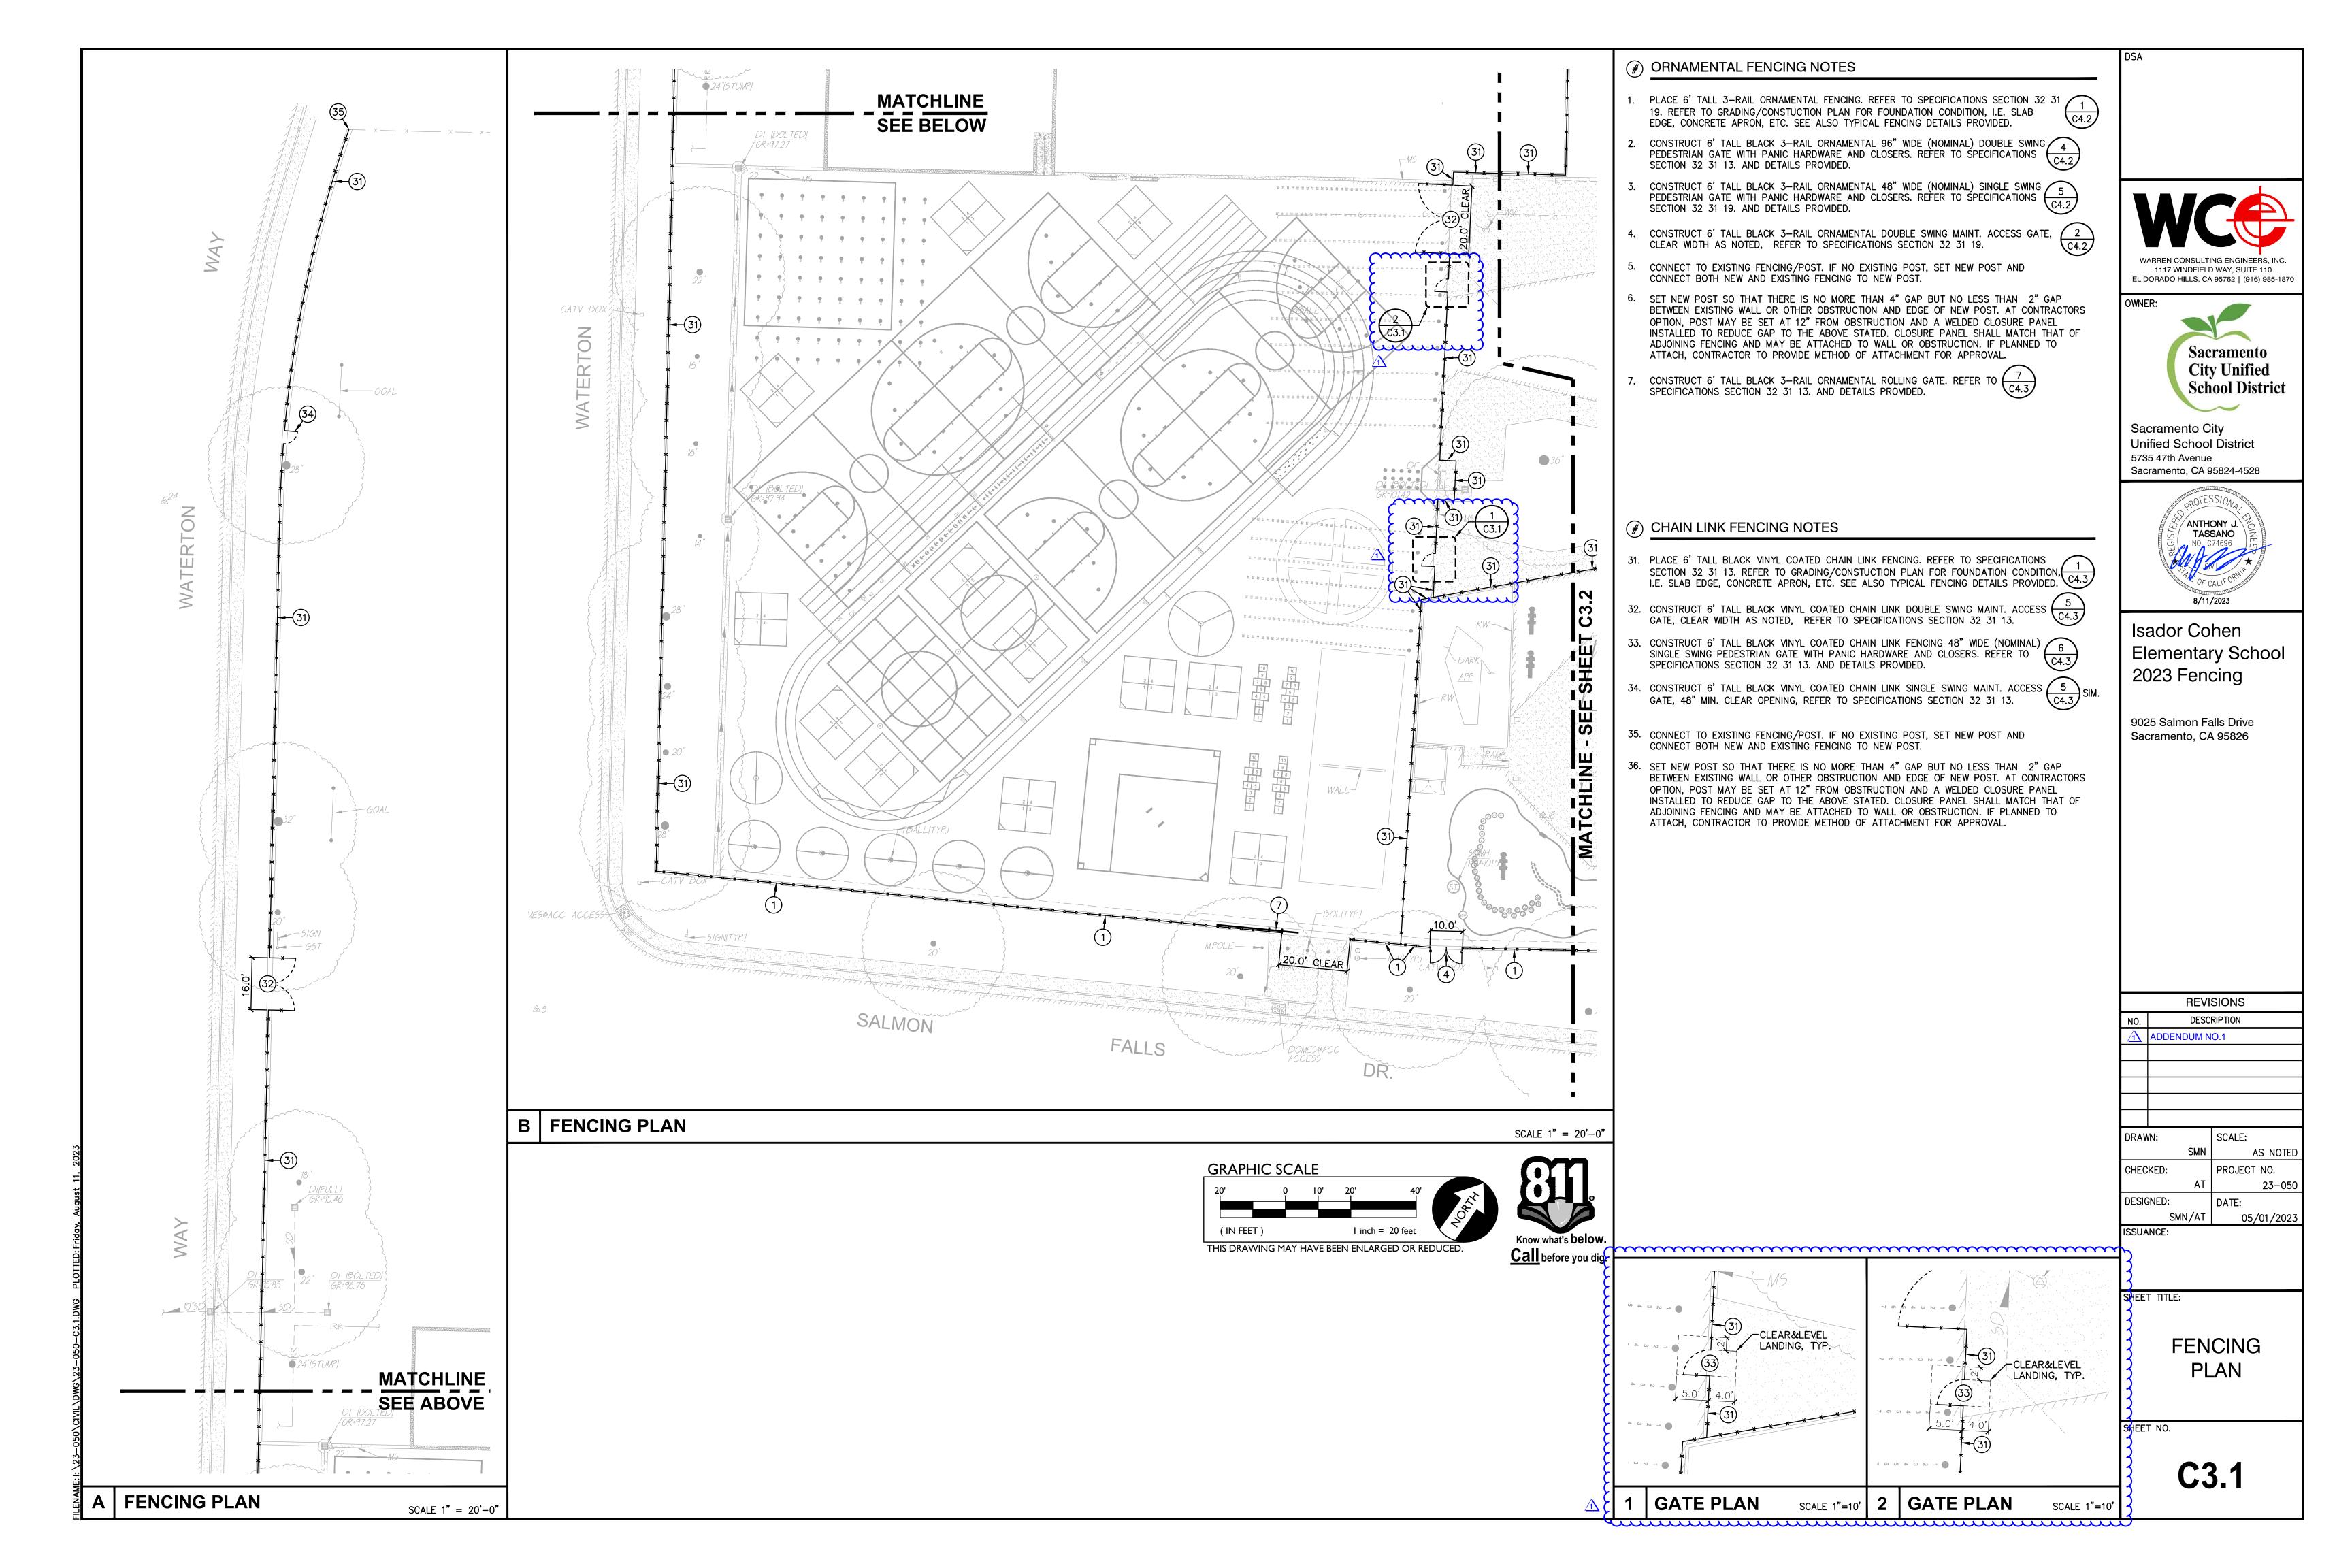

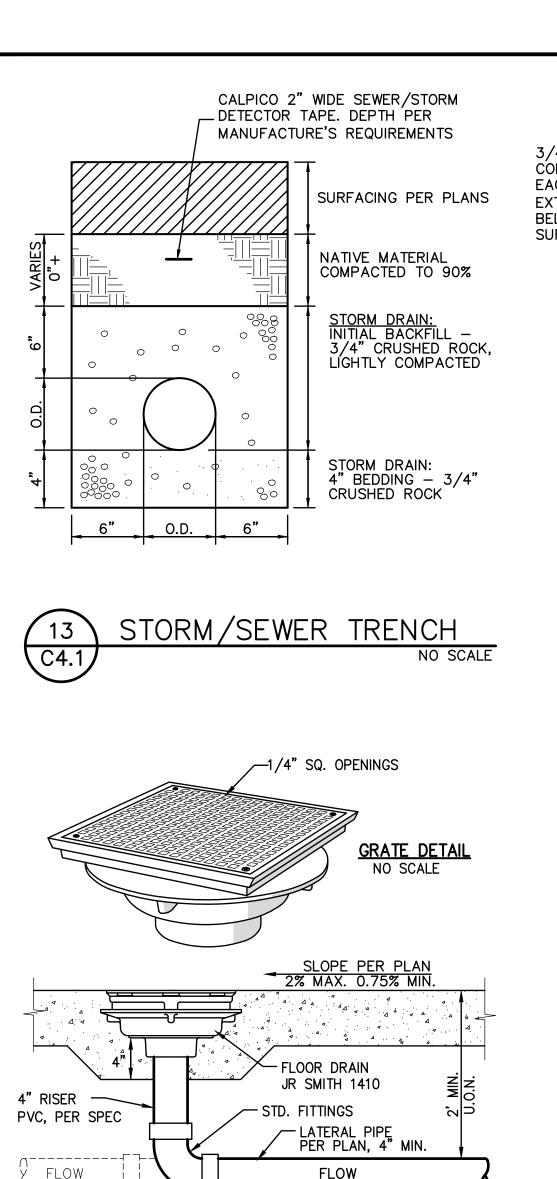

FLOOR DRAIN

NO SCALE

— 4" OR 6" ATRIUM GRATE PER PLAN, OR APPROVED EQUAL.

└─(1) 1/8"x1/2" SS SCREW

NECESSARY

—BEDDING

MATERIAL

FLOW

NO SCALE

C4.1

4" OR 6" PVC RISER, MATCH GRATE SIZE, SDR-35.

PLANTER DRAIN

C4.1

PER PLAN


GRATE ELEVATION —


FITTINGS AS-

MATERIAL


FLOW

C4.1 / 4" AND 6", SIZE PER PLAN

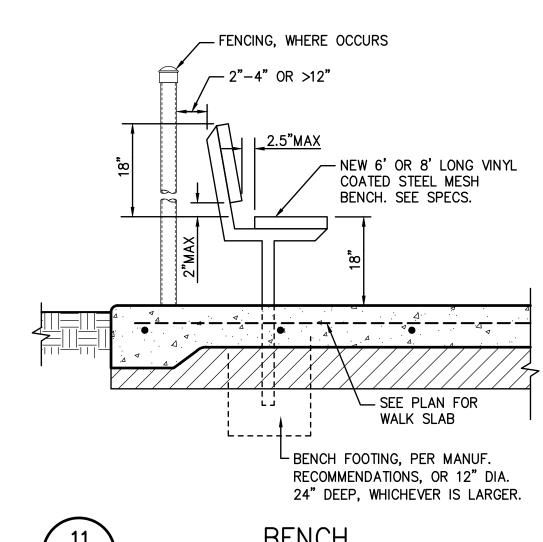

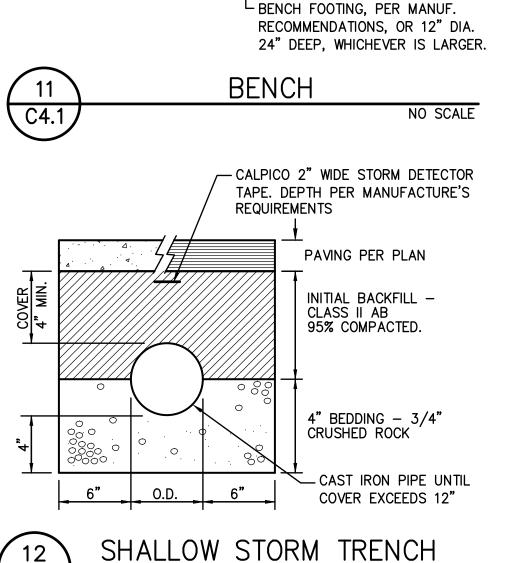

4" AND 6" STORM DRAINS ONLY.

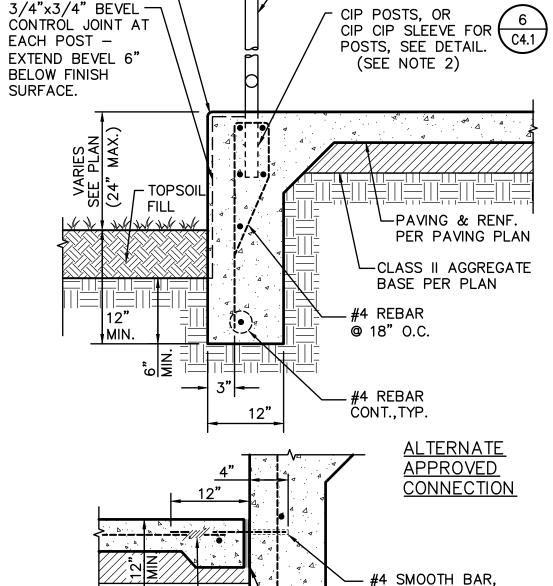

3/4" R—

STD. TIE OR —

CONT. REBAR

(N) WALKWAY/RAMP RAIL OR

DRILL & EPOXY WITH

HILTI HIT HY150 OR

APPROVED EQUAL.


FENCE WHERE OCCURS. IF


RAILING, SEE ARCH. PLANS

NOTES:

1. CONCRETE WALK JOINTS SHALL EXTEND OVER AND DOWN THE FACE OF SLAB EDGE. 2. CORE DRILLING HOLES FOR POSTS AFTER CONCRETE INSTALLATION IS ACCEPTABLE AT SELECT LOCATIONS ONLY (PER C6.1) PROVIDED ALL DIMENSIONAL CRITERIA IS FOLLOWED PER 6/C8.2. CONTRACTOR SHALL COORDINATE REBAR LOCATION SO THAT IT WILL NOT BE CUT WHEN CORING.

RETAINING CURB EDGE NO SCALE WITH FENCE/RAILING

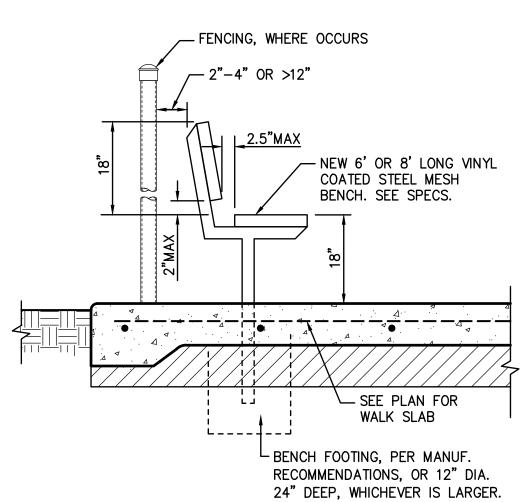

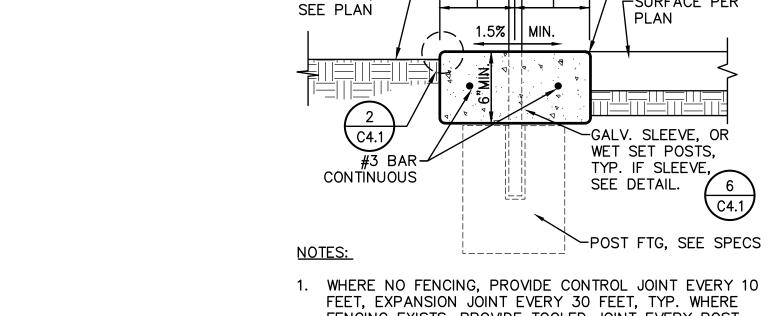

NOT USED

WIDTH "W" VARIES, —

SEE PLAN

GROOVES ON TOP

´9 ANTI SKATE ─

3/4"CHAMFER, —

TYP., SEE DETAIL

BITUTHENE 3000 OVER-

BITUTHENE WP-3000

EQUAL.

WALK-PLANTER CONDITION

ANTI SKATE GROOVES

ANTI SKATE GROOVES

C4.1

NO SCALE

PROVIDE ARDEX TWP ON ALL EXPOSED SEATWALL SURFACE

CONCRETE SEATWAL

5 EVERY 4TH GROOVE

3/4" CHAMBER AT ALL OTHER CORNERS.

5 EVERY 4TH GROOVE

C4.1 (12' O.C.)

SKATEBOARDING DETERRENT

CONCRETE SEAT WALL. SEE

GROOVES IN TOP OF

DETAIL ABOVE.

3/4" CHAMBER AT ALL

ANTI SKATE GROOVES

OTHER CORNERS.

C4.1 (12' O.C.)

PRIMER, OR APPROVED

VARIES 2"-6"

NO SCALE

TO EITHER SIDE.

- SEE PLAN 18"(±2")

- #4 REBAR

C4.1

12" AT LAWN -

LANDSCAPING/

PLANTING,

6"@ PAVING/MULCH

FEET. EXPANSION JOINT EVERY 30 FEET, TYP. WHERE FENCING EXISTS, PROVIDE TOOLED JOINT EVERY POST, EXPANSION EVERY 3RD POST.

(N) FENCE, WHERE

SPECS


OCCURS, SEE PLAN AND


-TOOLED EDGE

-SURFACE PER

2. CONCRETE APRON THICKNESS MAY COUNT FOR POST FOOTING TOTAL DEPTH BUT MUST BE PLACED BEFORE FABRIC OR PANEL INSTALLATION.




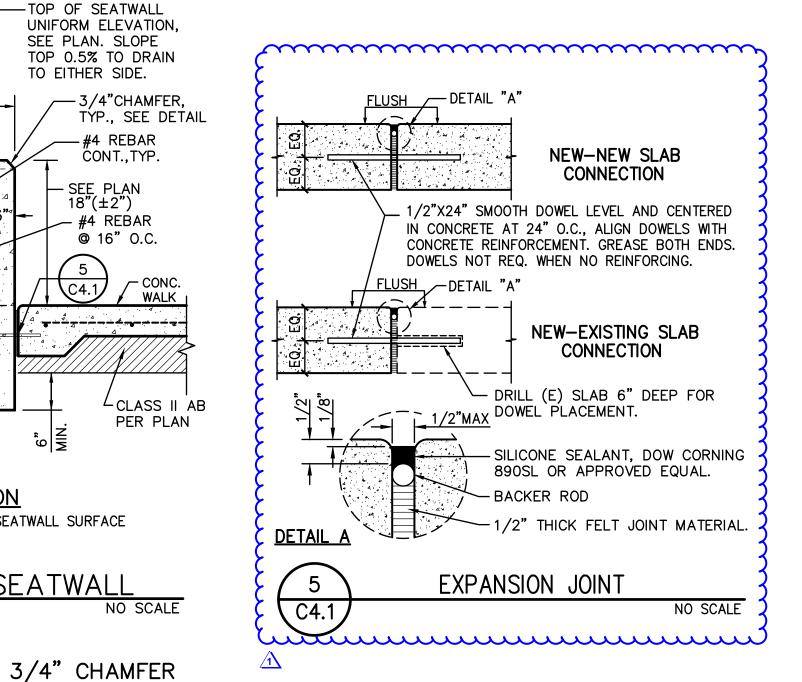

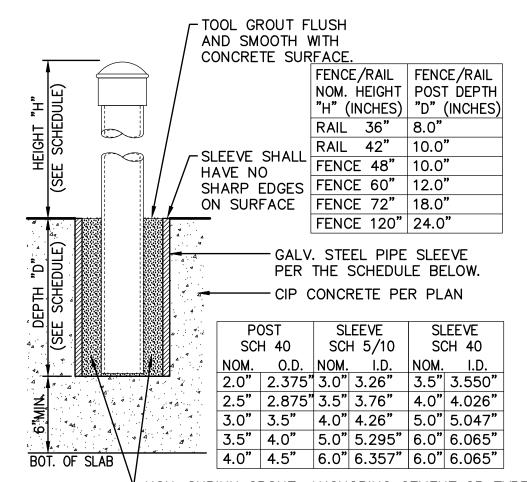


NON-SHRINK GROUT, ANCHORING CEMENT OR TYPE F MORTAR, ACCEPTABLE AS FOLLOWS: I. SAKCRETE NON-SHRINK PRECISION GROUT. 2. W.R. MEADOWS SPEED-E-ROC. 3. QUICKRETE NON-SHRINK PRECISION GROUT 4. DAYTON SUPERIOR, ANCHOR-ALL 5. APPROVED EQUAL.




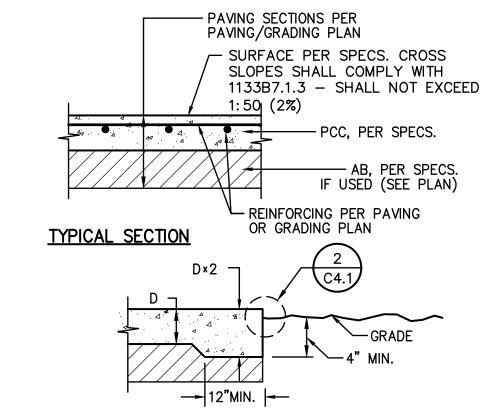




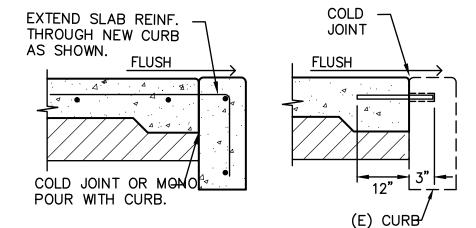


TYPICAL EXPANSION JOINT AT CURB

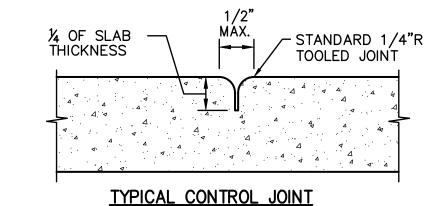

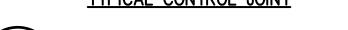



CONCRETE SIDEWALK

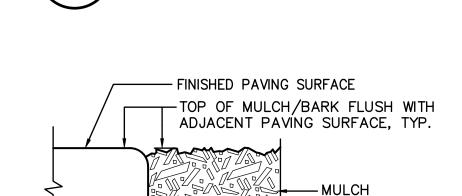

PLANTING AREA

C4.1

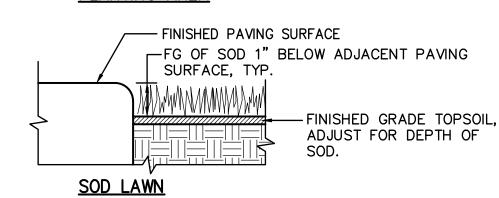

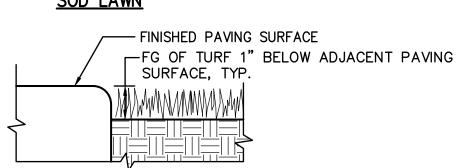

GATE APRON

1117 WINDFIELD WAY, SUITE 110 EL DORADO HILLS, CA 95762 | (916) 985-1870

OWNER:

Sacramento City **Unified School District** 5735 47th Avenue

Sacramento

City Unified

School District



Isador Cohen Elementary School 2023 Fencing

9025 Salmon Falls Drive Sacramento, CA 95826

| | REVISIONS |
|----|---------------|
| Ο. | DESCRIPTION |
| 7 | ADDENDUM NO.1 |
| | |

| DRAWN: | SCALE: |
|-----------|-------------|
| SMN | AS NOTED |
| CHECKED: | PROJECT NO. |
| AT | 23-050 |
| DESIGNED: | DATE: |
| SMN/AT | 05/01/2023 |
| SCHANCE: | |

SHEET TITLE:

DETAILS AND SECTIONS

SHEET NO.

NO SCALE

C4.1

SEED LAWN PAVING EDGE DETAIL C4.1 NO SCALE

ROSEMONT HIGH SCHOOL 2023 FENCING

9594 Kiefer Blvd. Sacramento, CA 95827



PROJECT TEAM

CIVIL:


WARREN CONSULTING ENGINEERS. INC.

1117 WINDFIELD WAY, SUITE 110

EL DORADO HILLS, CA 95762 PHONE: (916) 985-1870

FAX: (916) 985-1877



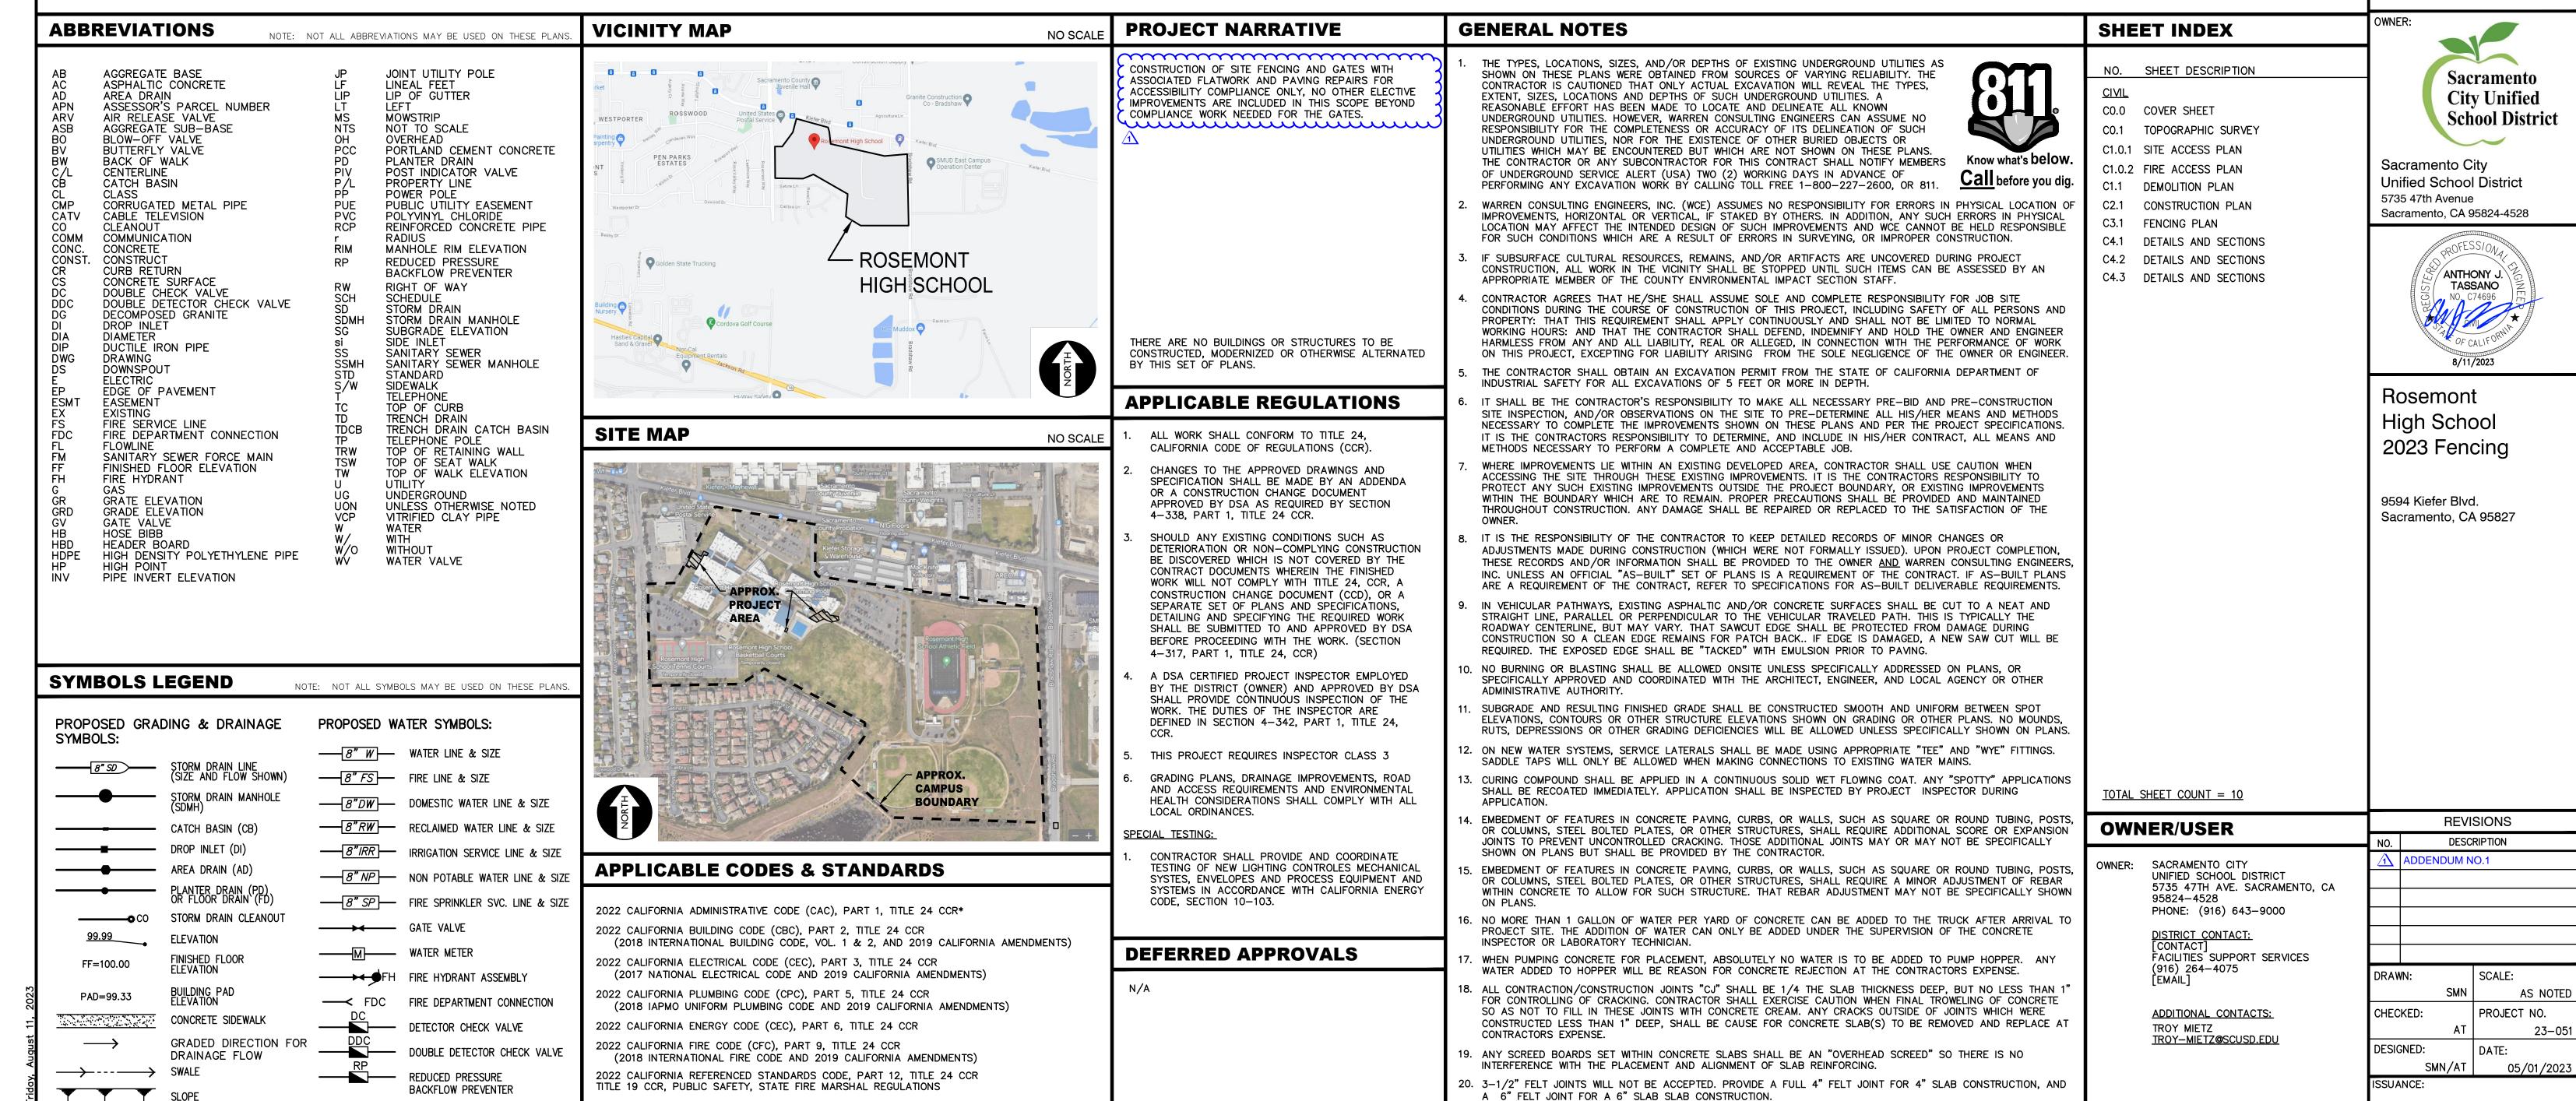

STATEMENTS:

. SHOULD ANY SHRINKAGE CRACKS OCCUR OUTSIDE OF EITHER THE EXPANSION JOINTS OR CRACK CONTROL

EXISTING CONCRETE PER DRAWING DETAIL.

GENERAL PAVING SURFACE NOTES:

CONCRETE SHALL MEET THE FOLLOWING SLOPE REQUIREMENTS:

NO GREATER THAN 2% SLOPE CROSSING THE DIRECTION OF TRAVEL.

NO GREATER THAN 2% SLOPE IN ANY DIRECTION IN COURTYARD OR PLAZA AREAS.

- NO GREATER THAN 5% SLOPE IN THE DIRECTION OF TRAVEL.

BE ALLOWED.

JOINTS, THEN THE CONCRETE SLAB SHALL BE SAWCUT AT THE NEAREST JOINTS ON EACH SIDE OF THE CRACK

AND THE CONCRETE SECTION SHALL BE, REMOVED AND REPLACED. NEW CONCRETE SHALL BE DOWELED INTO

22. ALL AREAS DISTURBED BY GRADING OPERATIONS WHETHER SHOWN ON THE DRAWINGS OR NOT SHALL BE HYDRO

SEEDED UNLESS OTHERWISE NOTED. HYDRO SEEDING SHALL CONFORM TO LOCAL CITY/COUNTY STANDARDS.

23. REPAIR OR PATCHING OF GALVANIZED METALS, SUCH AS AFTER WELDING GALVANIZED COMPONENTS, SHALL BE

PROVIDE EQUIVALENT OF MEDIUM BROOM FINISH AT SLOPES UP TO 5.99%, TYPICAL. PROVIDE

NO LESS THAN 0.75% IN ANY DIRECTION, UNLESS SPECIFICALLY LABELED OTHERWISE. ALL

EQUIVALENT OF HEAVY BROOM FINISH AT SLOPES 6% AND GREATER. REFER TO SPECIFICATIONS.

ALL NEW PEDESTRIAN WALKWAYS (NON-RAMP) SHALL BE SLOPED NO GREATER THAN 2.0%, AND

MADE USING A ZINC COMPOSITION "HOT STICK" APPLICATION PER ASTM A 780-01. GALVANIZING PAINTS WILL NOT

2022 CALIFORNIA ENERGY CODE (CGC), Part 11, Title 24 CCR.

BUTTERFLY VALVE

POST INDICATOR VALVE

AIR RELEASE VALVE + SIZE

BLOW-OFF VALVE + SIZE

TREE TO BE REMOVED

OVERLAND RELEASE PATH

(SIZE AND FLOW SHOWN)

SANITARY SEWER

MANHOLE (SSMH)

SEWER CLEANOU?

FLUSHER BRANCH

TREE TO REMAIN


RETAINING WALL


PROPOSED SANITARY SEWER SYMBOLS:

6" SS SANITARY SEWER LINE

C0.0

COVER SHEET

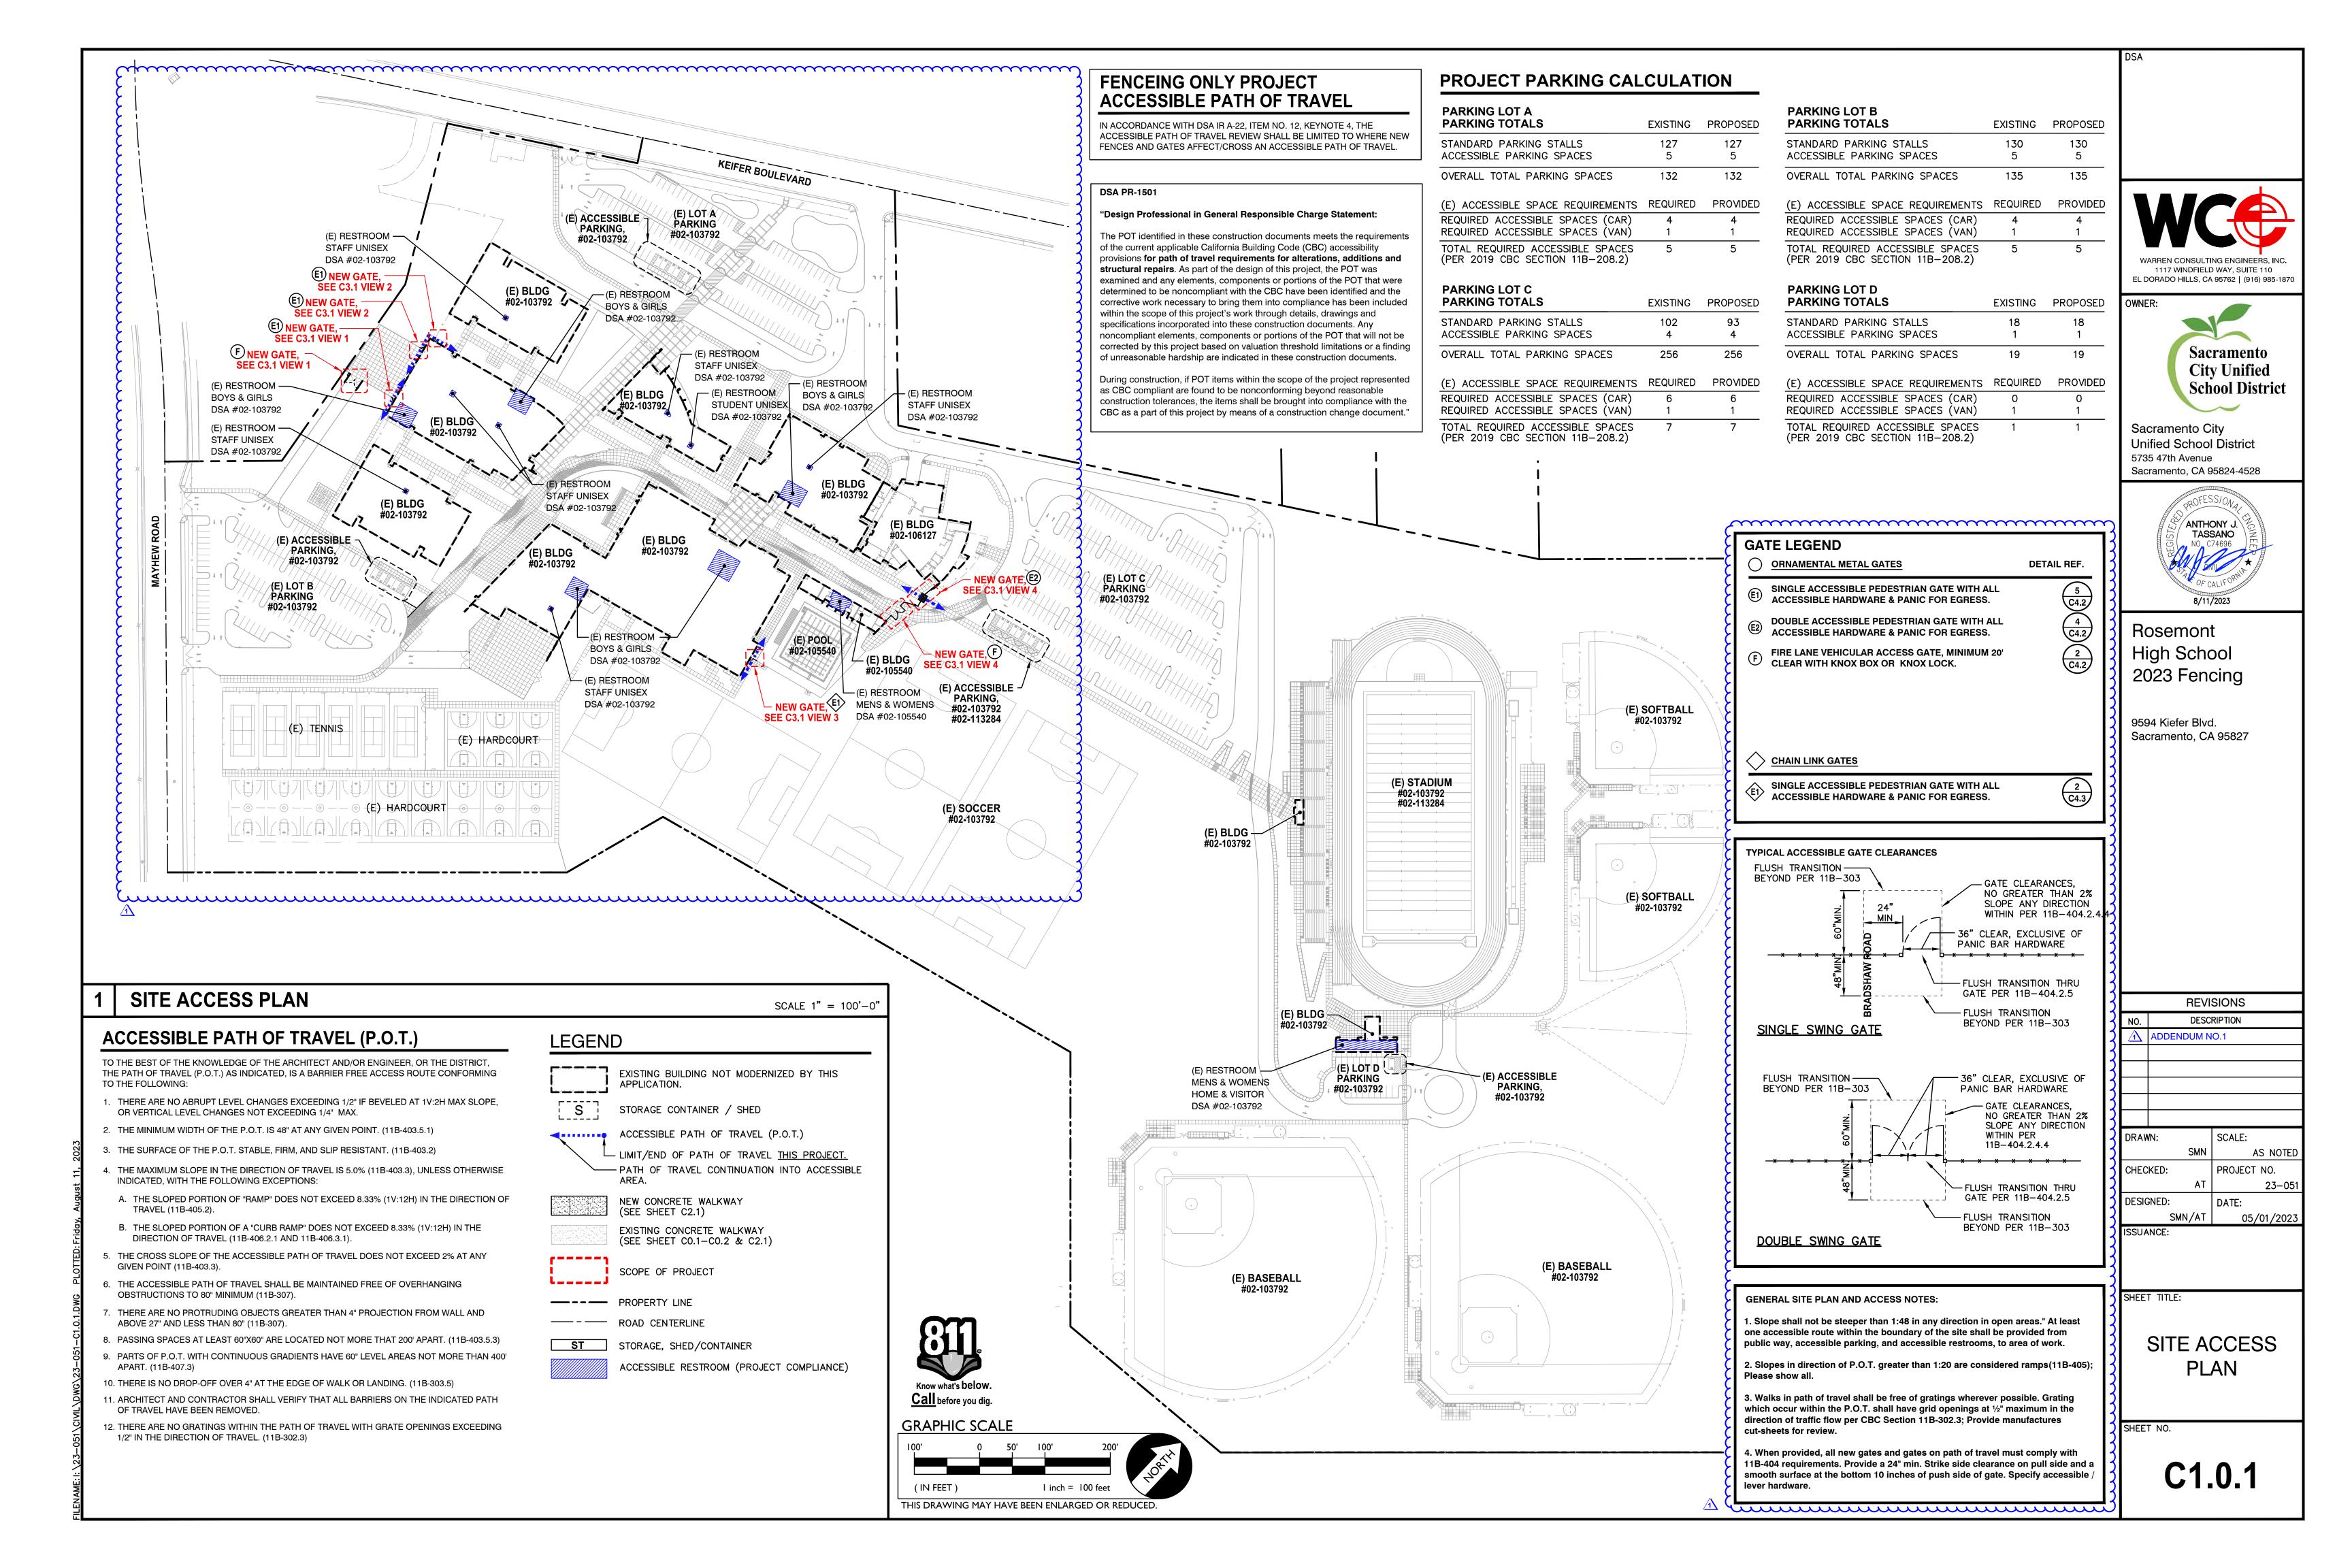

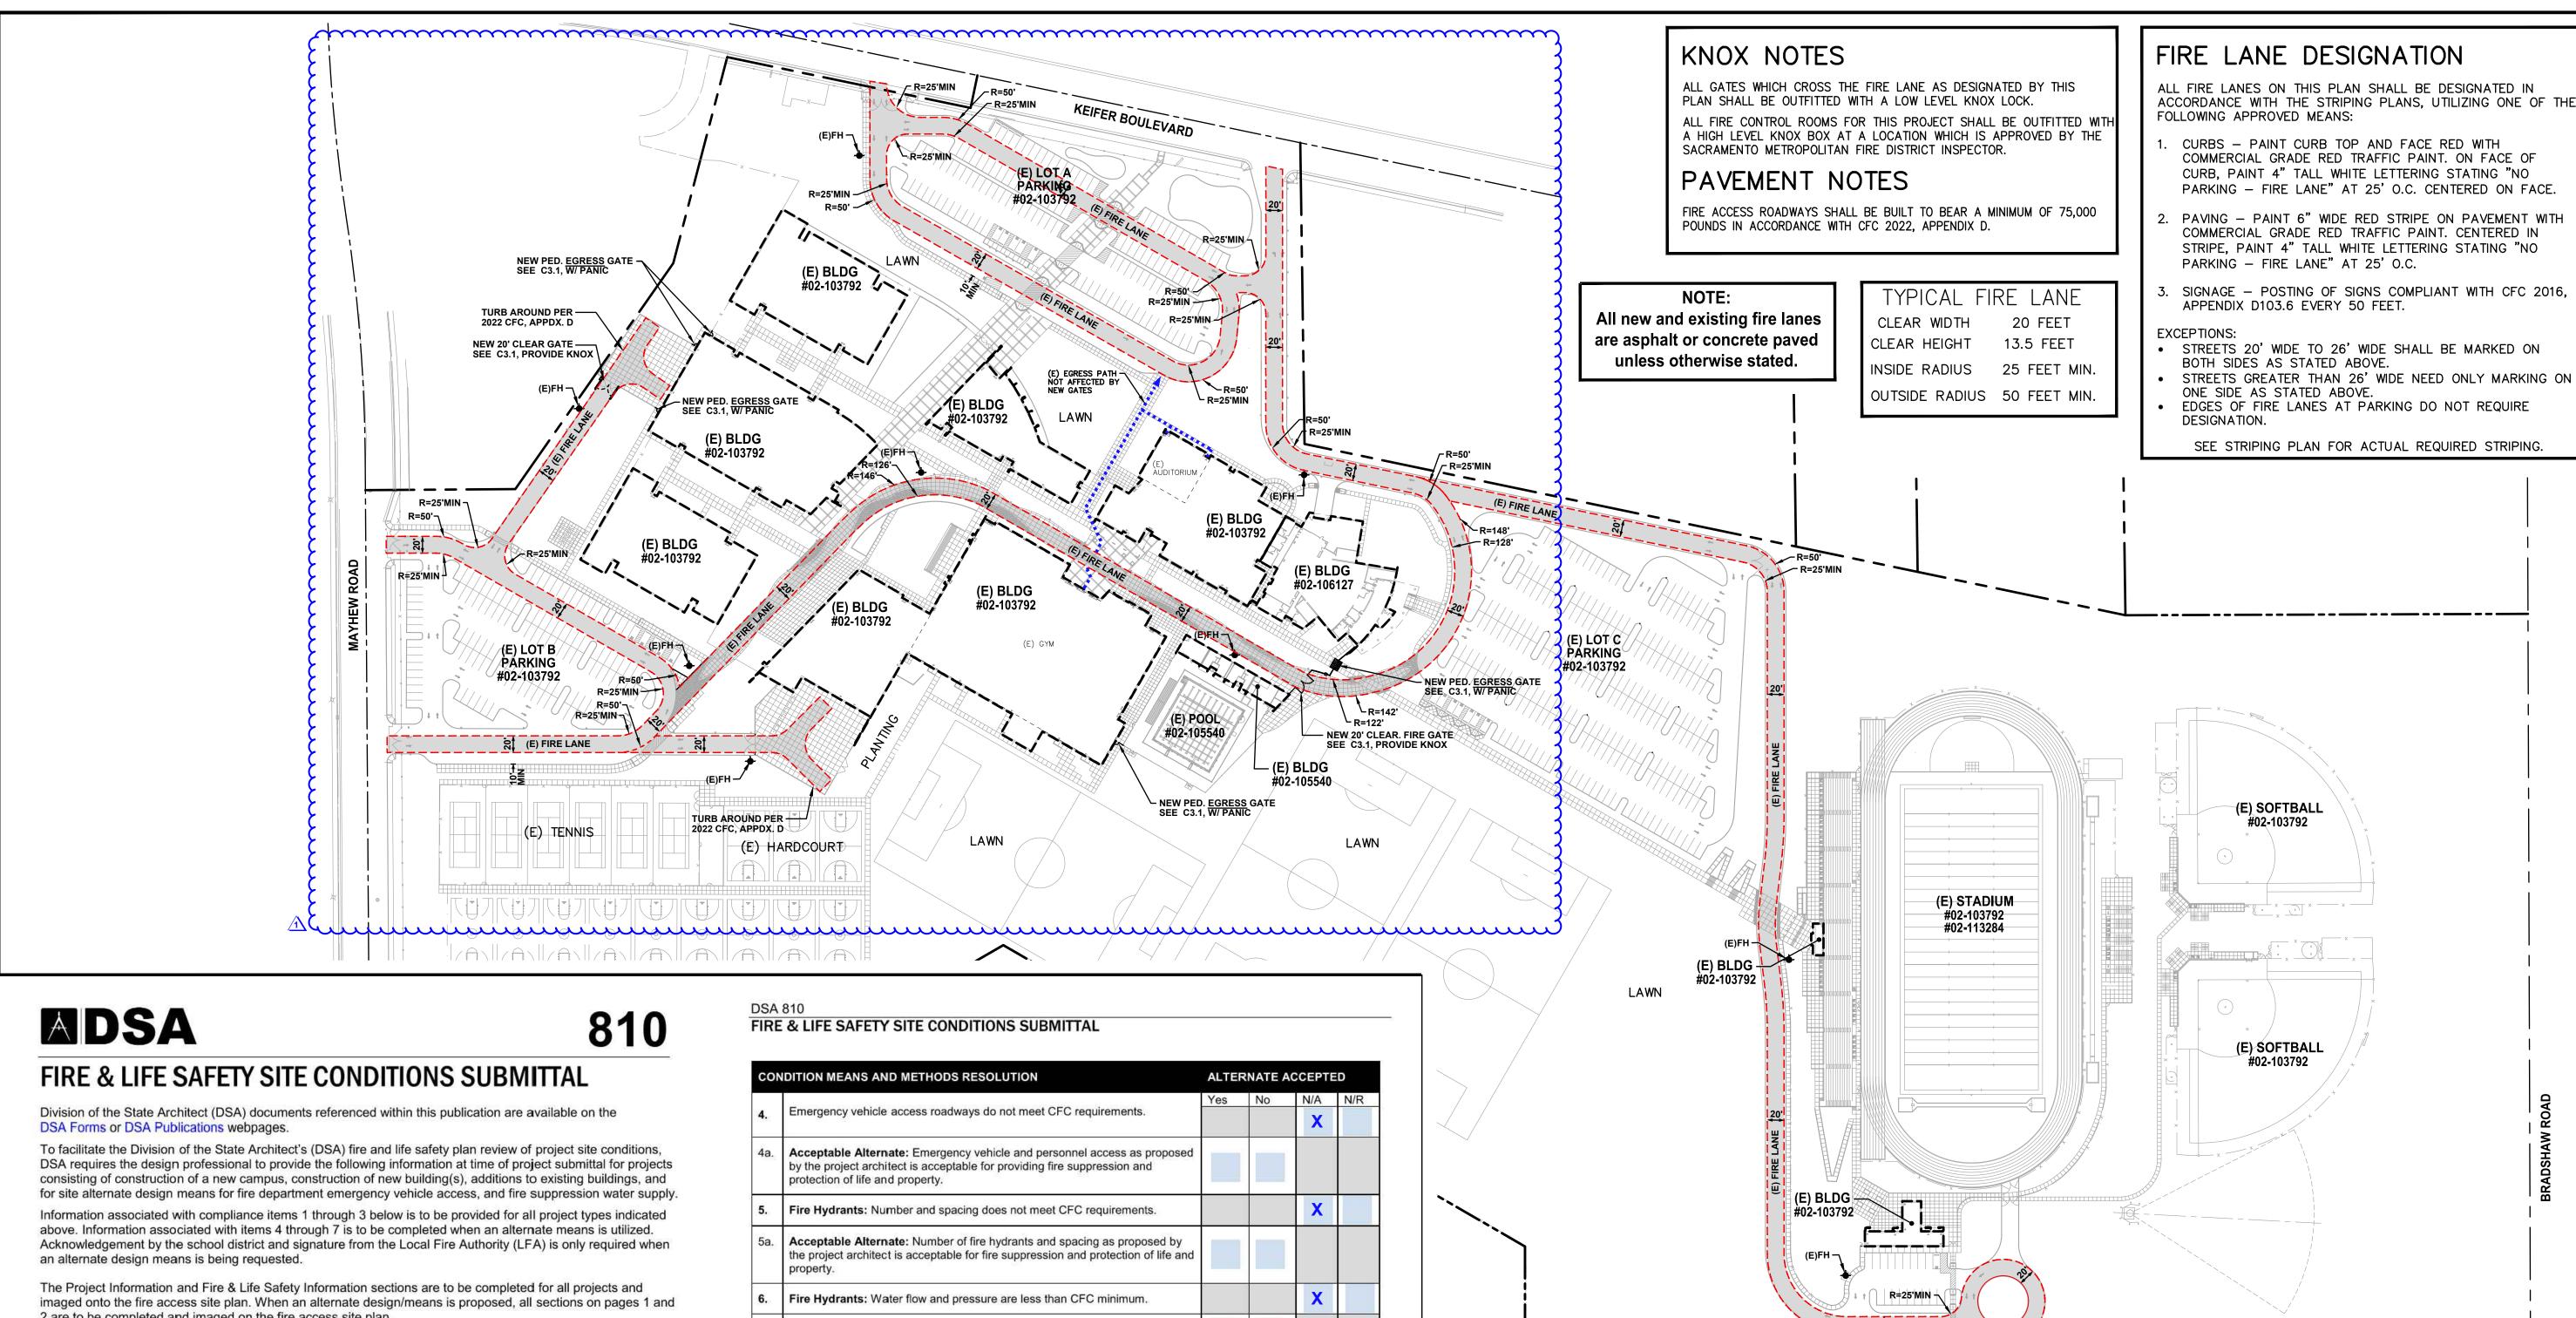

2 are to be completed and imaged on the fire access site plan.

For additional information refer to the instructions at the end of this form and DSA Policy PL 09-01: Fire Flow for Buildings.

| Sch | nool District/Owner: SACRAMENTO CITY UNIFIED SCHOOL DISTRICT | | | |
|-----|---|----------|--------|-------------|
| Pro | oject Name/School: ROSEMONT HIGH SCHOOL | | | |
| Pro | oject Address: 9594 KIEFER BLVD., SACRAMENTO, CA 95827 | | | |
| FIR | RE & LIFE SAFETY INFORMATION | | | |
| 1. | Has a fire hydrant flow test been performed within the past 12 months? (If yes, provide a copy of the test data.) | Yes 🗆 | | No 💢 |
| 2. | Was the fire hydrant water flow test performed as part of this LFA review? | Yes 🗆 | | No 💢 |
| 3. | Is the project located within a designated fire hazard severity zone (FHSZ) as established by Cal-Fire? (If yes, indicate FHSZ classification below.) | Yes 🗆 | | No 💢 |
| | Refer to the following website for FHSZ locations: http://eqis.fire.ca.gov/FHSZ/ | Moderate | High 🗏 | Very High 🔲 |

Wildland Interface Area (WIFA) (If any designations are checked, project design must meet the WIFA

DEPARTMENT OF GENERAL SERVICES

requirements of CBC Chapter 7A.)

DGS DSA 810 (revised 12/29/20)

DIVISION OF THE STATE ARCHITECT

| CON | CONDITION MEANS AND METHODS RESOLUTION | | | ALTERNATE ACCEPTED | | | |
|-----|--|-----|----|--------------------|-----|--|--|
| | | Yes | No | N/A | N/R | | |
| 4. | Emergency vehicle access roadways do not meet CFC requirements. | | | X | | | |
| 4a. | Acceptable Alternate: Emergency vehicle and personnel access as proposed by the project architect is acceptable for providing fire suppression and protection of life and property. | | | | | | |
| 5. | Fire Hydrants: Number and spacing does not meet CFC requirements. | | | X | | | |
| 5a. | Acceptable Alternate: Number of fire hydrants and spacing as proposed by the project architect is acceptable for fire suppression and protection of life and property. | | | | | | |
| 6. | Fire Hydrants: Water flow and pressure are less than CFC minimum. | ė | | X | | | |
| 6a. | Acceptable Alternate: The available flow and pressure is acceptable for providing fire suppression and protection of life and property. | | | | | | |
| 7. | Location of fire department connection(s) serving fire sprinkler systems or standpipe systems does not meet CFC requirements. | | | X | | | |
| 7a. | Acceptable Alternate: The location of fire department connection serving the fire sprinkler system and/or standpipe system is acceptable for providing fire suppression and protection of life and property. | | | | | | |

School District Acceptance of Acceptable Design Alternates

LFA Reviewer's Signature:

Page 1 of 4 STATE OF CALIFORNIA

N/A - NO VARIANCE PROPOSED

By signing this form, the school district acknowledges and accepts the proposed design as an alternative to California Building Code (CBC) and California Fire Code (CFC) minimum requirements, as indicated by one or more of the conditions indicated at items 4a, 5a, 6a or 7a, for providing fire and life safety protection of life and property.

| LOCAL FIRE AUTHO | DRITY (LFA) INFORMATION | | |
|----------------------|-------------------------|-------------|----------------|
| LFA Agency Name: | Sacramento Metro Fire | | |
| LFA Review Official: | Janea Smith | | |
| Title: Code En | forcement Supevisor | Work Phone: | (916) 859-4319 |

DGS DSA 810 (revised 12/29/20) Page 2 of 4 DEPARTMENT OF GENERAL SERVICES STATE OF CALIFORNIA DIVISION OF THE STATE ARCHITECT

ALL FIRE LANES ON THIS PLAN SHALL BE DESIGNATED IN ACCORDANCE WITH THE STRIPING PLANS, UTILIZING ONE OF THE

CURBS - PAINT CURB TOP AND FACE RED WITH COMMERCIAL GRADE RED TRAFFIC PAINT. ON FACE OF CURB, PAINT 4" TALL WHITE LETTERING STATING "NO PARKING - FIRE LANE" AT 25' O.C. CENTERED ON FACE.

. PAVING - PAINT 6" WIDE RED STRIPE ON PAVEMENT WITH COMMERCIAL GRADE RED TRAFFIC PAINT, CENTERED IN STRIPE, PAINT 4" TALL WHITE LETTERING STATING "NO

SIGNAGE - POSTING OF SIGNS COMPLIANT WITH CFC 2016,

• STREETS 20' WIDE TO 26' WIDE SHALL BE MARKED ON

EDGES OF FIRE LANES AT PARKING DO NOT REQUIRE

SEE STRIPING PLAN FOR ACTUAL REQUIRED STRIPING.


Sacramento **City Unified School District**

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EL DORADO HILLS, CA 95762 | (916) 985-1870

OWNER:

Sacramento City Unified School District 5735 47th Avenue Sacramento, CA 95824-4528

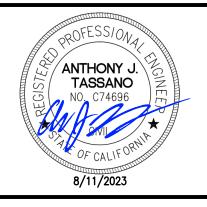

Rosemont High School 2023 Fencing

9594 Kiefer Blvd. Sacramento, CA 95827

REVISIONS DESCRIPTION ADDENDUM NO.1

SCALE: DRAWN: AS NOTE PROJECT NO. CHECKED: 23-051 DESIGNED: DATE: SMN/AT 05/01/2023

ISSUANCE:

SHEET TITLE:

FIRE ACCESS **PLAN**

SHEET NO.

C1.0.2


FIRE ACCESS PLAN SCALE 1" = 100' - 0"

(E) BASEBALL

#02-103792

(E) BASEBALL

#02-103792

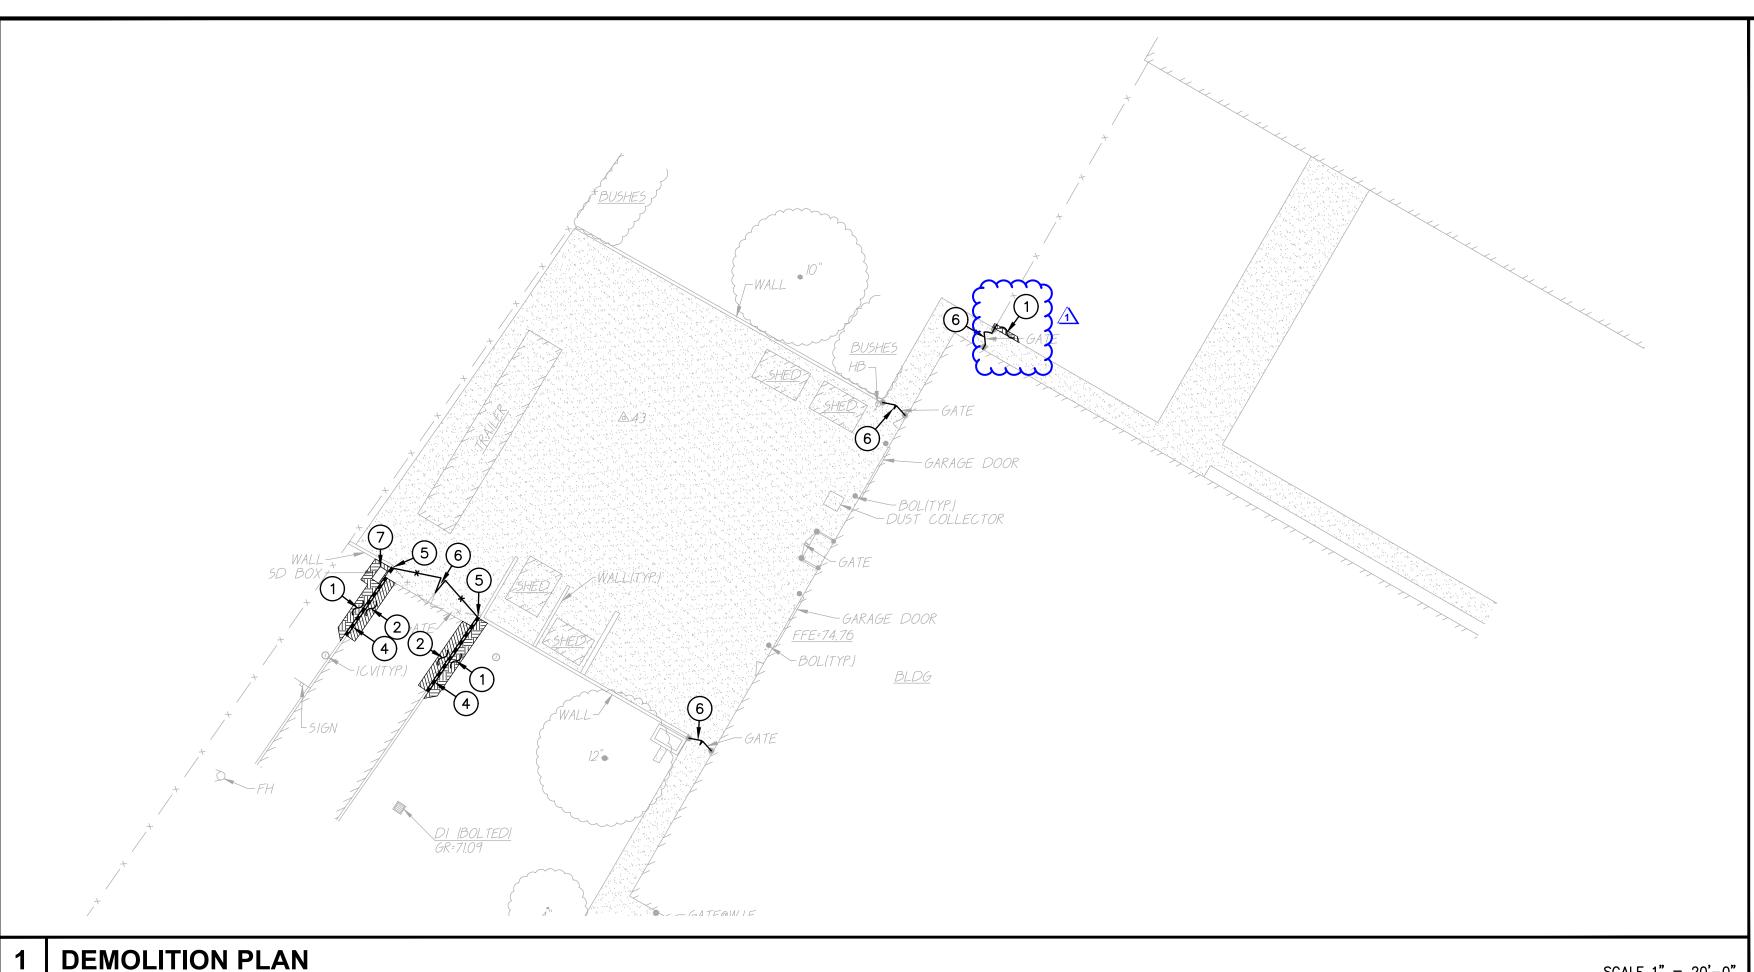

DEMOLITION PLAN

CAL-GREEN - Waste Diversion:

5.408.1 Construction waste management. Recycle and/or salvage for reuse a minimum of 65 percent of the nonhazardous construction and demolition waste in accordance with Section 5.408.1.1, 5.408.1.2 or 5.408.1.3; or meet a local construction and demolition waste management ordinance, whichever is more stringent.

5.408.1.1 Construction waste management plan. Where a local jurisdiction does not have a construction and demolition waste management ordinance that is more stringent, submit a construction waste management plan that:

- 1. Contractor shall Identify the construction and demolition waste materials to be diverted from disposal, to comply with 65% criteria listed above, by efficient usage, recycling, reuse on the project or salvage for future use or sale.
- Contractor shall determines if construction and demolition waste materials will be sorted on-site (source-separated) or bulk mixed (single stream). Either method is the responsibility of the contractor. Contractor shall Identify diversion facilities where construction and demolition waste material collected will be
- taken. Transport to such facilities is contractors responsibility. Contractor shall record and provide record of the amount of construction and demolition waste materials diverted shall be calculated by weight or volume, but not by both.

5.408.1.2 Waste management company. Utilize a waste management company that can provide verifiable documentation that the percentage of construction and demolition waste material diverted from the landfill complies with this section.

Contractor shall make the determination if the construction and demolition waste material will be diverted by a waste management company. Contractor shall make any and all arrangements with waste management company for pickup of materials.

Exceptions to Sections 5.408.1.1 and 5.408.1.2: Excavated soil and land-clearing debris.

- Alternate waste reduction methods developed by working with local agencies if diversion or recycle facilities capable of compliance with this item do not exist.
- Demolition waste meeting local ordinance or calculated in consideration of local recycling facilities and

5.408.1.3 Waste stream reduction alternative. The combined weight of new construction disposal that does not exceed two pounds per square foot of building area may be deemed to meet the 65 percent minimum requirement as approved by the enforcing agency.

CAL-GREEN - Waste Diversion Documentation Required:

Contractor shall prepare and provide documentation to the enforcing agency which demonstrates compliance with Calgreen Sections 5.408.1.1 through 5.408.1.3. The waste management plan shall be updated as necessary and shall be accessible during construction for examination by the enforcing agency.

1. Sample forms found in "A Guide to the California Green Building Standards Code (Nonresidential)" located at http://www.bsc.ca.gov/Home/CALGreen. aspx may be used to assist in documenting compliance with the

waste management plan. Mixed construction and demolition debris (C&D) processors can be located at the California Department of Resources Recycling and Recovery (CalRecycle).

CAL-GREEN - Excavated Soil & Land Clearing: 5.408.3 Excavated soil and land clearing debris. 100 percent of trees, stumps, rocks and associated vegetation and

soils resulting primarily from land clearing shall be reused or recycled. For a phased project, such material may be stockpiled on site until the storage site is developed.

Exception: Reuse, either on-or off-site, of vegetation or soil contaminated by disease or pest infestation.

SCALE 1'' = 20' - 0''

1. If contamination by disease or pest infestation is suspected, contact the County Agricultural Commissioner and follow its direction for recycling or disposal of the material. (www.cdfa.ca.gov/exec/county/county_contacts.html) For a map of known pest and/or disease quarantine zones, consult with the California Department of Food and Agriculture. (www.cdfa.ca.gov)

DEMOLITION GENERAL NOTES

- IN THE EVENT THAT ANY UNUSUAL CONDITIONS NOT COVERED BY THE GEOTECHNICAL INVESTIGATION REPORT OR ARE ENCOUNTERED DURING GRADING OPERATIONS THE GEOTECHNICAL ENGINEER AND THE ENGINEER SHALL BE IMMEDIATELY NOTIFIED FOR
- NO BURNING OR BLASTING SHALL BE PERMITTED.
- ADDITIONAL DEMOLITION INFORMATION MAY BE SHOWN ON THE GRADING, DRAINAGE, AND UTILITY PLANS, AND THOSE PLANS PREPARED BY OTHER DISCIPLINES FOR THIS PROJECT.
- ALL DEMOLISHED ITEMS SHALL BE DISPOSED OF OFFSITE AT A SUITABLE, LEGAL, DUMP SITE OR OTHER FACILITY.
- 5. ALL DISPOSED OF MATERIALS SHALL BE RECYCLED IF POSSIBLE.
- THE TYPES, LOCATIONS, SIZES AND/OR DEPTHS OF EXISTING UNDERGROUND UTILITIES AS SHOWN IN THESE PLANS WERE OBTAINED FROM SOURCES OF VARYING RELIABILITY. THE CONTRACTOR IS CAUTIONED THAT ONLY ACTUAL EXCAVATION WILL REVEAL THE TYPES, EXTENT, SIZES, LOCATIONS, AND DEPTHS OF SUCH UNDERGROUND UTILITIES. A REASONABLE EFFORT HAS BEEN MADE TO LOCATE AND DELINEATE ALL KNOWN UNDERGROUND UTILITIES. HOWEVER, WARREN CONSULTING ENGINEERS CAN ASSUME NO RESPONSIBILITY FOR THE COMPLETENESS OR ACCURACY OF ITS DELINEATION OF SUCH UNDERGROUND UTILITIES, NOR FOR THE EXISTENCE OF OTHER BURIED OBJECTS OR UTILITIES WHICH MAY BE ENCOUNTERED BUT WHICH ARE NOT SHOWN ON THESE DRAWINGS. THE CONTRACTOR OR ANY SUBCONTRACTOR FOR THIS CONTRACT SHALL NOTIFY THE DISTRICT TWO (2) WORKING DAYS IN ADVANCE OF PERFORMING ANY EXCAVATION WORK IN ORDER TO VERIFY TO THE GREATEST EXTENT POSSIBLE THE EXISTING UTILITY LINES, CONFLICTS AND PROPOSED UTILITY CONNECTION POINTS.
- THE SCHOOL DISTRICT SHALL HAVE SALVAGE RIGHTS TO ANY DEMOLISHED ITEMS SHOWN HEREON. THE CONTRACTOR SHALL GIVE THE DISTRICT NOTICE 7 DAYS PRIOR TO THE START OF DEMOLITION. THE DISTRICT SHALL MOVE ANY RETAINED ITEMS OUT OF THE CONTRACTORS WORK AREA, UNLESS ANOTHER ARRANGEMENT IS MADE WITH THE CONTRACTOR. ANY REMAINING ITEMS BECOME THE PROPERTY OF THE CONTRACTOR AND SHALL BE REMOVED FROM THE SITE. ANY ITEMS NOT SHOWN FOR REMOVAL SHALL REMAIN AND SHALL BE
- PROTECTED FROM DAMAGE DURING CONSTRUCTION TO A REASONABLE EXTEND. EXISTING UTILITY STRUCTURES IN AREAS OF NEW PAVING SHALL BE REMOVED AND REINSTALLED AT NEW GRADE UNLESS SPECIFICALLY NOTED OTHERWISE.
- 9. ITEMS OUTSIDE THE LIMITS OF DEMOLITION SHALL REMAIN AND BE PROTECTED FROM DAMAGE DURING CONSTRUCTION..
- 10. CONTRACTOR SHALL COMPLY WITH CHAPTER 33 OF THE 2019 CFC, "FIRE SAFETY DURING CONSTRUCTION AND DEMOLITION" AT ALL TIMES DURING CONSTRUCTION.
- CONTRACTOR SHALL HIRE A UTILITY LOCATING COMPANY AND SHALL SCAN THE ENTIRE AREA WITHIN THE LIMITS OF NEW WORK. ALL UTILITIES LOCATED SHALL BE MARKED AND PROTECTED DURING THE LIMING OPERATIONS AS WELL AS ANY EXCAVATING TASKS. ANY LOCATED UTILITY DAMAGED WITHIN THE LIMITS OF WORK WILL BE THE RESPONSIBILITY OF
- 12. ALL DEMOLITION SHALL BE APPROPRIATELY SUPPORTED AND REINFORCED DURING REMOVAL TO PREVENT INJURY FROM FALLING, PROJECTILE, OR OTHERWISE MOVING DEBRIS OR OTHER DELETERIOUS MATERIAL. ONSITE SAFETY WITHIN THE LIMITS OF WORK IS THE CONTRACTORS SOLE RESPONSIBILITY.

DEMOLITION NOTES

THE CONTRACTOR TO REPAIR.

NOTE: NOT ALL NOTES MAY BE USED ON THIS SHEET LEGEND # DEMOLITION NOTES



REMOVE ALL PLANTS, SHRUBS, EXISTING VEGETATION, AND IRRIGATION SYSTEMS. REFER TO EARTHWORK SPECIFICATIONS FOR ADDITIONAL SITE

CLEARING REQUIREMENTS. SEE GENERAL IRRIGATION NOTE, THIS SHEET.

3. REMOVE EXISTING CONCRETE PAVING AND BASE ROCK, WHERE SAWCUTS ARE



REMOVE EXISTING ASPHALT PAVING AND BASE TO ALLOW FOR NEW WORK. AC MAY BE GRINDED AND BLENDED WITH EXISTING BASE, EXCAVATED AND USED AS FILL, REFER TO EARTHWORK SPECIFICATIONS.




- NECESSARY, THEY SHALL BE A NEAT STRAIGHT LINE. CUT SHALL BE MADE AT NEAREST EXISTING JOINT TO LOCATION SHOWN.
- 4. REMOVE EXISTING CONCRETE CURB, MOWBAND, APRON OR GUTTER AS
- 5. SAWCUT EXISTING GATE POST TO GRADE. GRIND FLUSH SO NO LIP IS PRESENT. FILL WITH MORTAR TO FLUSH WITH GRADE AND TOOL SMOOTH.
- * * * 6. REMOVE EXISTING CHAIN LINK FENCING AND GATES AS SHOWN. REMOVE POST TO INCLUDE CONCRETE FOOTINGS. REPAIR FINISHED SURFACES.
 - 7. EXISTING DRAIN INLET TO REMAIN.

1117 WINDFIELD WAY, SUITE 110



Sacramento **City Unified School District**

Sacramento City Unified School District 5735 47th Avenue Sacramento, CA 95824-4528

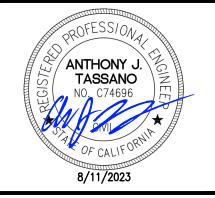

Rosemont High School 2023 Fencing

9594 Kiefer Blvd. Sacramento, CA 95827

REVISIONS DESCRIPTION ADDENDUM NO.1

DRAWN: SCALE: AS NOTE PROJECT NO. CHECKED: 23-051 DESIGNED: SMN/AT | 05/01/2023 ISSUANCE:

SHEET TITLE:

DEMOLITION PLAN

SHEET NO.

Call before you dig.

C1.1




EXISTING CONCRETE JOINT BEYOND NEAREST THE LOCATION OF DEMOLITION AS SHOWN.

CONNECTION FOR LOCATION, DEPTH, AND SIZE, IF CONFLICT IS FOUND, CONTACT THE ENGINEER IMMEDIATELY FOR DIRECTION.

GRAPHIC SCALE

THIS DRAWING MAY HAVE BEEN ENLARGED OR REDUCED. SCALE 1" = 20'-0"

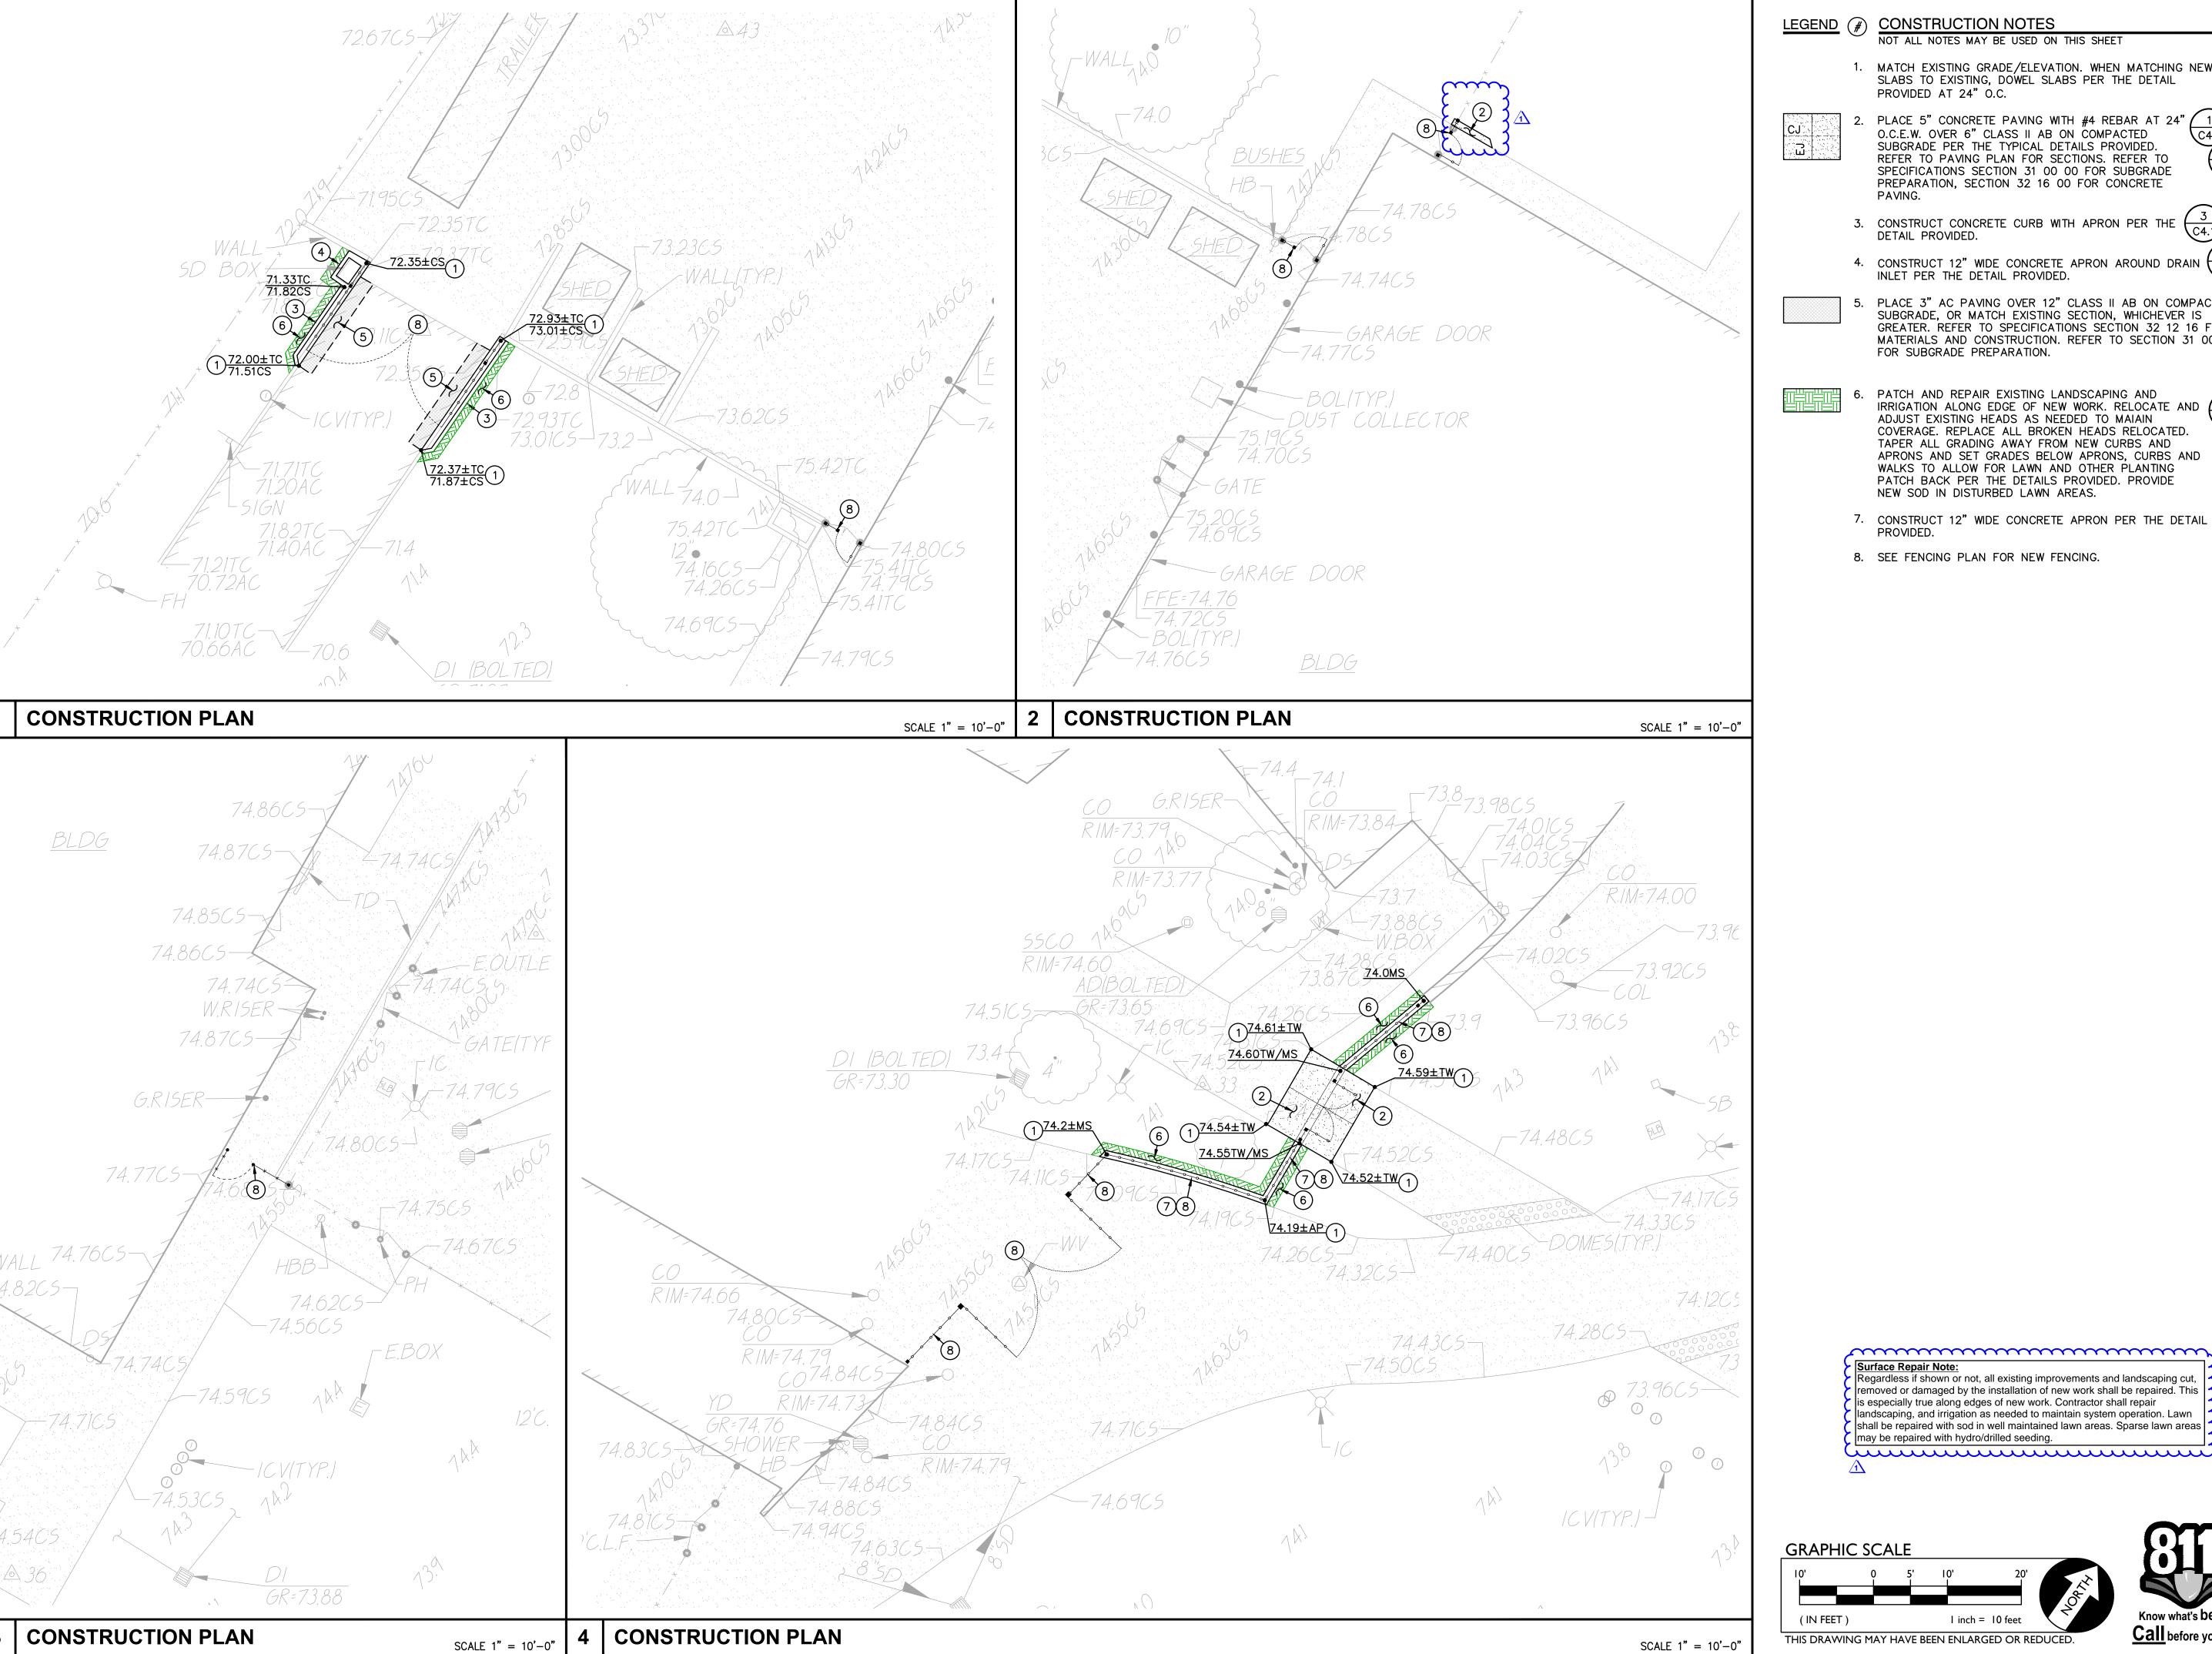

LEGEND (#) CONSTRUCTION NOTES

NOT ALL NOTES MAY BE USED ON THIS SHEET

1. MATCH EXISTING GRADE/ELEVATION. WHEN MATCHING NEW SLABS TO EXISTING, DOWEL SLABS PER THE DETAIL PROVIDED AT 24" O.C.

PLACE 5" CONCRETE PAVING WITH #4 REBAR AT 24" 1 1 2 O.C.E.W. OVER 6" CLASS II AB ON COMPACTED SUBGRADE PER THE TYPICAL DETAILS PROVIDED.
REFER TO PAVING PLAN FOR SECTIONS. REFER TO SPECIFICATIONS SECTION 31 00 00 FOR SUBGRADE PREPARATION, SECTION 32 16 00 FOR CONCRETE



- 4. CONSTRUCT 12" WIDE CONCRETE APRON AROUND DRAIN (C4.1)
- PLACE 3" AC PAVING OVER 12" CLASS II AB ON COMPACTED SUBGRADE, OR MATCH EXISTING SECTION, WHICHEVER IS GREATER. REFER TO SPECIFICATIONS SECTION 32 12 16 FOR MATERIALS AND CONSTRUCTION. REFER TO SECTION 31 00 00 FOR SUBGRADE PREPARATION.

PATCH AND REPAIR EXISTING LANDSCAPING AND IRRIGATION ALONG EDGE OF NEW WORK. RELOCATE AND ADJUST EXISTING HEADS AS NEEDED TO MAIAIN COVERAGE. REPLACE ALL BROKEN HEADS RELOCATED. TAPER ALL GRADING AWAY FROM NEW CURBS AND APRONS AND SET GRADES BELOW APRONS, CURBS AND WALKS TO ALLOW FOR LAWN AND OTHER PLANTING PATCH BACK PER THE DETAILS PROVIDED. PROVIDE NEW SOD IN DISTURBED LAWN AREAS.

- 7. CONSTRUCT 12" WIDE CONCRETE APRON PER THE DETAIL $\begin{pmatrix} 4 \\ C4.1 \end{pmatrix}$ PROVIDED.
- 8. SEE FENCING PLAN FOR NEW FENCING.




EL DORADO HILLS, CA 95762 | (916) 985-1870

OWNER:

5 C4.1

Sacramento **City Unified School District**

Sacramento City **Unified School District** 5735 47th Avenue Sacramento, CA 95824-4528

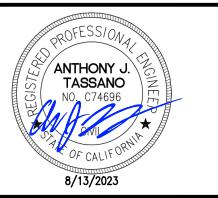

Rosemont High School 2023 Fencing

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REVISIONS DESCRIPTION ADDENDUM NO.1

DRAWN: SCALE: AS NOTE PROJECT NO. CHECKED: 23-051 DESIGNED: SMN/AT

05/01/2023

ISSUANCE:

SHEET TITLE:

GRADING PLAN

SHEET NO.

Know what's below.

C2.1

GRAPHIC SCALE <u>Call</u> before you dig. THIS DRAWING MAY HAVE BEEN ENLARGED OR REDUCED.



FENCING PLAN

SCALE 1" = 10'-0"

FENCING PLAN

(#) ORNAMENTAL FENCING NOTES

PLACE 6' TALL 3-RAIL ORNAMENTAL FENCING. REFER TO SPECIFICATIONS SECTION 32 31 19. REFER TO GRADING/CONSTUCTION PLAN FOR FOUNDATION CONDITION, I.E. SLAB C4.2 EDGE, CONCRETE APRON, ETC. SEE ALSO TYPICAL FENCING DETAILS PROVIDED.

2. CONSTRUCT 6' TALL BLACK 3-RAIL ORNAMENTAL 42" WIDE (NOMINAL) SINGLE SWING 5 PEDESTRIAN GATE WITH PANIC HARDWARE AND CLOSERS. REFER TO SPECIFICATIONS

SECTION 32 31 19. AND DETAILS PROVIDED.

C4.2

3. CONSTRUCT 6' TALL BLACK 3-RAIL ORNAMENTAL 48" WIDE (NOMINAL) DOUBLE SWING 4 6 PEDESTRIAN GATE WITH PANIC HARDWARE AND CLOSERS. REFER TO SPECIFICATIONS SECTION 32 31 19. AND DETAILS PROVIDED.

- 4. CONSTRUCT 6' TALL BLACK 3-RAIL ORNAMENTAL DOUBLE SWING MAINT. ACCESS GATE, CLEAR WIDTH AS NOTED, REFER TO SPECIFICATIONS SECTION 32 31 19.
- 5. CONNECT TO EXISTING FENCING/POST. IF NO EXISTING POST, SET NEW POST AND CONNECT BOTH NEW AND EXISTING FENCING TO NEW POST.
- 6. SET NEW POST SO THAT THERE IS NO MORE THAN 4" GAP BUT NO LESS THAN 2" GAP BETWEEN EXISTING WALL OR OTHER OBSTRUCTION AND EDGE OF NEW POST. AT CONTRACTORS OPTION, POST MAY BE SET AT 12" FROM OBSTRUCTION AND A WELDED CLOSURE PANEL INSTALLED TO REDUCE GAP TO THE ABOVE STATED. CLOSURE PANEL SHALL MATCH THAT OF ADJOINING FENCING AND MAY BE ATTACHED TO WALL OR OBSTRUCTION. IF PLANNED TO ATTACH, CONTRACTOR TO PROVIDE METHOD OF ATTACHMENT FOR APPROVAL.
- CONSTRUCT 6' TALL BLACK 3-RAIL ORNAMENTAL 42" WIDE (NOMINAL) SINGLE SWING PEDESTRIAN GATE WITH PANIC HARDWARE AND CLOSERS. REFER TO SPECIFICATIONS C4.2 SECTION 32 31 19. AND DETAILS PROVIDED.
- 8. SET NEW POST OFFSET FROM ANGLED WALL TO ALLOW 3" CLEAR FROM WALL AT THE TOP OF POST. WELD CLOSURE PANEL SO THAT THERE IS NO MORE THAN 4" GAP BUT NO LESS THAN 2" GAP BETWEEN EXISTING WALL OR OTHER OBSTRUCTION AND EDGE OF NEW POST. CLOSURE PANEL SHALL MATCH THAT OF ADJOINING FENCING AND MAY BE ATTACHED TO WALL OR OBSTRUCTION. IF PLANNED TO ATTACH, CONTRACTOR TO PROVIDE METHOD OF ATTACHMENT

(#) CHAIN LINK FENCING NOTES

31. PLACE 6' TALL BLACK VINYL COATED CHAIN LINK FENCING. REFER TO SPECIFICATIONS SECTION 32 31 13. REFER TO GRADING/CONSTUCTION PLAN FOR FOUNDATION CONDITION, I.E. SLAB EDGE, CONCRETE APRON, ETC. SEE ALSO TYPICAL FENCING DETAILS PROVIDED.

33. CONSTRUCT 6' TALL BLACK VINYL COATED CHAIN LINK FENCING 48" WIDE (NOMINAL SINGLE SWING PEDESTRIAN GATE WITH PANIC HARDWARE AND CLOSERS. REFER TO SPECIFICATIONS SECTION 32 31 13. AND DETAILS PROVIDED.

SCALE 1" = 10'-0"

- 35. CONNECT TO EXISTING FENCING/POST. IF NO EXISTING POST, SET NEW POST AND CONNECT BOTH NEW AND EXISTING FENCING TO NEW POST.
- 36. SET NEW POST SO THAT THERE IS NO MORE THAN 4" GAP BUT NO LESS THAN 2" GAP BETWEEN EXISTING WALL OR OTHER OBSTRUCTION AND EDGE OF NEW POST. AT CONTRACTORS OPTION, POST MAY BE SET AT 12" FROM OBSTRUCTION AND A WELDED CLOSURE PANEL INSTALLED TO REDUCE GAP TO THE ABOVE STATED. CLOSURE PANEL SHALL MATCH THAT OF ADJOINING FENCING AND MAY BE ATTACHED TO WALL OR OBSTRUCTION. IF PLANNED TO ATTACH, CONTRACTOR TO PROVIDE METHOD OF ATTACHMENT FOR APPROVAL.




EL DORADO HILLS, CA 95762 | (916) 985-1870

OWNER:



Sacramento City **Unified School District** 5735 47th Avenue Sacramento, CA 95824-4528

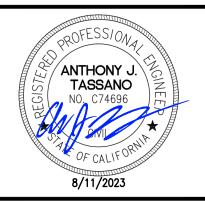

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ISSUANCE:


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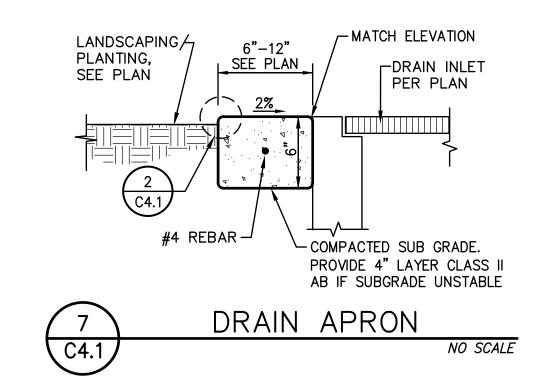
FENCING PLAN


SHEET NO.

Know what's below.

C3.1




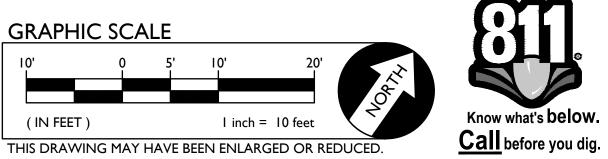


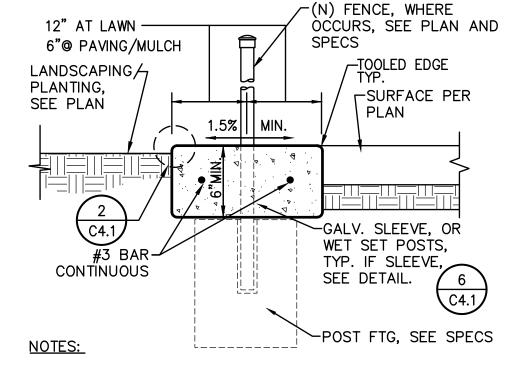

- 1. WHERE NO FENCING, PROVIDE CONTROL JOINT EVERY 10 FEET, EXPANSION JOINT EVERY 30 FEET, TYP. WHERE FENCING EXISTS, PROVIDE TOOLED JOINT EVERY POST, EXPANSION EVERY 3RD POST.
- 2. CONCRETE APRON THICKNESS MAY COUNT FOR POST FOOTING TOTAL DEPTH BUT MUST BE PLACED BEFORE FABRIC OR PANEL INSTALLATION.



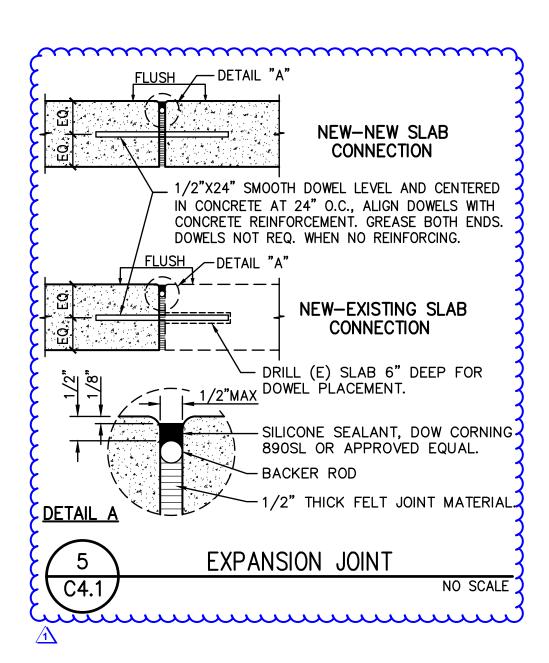

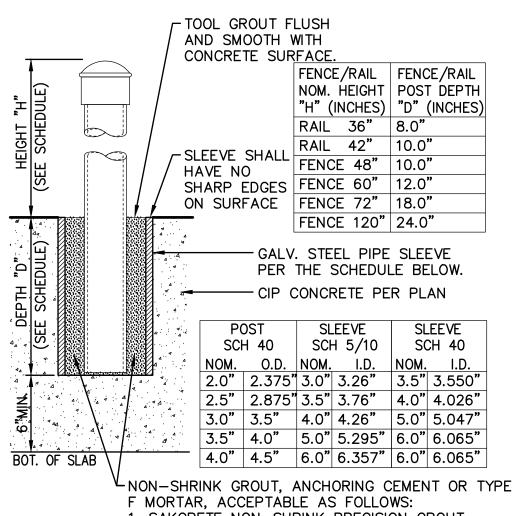


1. SAKCRETE NON-SHRINK PRECISION GROUT. 2. W.R. MEADOWS SPEED-E-ROC. 3. QUICKRETE NON-SHRINK PRECISION GROUT 4. DAYTON SUPERIOR, ANCHOR-ALL


5. APPROVED EQUAL.

C4.1


POST SLEEVE DETAIL NO SCALE

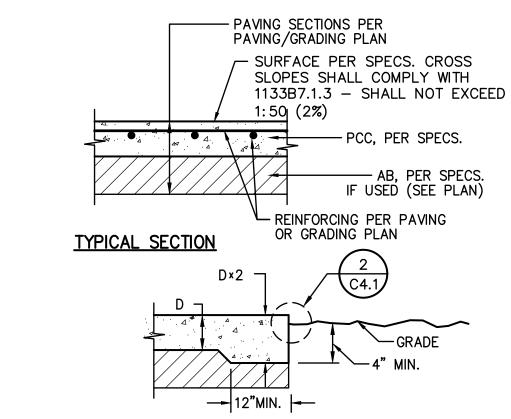


TYPICAL THICKENED EDGE

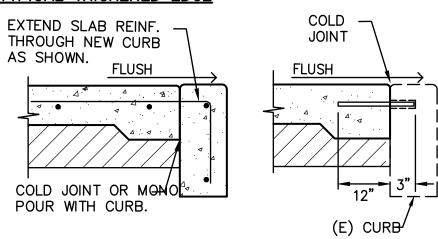


TYPICAL EXPANSION JOINT AT CURB

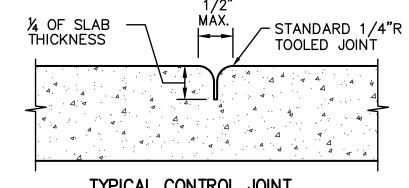

TYPICAL CONTROL JOINT

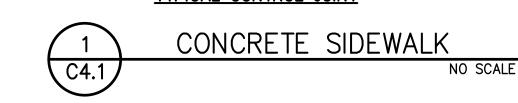


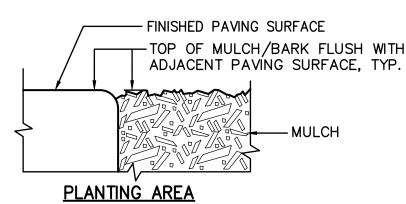

— FINISHED PAVING SURFACE FG OF SOD 1" BELOW ADJACENT PAVING SURFACE, TYP.




SOD LAWN

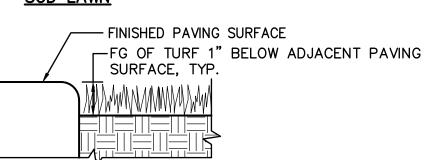

SEED LAWN



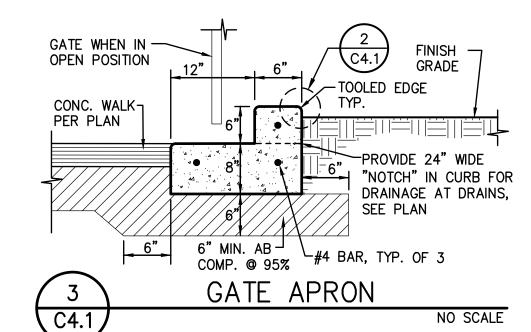




OWNER:



Sacramento City Unified School District 5735 47th Avenue Sacramento, CA 95824-4528

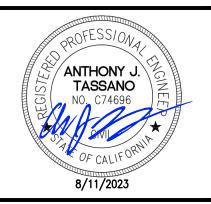

Rosemont High School 2023 Fencing

9594 Kiefer Blvd. Sacramento, CA 95827

| | REVISIONS |
|-----|---------------|
| NO. | DESCRIPTION |
| 1 | ADDENDUM NO.1 |
| | |


| DRAWN: | | | SCALE: | | |
|--------|------|------|-------------|--|--|
| | | SMN | AS NOTED | | |
| CHEC | KED: | | PROJECT NO. | | |
| | | ΑT | 23-051 | | |
| DESIG | NED: | | DATE: | | |
| | SMI | TA\r | 05/01/2023 | | |

SHEET TITLE:

ISSUANCE:

DETAILS AND SECTIONS

SHEET NO.

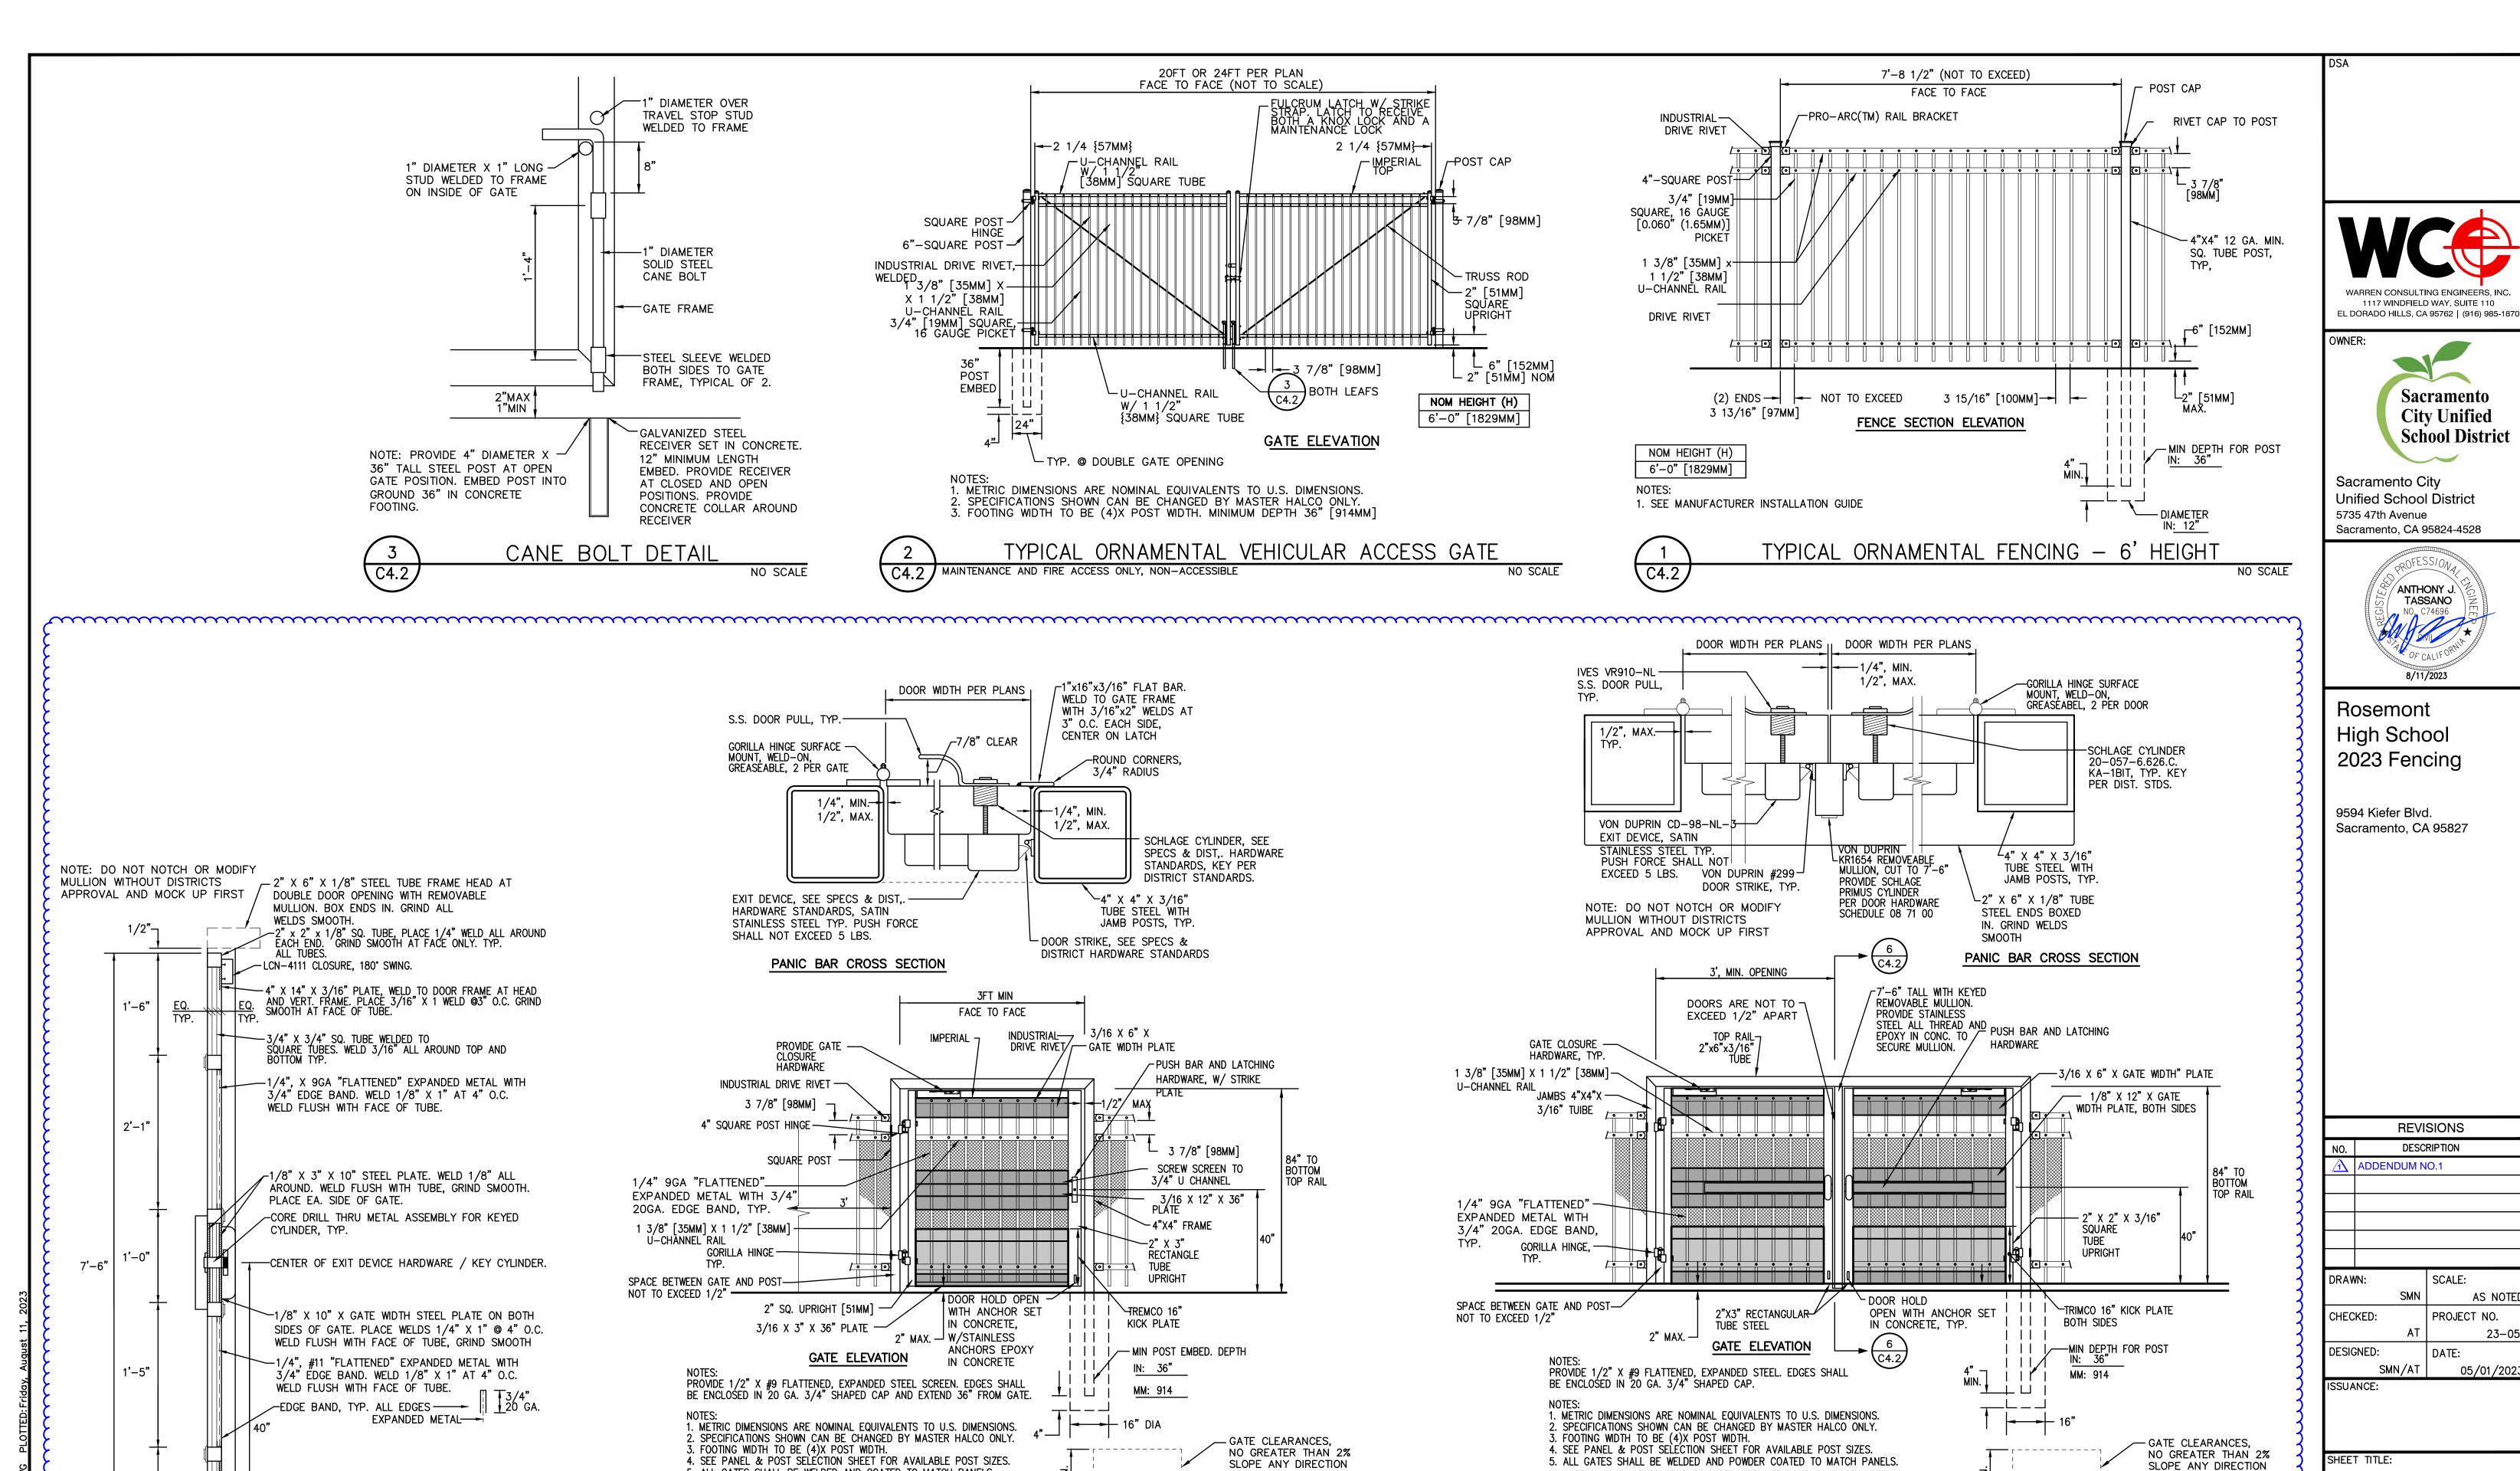

WITHIN PER 11B-404.2.4.4

NO SCALE

FLUSH TRANSITION THRU

GATE PER 11B-404.2.5

<u>TYPICAL GATE CLEARANCE</u>

TYPICAL ORNAMENTAL ACCESSIBLE GATE - SINGLE

6. GATE AND GRAME TO BE FABRICATED OFF SITE BY THIRD PARTY. SEE

NOTE: DO NOT NOTCH OR MODIFY

TYPICAL ORNAMENTAL ACCESSIBLE GATE - DOUBLE

APPROVAL AND MOCK UP FIRST

7. PROVIDE CONTINUOUS WELDS, GRIND AND SAND SMOOTH PRIOR TO

MULLION WITHOUT DISTRICTS

SPECIFICATIONS.

C4.2

POWDER COATING.

5. ALL GATES SHALL BE WELDED AND COATED TO MATCH PANELS.

6. WHERE HOLD OPEN LATCH DOES NOT LAND IN CONCRETE WALK, PROVIDE 8" DIA. 12" DEEP CONCRETE FOOTING

ABRASIVE EDGES AT KICK PLATE (11B-404.2.10)

SPECIFICATIONS.

C4.2

POWDER COATING.

7. PROVIDE KICK PLATE ON BOTH SIDES OF GATE. THE FULL WIDTH OF

THE GATE SURFACE SHALL BE SMOOTH AND FREE OF SHARP OR

8. GATE AND GRAME TO BE FABRICATED OFF SITE BY THIRD PARTY. SEE

9. PROVIDE CONTINUOUS WELDS, GRIND AND SAND SMOOTH PRIOR TO

3/16" X 12" KICK PLATE ON BOTH SIDES OF GATE.

FACE OF TUBE, GRIND SMOOTH.
-SURFACE SHALL BE SMOOTH FOR FULL WIDTH OF

SECTION; FABRICATED METAL DOOR

PLACE 1/4" X 1" WELDS @ 4" O.C. WELD FLUSH WITH

TRIMCO 1283-2S.CUST STOP AND HOLDER WITH 5" STRIKE.

INSTALL WITH STAINLESS ALL THREAD EPOXY INTO CONCRETE

NO SCALE

1'-4"

' MIN.-2" MAX.-

C4.2

DETAILS AND

SECTIONS

SHEET NO.

WITHIN PER


11B-404.2.4.4

FLUSH TRANSITION THRU

NO SCALE

GATE PER 11B-404.2.5

TYPICAL GATE CLEARANCE

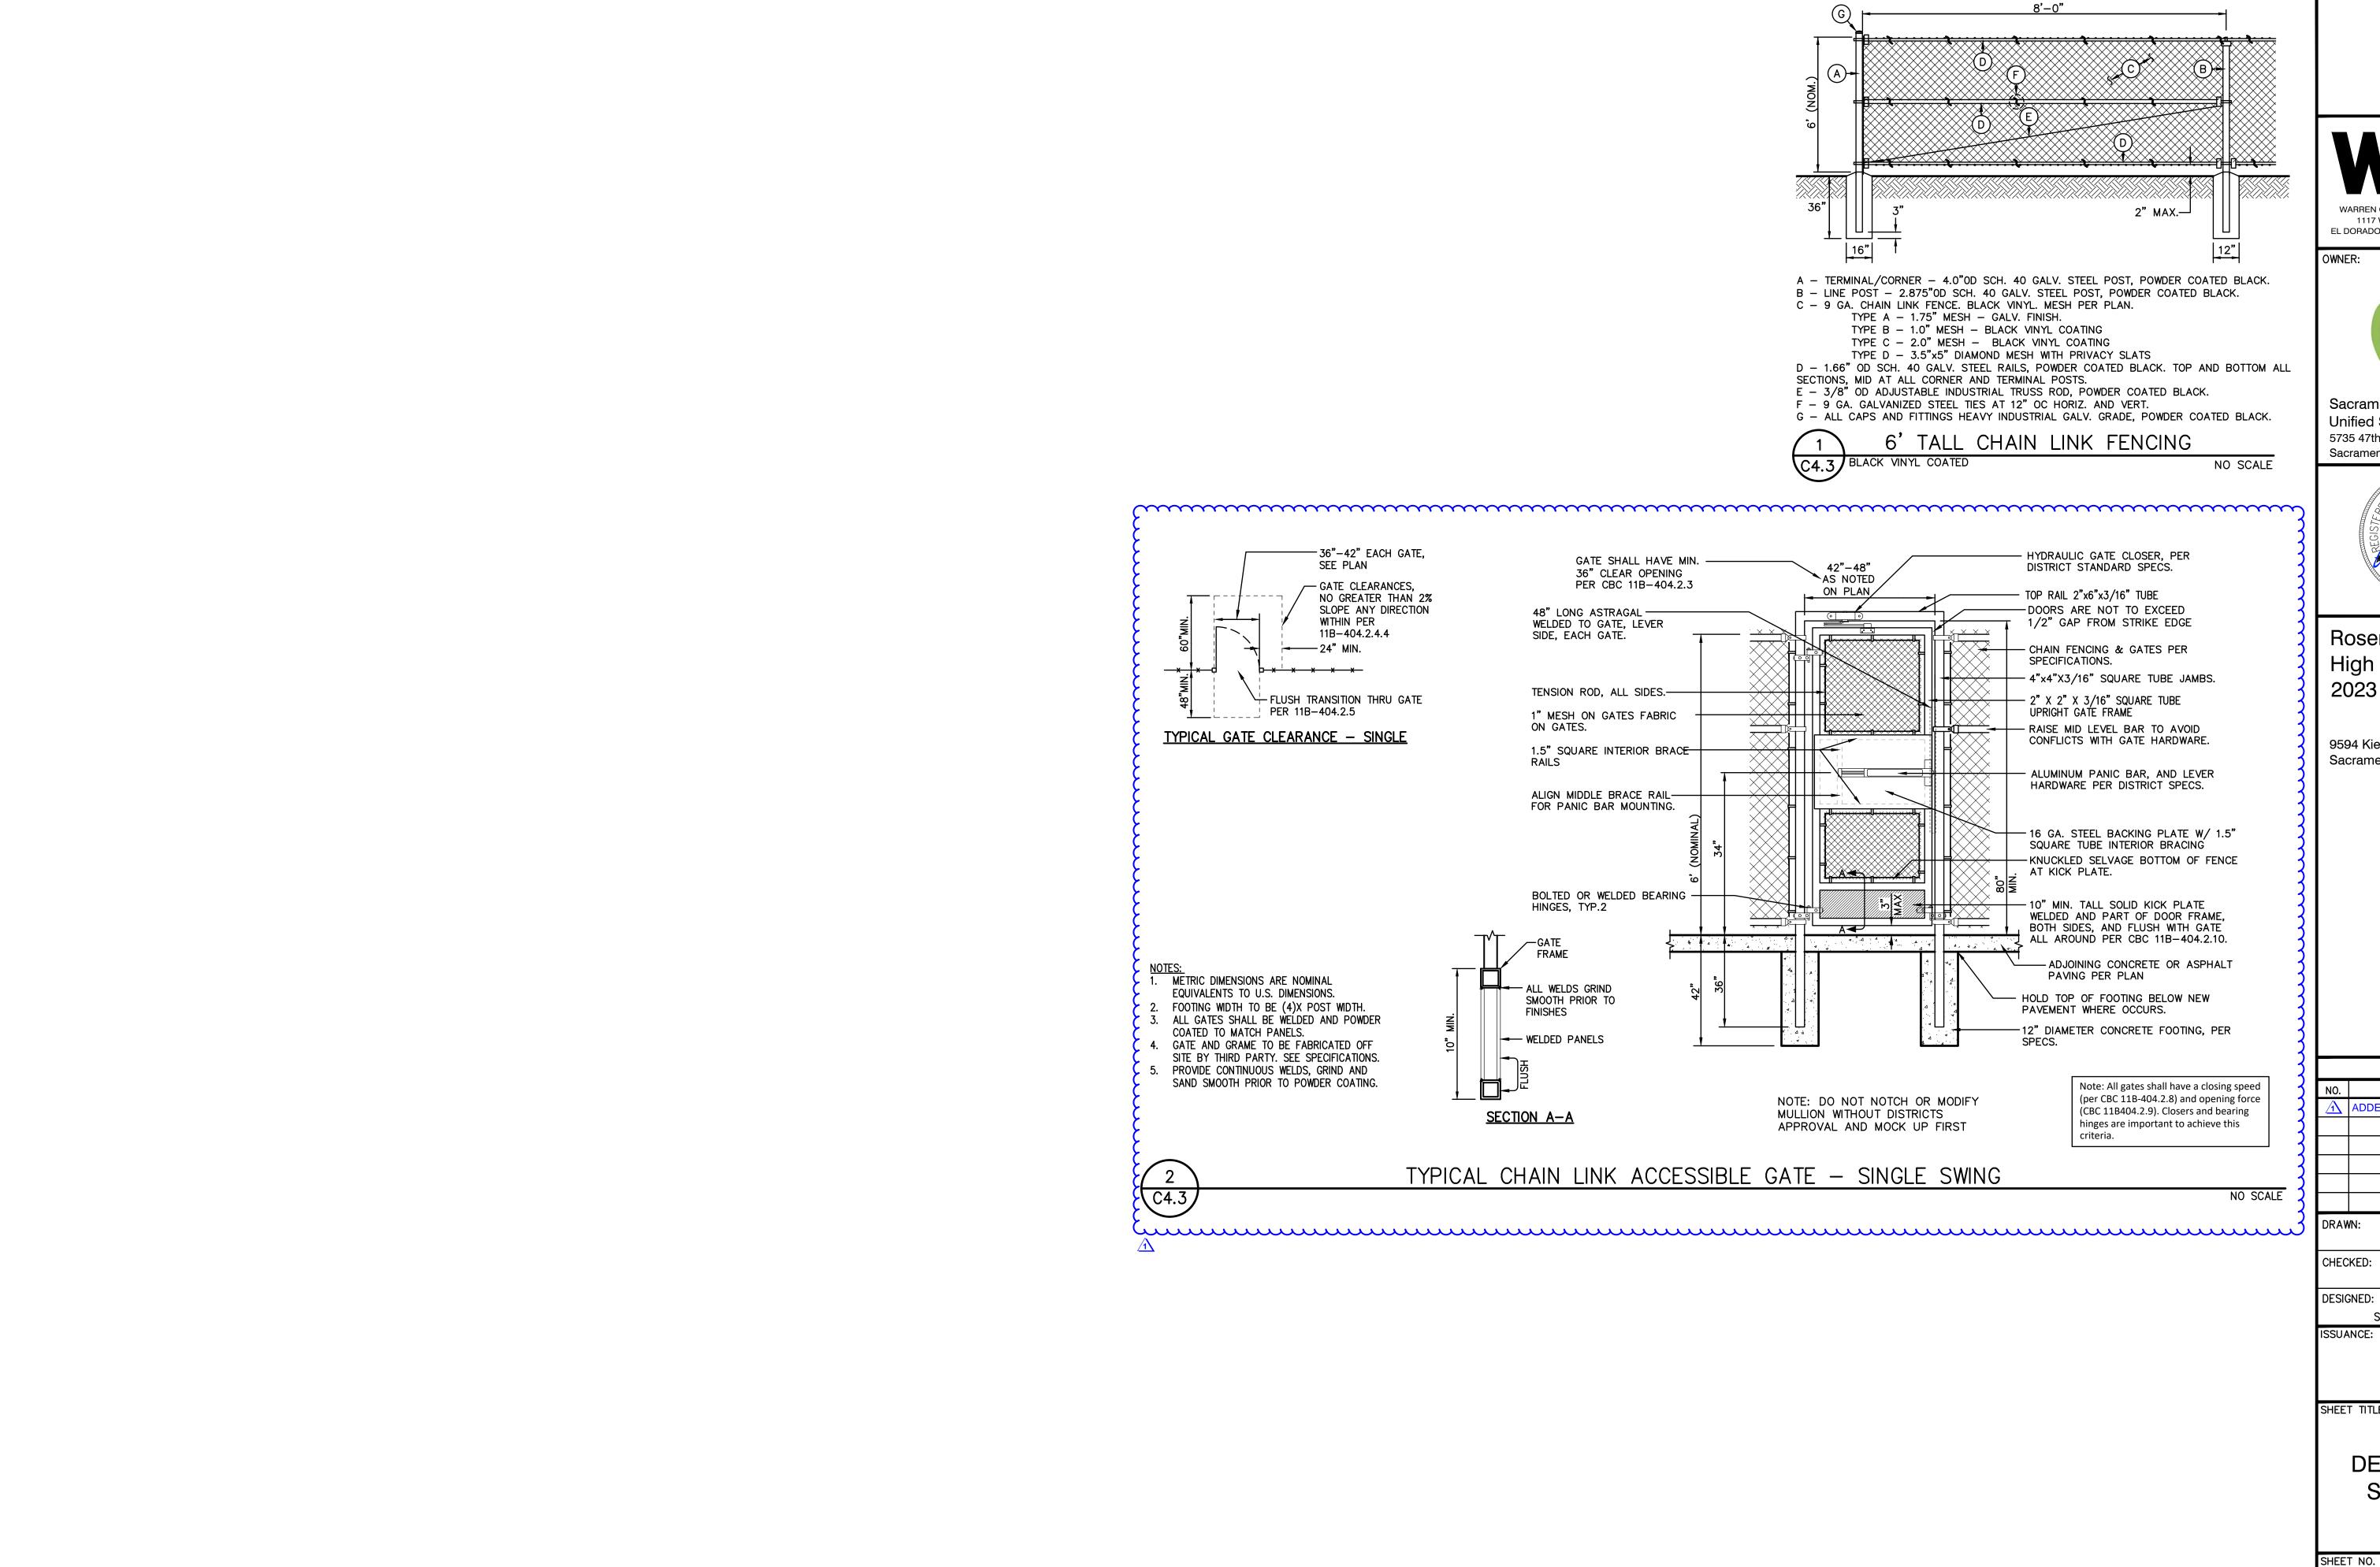

1117 WINDFIELD WAY, SUITE 110 EL DORADO HILLS, CA 95762 | (916) 985-1870



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Rosemont High School 2023 Fencing

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REVISIONS DESCRIPTION 1 ADDENDUM NO.1

SCALE: AS NOTED PROJECT NO. CHECKED: 23-051 DESIGNED: SMN/AT 05/01/2023

SHEET TITLE:

DETAILS AND SECTIONS