SACRAMENTO CITY UNIFIED SCHOOL DISTRICT

MATSUYAMA ELEMENTARY SCHOOL MODERNIZATION

7680 WINDBRIDGE DRIVE SACRAMENTO, CA 95831

AGENCY APPROVAL:

REVIEWING AGENCIES



HMC Architects

3186-070-000

2101 CAPITOL AVENUE, SUITE 100, SACRAMENTO, CA, 95816 916 368 7990 / www.hmcarchitects.com

PROJECT TEAM

OWNER

SACRAMENTO CITY UNIFIED SCHOOL DISTRICT

5735 47TH AVE, SACRAMENTO, CA 95824

ARCHITECTURE

HMC ARCHITECTS

2101 CAPITOL AVENUE, SUITE 100/ SACRAMENTO, CA 95816 T (916) 368-7990 / WWW.HMCARCHITECTS.COM

CIVII

WARREN CONSULTING ENGINEERS

1117 WINDFIELD WAY, #110/ EL DORADO HILLS, CA 95762 T (916) 985-1870

LANDSCAPE

MTW GROUP

2707 K STREET #201 / SACRAMENTO, CA 95816

RW CONSULTING ENGINEERS INC

1450 HARBOR BLVD, SUITE F, WEST SACRAMENTO, CA 95691

LP CONSULTING ENGINEERS

1209 PLEASANT GROVE BLVD. / ROSEVILLE, CA 95678

T (916) 771-0778

ELECTRICAL

T (916) 771-0778

LP CONSULTING ENGINEERS
1209 PLEASANT GROVE BLVD. / ROSEVILLE, CA 95678

PLUMBING

LP CONSULTING ENGINEERS

1209 PLEASANT GROVE BLVD. / ROSEVILLE, CA 95678 T (916) 771-0778

FOOD SERVICE

AMD FOOD SERVICE DESIGN

PO BOX 163 GARDEN VALLEY/ CA 95633 T (530)333-4606

FACILITY

MATSUYAMA ELEMENTARY SCHOOL 7680 WINDBRIDGE DRIVE SACRAMENTO, CA 95831

PROJECT:

MATSUYAMA ELEMENTARY SCHOOL MODERNIZATION

SHEET NAME:

COVER SHEET

DSA SUBMITT

DATE: **01/04/2024**

FIRE EXTINGUISHING SYSTEMS

FOR FIRE ALARM AND SIGNALING

STANDARD FOR FIRE TESTING OF 2005

FIRE EXTINGUISHING SYSTEMS (R2014)

AUDIBLE SIGNAL APPLIANCES 2003 ED.

1999 ED.

(R2005)

2002 ED.

(R2018)

2017 ED.

(CA AMENDED)

EQUIPMENT

ACCESSORIES

SYSTEMS

IMPAIRED

FOR PROTECTION OF

COMMERCIAL COOKING

SYSTEMS, INCLUDING

STANDARD FOR HEAT

DETECTORS FOR FIRE

PROTECTIVE SIGNALING

STANDARD FOR SIGNALING

DEVICES FOR THE HEARING

STANDARD FOR BLEACHERS,

SEATING AND GRANDSTANDS

REFER TO 2022 CBC (SFM) CHAPTER 35 AND CALIFORNIA FIRE

SEE CALIFORNIA BUILDING CODE, CHAPTER 35 FOR STATE OF

FOLDING AND TELESCOPING

FOR A COMPLETE LIST OF APPLICABLE NFPA STANDARDS

CALIFORNIA AMENDMENTS TO NFPA STANDARDS.

UNIFIED SCHOOL DISTRIC

HMC Architects

3186-070-000

AGENCY APPROVAL:

2101 CAPITOL AVENUE, SUITE 100. SACRAMENTO, CA, 95816 916 368 7990 / www.hmcarchitects.com

ISSUE **△ DESCRIPTION** DATE

C-25193

REN. 07/31/25

ANY EXISTING CONDITIONS SUCH AS DETERIORATION OR NON-COMPLYING CONSTRUCTION BE DISCOVERED WHICH IS NOT COVERED BY THE DSA APPROVED CONTRACT DOCUMENTS WHEREIN THE FINISHED WORK WILL NOT COMPLY WITH TITLE 24, CCR,, A CONSTRUCTION CHANGE DOCUMENT (CCD), OR A SEPARATE SET OF PLANS AND SPECIFICATIONS DETAILING

REQUIRED BY SECTION 4-338, PART 1, TITLE

EMPLOYED BY THE DISTRICT (OWNER) AND

CONTINUOUS INSPECTION OF WORK. THE

DUTIES OF THE INSPECTOR ARE DEFINED

IN SECTION 4-342, PART 1, TITLE 24, CCR.

A DSA ACCEPTED TESTING LABORATORY

DIRECTLY EMPLOYED BY THE DISTRICT

REQUIRED TESTS AND INSPECTIONS FOR

OWNER, INSPECTOR OR RECORD, AND THE

ANY FAILURES OF TESTS AND INSPECTIONS

ARE TO BE SUBMITTED TO DSA DISTRICT

DSA FIELD ENGINEER. THE REPORTS OF

THE PROJECT. THE REPORTS SHALL BE

SUBMITTED TO ARCHITECT OF RECORD

STRUCTURAL ENGINEER OF RECORD,

IMPROVEMENTS, ROAD AND ACCESS

REQUIREMENTS AND ENVIRONMENTAL

SAFETY DURING CONSTRUCTION SHALL

THE INTENT OF THESE DRAWINGS AND

SPECIFICATIONS IS THAT THE WORK OF

THE ALTERATION, REHABILITATION, OR

ACCORDANCE WITH TITLE 24, CCR. SHOULD

HEALTH CONSIDERATIONS SHALL COMPLY

(OWNER) SHALL CONDUCT ALL THE

A "DSA CERTIFIED" PROJECT INSPECTOR

APPROVED BY DSA SHALL PROVIDE

INSPECTOR TO BE CLASS 1.

STRUCTURAL ENGINEER.

GRADING PLANS, DRAINAGE

WITH ALL LOCAL ORDINANCES.

COMPLY WITH CFC CHAPTER 33.

RECONSTRUCTION IS TO BE IN

24 CCR.

FIELD CONDITIONS AT THE TIME OF

ERECTION BRACING, SHORING,

TEMPORARY SUPPORTS AND

DETAILS ON THE DRAWINGS.

EQUAL OR BETTER CONDITION.

PRIOR TO THE START OF WORK THE

CONTRACTOR SHALL COORDINATE

SATISFACTORILY RELATE TO ONE

ANOTHER. NOTIFY ARCHITECT

CANNOT BE COORDINATED.

BETWEEN THE REQUIREMENTS OF ALL

DISCIPLINES HEREIN AND BETWEEN THE

REQUIREMENTS OF ALL DRAWINGS AND

SPECIFICATIONS IN ORDER THAT ALL ITEMS

IMMEDIATELY REGARDING ANY ITEMS THAT

CONTRACTOR SHALL EXCERCISE EXTREME

CAUTION IN EXCAVATING AND TRENCHING

ON THIS SITE TO AVOID EXISTING DUCTS.

PIPING, CONDUIT, ETC. AND TO PREVENT

HAZARD TO PERSONNEL AND/OR TO

SCAFFOLDING IS THE SOLE

ALL MATERIALS AND WORKMANSHIP SHALL

COMPLY WITH ALL GOVERNING CODES,

ORDINANCES, REGULATIONS AND LAWS.

THE DESIGN ADEQUACY AND SAFETY OF

RESPONSIBILITY OF THE CONTRACTOR.

THE REQUIREMENTS OF LAWS, CODES,

THE MOST STRINGENT SHALL GOVERN.

ORDINANCES, RULES AND REGULATIONS,

IN NO CASE SHALL WORKING DIMENSIONS

BE SCALED FROM PLANS, SECTIONS OR

DETAILS MARKED 'TYPICAL' SHALL APPLY IN

ALL CASES UNLESS SPECIFICALLY NOTED

ENACT ALL MEASURES TO PROTECT AND

SAFEGUARD ALL EXISTING ELEMENTS TO

REMAIN FROM BEING DAMAGED. REPLACE

OR REPAIR EXISTING ELEMENTS DAMAGED

BY THE EXECUTION OF THIS CONTRACT TO

WHERE ANY CONFLICT OCCURS BETWEEN

PREPARATION.

AND SPECIFYING THE REQUIRED WORK SHALL BE SUBMITTED TO AND APPROVED BY DSA BEFORE PROCEEDING WITH THE WORK. (SECTION 4-317(C), PART 1, TITLE 24, CONTRACTOR IS TO REVIEW AND COMPLY WITH ALL REQUIREMENTS AND MITIGATION MEASURES SET FORTH IN BOTH THE ENVIRONMENTAL IMPACT REPORT

DISCIPLINE

A ARCHITECTURE

I INTERIORS

S STRUCTURAL

Q EQUIPMENT

P PLUMBING

M MECHANICAL

E ELECTRICAL

FA FIRE ALARM

AV AV EQUIPMENT

FP FIRE PROTECTION

K KITCHEN

T TELECOM

C CIVIL

SHEET TYPE

1 SITE PLAN

3 CEILING PLAN

4 ROOF PLAN

6 SECTIONS

9 SCHEDULES

10 DETAILS

FLOOR PLAN

0 CODE ANALYSIS, NOTES

5 EXTERIOR ELEVATIONS

7 ENLARGED PLANS

8 INTERIOR ELEVATIONS

DISCIPLINE SHEET TYPE

BUILDING LETTER,

(USER DEFINED)

USED ONLY IF REQUIRED.

IF NOT, COLUMN IS

OMITTED.

| A | A | 1 | 1 | 1 | A | . A

BULIDING LETTER FLOOR LEVEL OR SEGMENT

(IF APPLICABLE) SEQUENTIAL (IF APPLICABLE)

SEGMENT,

STATEMENT OF GENERAL CONFORMANCE

THE DRAWINGS OR SHEETS LISTED ON THE INDEX SHEET WITH AN (*) THIS DRAWING PAGE OF SPECIFICATIONS/CALCULATIONS

HAVE BEEN PREPARED BY OTHER DESIGN PROFESSIONALS OR CONSULTANTS WHO ARE LICENSED AND/OR AUTHORIZED TO PREPARE SUCH DRAWINGS IN THIS STATE. IT HAS BEEN EXAMINED BY ME FOR:

UL 521

CODE CHAPTER 80.

DESIGN INTENT AND APPEARS TO MEET THE APPROPRIATE REQUIREMENTS OF TITLE 24, CALIFORNIA CODE OF REGULATIONS AND THE PROJECT SPECIFICATIONS PREPARED BY ME. AND COORDINATION WITH MY PLANS AND SPECIFICATIONS AND IS ACCEPTABLE FOR INCORPORATION INTO THE CONSTRUCTION OF THIS PROJECT.

THE STATEMENT OF GENERAL CONFORMANCE "SHALL NOT BE CONSTRUED AS RELIEVING ME OF MY RIGHTS. DUTIES, AND RESPONSIBILITIES UNDER SECTIONS 17302 AND 81138 OF THE EDUCATION CODE AND SECTIONS 4-336, 4-341 AND 4-344" OF TITLE 24, PART 1. (TITLE 24, PART 1, SECTION 4-317 (B)) I CERTIFY THAT:

ALL DRAWINGS OR SHEETS LISTED ON THE SHEET INDEX WITH AN (*) IS/ARE IN GENERAL CONFORMANCE WITH THE PROJECT DESIGN AND HAS/HAVE BEEN COORDINATED WITH THE PROJECT PLANS AND SPECIFICATIONS.

FRP

ARCHITECT OR ENGINEER DESIGNATED TO BE IN GENERAL RESPONSIBLE CHARGE

CALIFORNIA AMENDMENTS)

PART 10, TITLE 24 C.C.R.

MARSHAL REGULATIONS.

2019 ASME A17.1/B44-19 SAFETY CODE FOR

ELEVATORS AND ESCALATORS

2020 ASME 18.1 - SAFETY STANDARD FOR

12,TITLE 24 C.C.R.

2022 CALIFORNIA EXISTING BUILDING CODE (CEBC),

2022 CALIFORNIA AMENDMENTS)

2022 CALIFORNIA GREEN BUILDING STANDARDS

(2021 INTERNATIONAL EXISTING CODE AND

CODE (CALGREEN), PART 11, TITLE 24 C.C.R.

TITLE 19 C.C.R., PUBLIC SAFETY, STATE FIRE

PLATFORM LIFTS AND STAIRWAY CHAIR LIFTS

2022 CALIFORNIA REFERENCED STANDARDS, PART | UL 464

ABBREVIATIONS

07-31-2025 EXPIRATION DATE C-25193 LICENSE NUMBER

STATE MAP

FIBERGLASS REINFORCED PLASTIC

FRT FIRE RETARDANT TREATED PAPER TOWEL DISPENSER FINISH SURFACE PARTITION FOOTING PNEUMATIC TUBE STATION / **GRAB BAR** GFRC **GLASS FIBER REINFORCED** POLYVINYL CHLORIDE PAVEMENT CONCRETE **GLASS TYPE QUARRY TILE** GLUE LAMINATED BEAM GLB RADIUS, RISER GYP BD GYPSUM BOARD **RESILIENT BASE** GYP PLAS GYPSUM PLASTIC ROOF DRAIN ECEPTACLE **HOSE BIBB** RECEP. REFERENCE **HEAVY DUTY** HDR REFLECT(ED), (IVE HEADER HDWR HARDWARE REFLECT(ED), (IVE) HGT REFRIGERATOR **HOLLOW METAL** REINF REINFORCE/REINFORCED/ HIGH POINT REINFORCEMENT HSS HOLLOW STEEL SECTION REMOVE INSIDE DIAMTER **ROUND HEAD ROUND HEAD SCREW** INTERIOR INVFRT ROUGH OPENING LANDS LANDSCAPE RIGHT OF WAY LAVATORY SCHEDULE (FOR PIPE) SCHED LLH LONG LEG HORIZONTAI SCHEDULE / SCHEDULING LLV LONG LEG VERTICAL STORM DRAIN / SOAP DISPENSER SECT LOW POINT SECTION LT WT LIGHT WEIGHT SAFETY GLASS LOUVER MACH MACHINE SHEATHING

S LAND PARK DR. PROJECT SITE-RUSH RIVER DR. LAKE FRONT DR.

SACRAMENTO RIVER—

OVERALL SITE PLAN

(E) BLDG. 6

VICINITY MAP

MATSUYAMA ELEMENTARY SCHOOL **7680 WINDBRIDGE DRIVE SACRAMENTO, CA 95831**

MATSUYAMA ELEMENTARY SCHOOL MODERNIZATION

SHEET NAME: PROJECT DATA SHEET

DSA SUBMITTAL

DATE: 01/04/2024

CLIENT PROJ NO: 3186-070-000

PLEASE RECYCLE 🕉

EXISTING UNDERGROUND UTILITIES OR STRUCTURES. THE CONTRACTOR SHALL IMMEDIATELY NOTIFY THE ARCHITECT SHOULD SUCH UNIDENTIFIED CONDITIONS BE DISCOVERED. THESE DRAWINGS AND SPECIFICATIONS DO NOT INCLUDE THE NECESSARY COMPONENTS FOR CONSTRUCTION SAFETY. CHANGES TO THE APPROVED DRAWINGS AND/OR SPECIFICATIONS SHALL BE MADE (ADDENDUM TO THE ENVIRONMENTAL BY ADDENDA OR A CHANGE ORDER. CUTTING, BORING, SAWCUTTING OR IMPACT REPORT | SCH NO. 2002071120) DRILLING THROUGH THE EXISTING OR NEW NO DUMPING OR PLACING OF ANY DIRT OR STRUCTURAL ELEMENTS SHALL NOT TO BE DEBRIS SHALL BE ALLOWED OUTSIDE OF THE CONTRACTORS LIMIT OF WORK AREA. STARTED UNTIL THE DETAILS HAVE BEEN REVIEWED AND APPROVED BY THE ARCHITECT, AND STRUCTURAL ENGINEER OF RECORD. SYMBOL LEGEND **NORTH ARROW** WALL TYPE CALLOUT AS6A WALL TYPE MARK - SEE A10.11 TICK INDICATES PLAN NORTH WALL STC RATING ARROW INDICATES TRUE NORTH WALL FIRE RATING TYPE **ELEVATION CALLOUT MATCHLINE REFERENCE** LOCATION ON SHEET LOCATION ON SHEET SHEET WHERE ELEVATION IS DRAWN SHEET WHERE PLAN IS DRAWN **ELEVATION CALLOUT KEYNOTE** LOCATION ON SHEET KEYNOTE NUMBER (SEE LEGEND ON SHEET) SHEET WHERE ELEVATION IS DRAWN **ROOM EXITING INFORMATION ELEVATION CALLOUT - ALT.** AREA (SQ FT) 18/AX.XX● **LOCATION & SHEET WHERE ELEVATION IS DRAWN** OCCUPANT LOAD (AREA DIVIDED BY LOAD FACTOR) OCCUPANT LOAD FACTOR (REFER TO TABLE 1004.5) **SECTION CALLOUT** OCCUPANCY TYPE INDICATES A SIMILAR CONDITION NUMBER OF EXITS REQUIRED (REFER TO TABLE 1006.2.1) LOCATION ON SHEET SHEET WHERE SECTION IS DRAWN WIC CASEWORK TAG MANUFACTURER REFERENCE AND MODEL NUMBER **DETAIL CALLOUT** INDICATES A SIMILAR CONDITION AX.XX LOCK LOCATION ON SHEET CABINET DEPTH SHEET WHERE SECTION IS DRAWN **CABINET HEIGHT CABINET WIDTH CONTROL OR DATUM POINT** — NAME OF ELEVATION (IF APPLICABLE) FIRST FLOOR • +0' - 0" •

EXISTING **ANCHOR BOLT** AC PAVING ASPHALTIC CONCRETE PAVING ACCESS/ACCESSIBLE ACOUSTICAL CEILING PANEL ACOUSTICAL CEILING TILE ADJACENT/ADJUSTABLE ABOVE FINISH FLOOR AGGREGATE AIR HANDLING UNIT **ARCH** ARCHITECTURAL ATTENUATION AUTO AUTOMATIC BLOCKING BUR BUILT UP ROOFING CABT **CUBIC FEET** CFCI CONTRACTOR FURNISHED CONTRACTOR INSTALLED CFOI CONTRACTOR FURNISHED OWNER INSTALLED CORNER GUARD **CONTROL JOINT** CENTER LINE CHAIN LINK FENCE CMU CONCRETE MASONRY UNIT CLEANOUT COMP COMPRESSION / COMPOSITE COORD COORDINATE CORR CORRUGATED CERAMIC TILE COUNTER SKUNK CURTAINWALL **DEPRESSED / DEPRESSION** DRINKING FOUNTAIN DIMENSION DISPENSER DOWNSPOUT DISHWASHER EACH WAY EXTERIOR INSULATION FINISH SYSTEM **EXPANSION JOINT ELECTRICAL ELEV** ELEVATION / ELEVATOR **ENCL** ENCLOSE / ENCLOSURE EOS EDGE OF SLAB **ELECTRICAL PANEL** EXCUTCHEON ELECTRIC WATER COOLER EXPOSED FIRE ALARM FLOOR DRAIN FIRE DEPARTMENT CONNECTION FIRE EXTINGUISHER FIRE EXTINGUISHER W/ CABINET FINISH FLOOR FINISH GRADE FIRE HYDRANT FIRE HOSE CABINET FLAT HEAD SCREW FINISH FLR FLOOR FACE OF CONCRETE FACE OF FINISH

FACE OF MASONRY

FIRE RATED GLASS

FACE OF STUD FIREPROOFING

FIRE RATED

FOS

FRG

MACHINE BOLT MDF MEDIUM DENSITY FIBERBOARD MDO MEDIUM DENSITY OVERLAY MECH MECHANICAL MED MEDIUM MEMB MEMBRANE MFR MANUFACTURER MANHOLE MASONRY OPENING MO MTD MOUNTED MTL METAL NOT IN CONTRACT NON RATED NRC NOISE REDUCTION COEFFICIENT NTS NOT TO SCALE OVFR OVERALL ON CENTER OUTSIDE DIAMTER OFCI OWNER FURNISHED, CONTRACTOR **INSTALLED** OWNER FURNISHED, OWNER OFOI **INSTALLED** OWNER FURNISHED, VENDOR INSTALLED OPPOSITE HAND OPER OPERABLE OVERFLOW ROOF DRAIN ORD PROPERTY LINE PUBLIC ADDRESS POWDER ACTUATED FASTENER PAF PAVING PCC PORTLAND CEMENT CONCRETE PAVING PEDESTRIAN PERF PERFORATED PERIM PERIMETER PERP PERPENDICULAR PH PANIC HARDWARE PIV PLASTIC LAMINATE PLAM PLAS PLASTER PLUMB PLUMBING PNL PANEL PNT PAINT / PAINTED POC

STC STSMS SCREW SUSP SYM U/C VTR VWC W/O WB WC WD WDW WGT WH WRGB

SHEET METAL SCREW SANITARY NAPKIN DISPOSAL SHUT OFF VALVE **SPECIFICATIONS** STAINLESS STEEL SOUND TRAMISSION CLASS SELF TAPPING SHEET METAL SHEET VINYL SYMMETRICAL **TOP AND BOTTOM** TOP OF TOP OF CURB / CONCRETE TOP OF PARAPET TOP OF STEEL TOP OF WALL TOILET PAPER DISPENSER TACKABLE SURFACE **UNLESS NOTED OTHERWISE** VACUUM VAPOR BARRIER VINYL COMPOSITION TILE VERIFY IN FIELD **VENT THROUGH ROOF** VINYL WALL COVERING WITHOUT WOOD BASE WATER CLOSET WOOD WINDOW WEIGHT WATER HEATER WATERPROOFING/WALL PROTECTION WATER RESISTANT

UNDER CABINET (OR COUNTER

POST TENSIONED CONCRETE

WATER RESISTANT GYPSUM **WOOD SCREW**

WAINSCOT WELDED WIRE FABRIC

OTHER ABBREVIATIONS USED ON THESE DRAWINGS ARE CONSIDERED STANDARDS IN

WINDOW CALLOUT WINDOW NUMBER 09-WF1 (SEE WINDOW SCHEDULE)

- ELEVATION ABOVE FINISHED FLOOR

EXISTING BUILDING GRID SYMBOL

INTERIOR FINISH CALLOUT

NEW BUILDING GRID SYMBOL

GRID BUBBLE

DOOR CALLOUT

MATERIAL FINISH TYPE

(SEE FINISH SCHEDULE)

DOOR NUMBER

(101A)

FA

GRID NUMBER

POST INDICATOR VALVE WSCT WWF POINT OF CONNECTION

POLY ISO POLYISOCYANURATE PREFIN

PREP

PREFINISHED PREP / PREPARATION

THE BUILDING INDUSTRY. CONTACT ARCHITECT FOR NECESSARY CLARIFICATION.

DRAWING LIST

NUMBER NAME GENERAL SHEET G0.10 COVER SHEET PROJECT DATA SHEET G0.13 SHEET INDEX G1.11 CODE SITE PLAN CIVIL C0.1 DETAILS C0.2 PARTIAL TOPOGRAPHIC SURVEY C0.3 PARTIAL TOPOGRAPHIC SURVEY PARTIAL DEMOLITION PLAN C1.2 PARTIAL DEMOLITION PLAN C1.3 ENGINEERED FILL PLAN PARTIAL GRADING PLAN PARTIAL GRADING PLAN UTILITY PLAN PAVING PLAN DETAILS LANDSCAPE LD1.1 TREE PROTECTION PLAN TREE PROTECTION PLAN IRRIGATION DEMOLITION PLAN IRRIGATION DEMOLITION PLAN TREE PLANTING PLAN SHRUB/TURF PLANTING PLAN SHRUB/TURF PLANTING PLAN LANDSCAPE IRRIGATION PLAN L3.2 LANDSCAPE IRRIGATION PLAN LANDSCAPE PLANTING DETAIL LANDSCAPE IRRIGATION DETAIL LANDSCAPE IRRIGATION DETAIL IRRIGATION CHARTS AND SHADING CALCULATION SITE DEMOLITION PLAN PROJECT SITE PLAN PARTIAL SITE PLAN SEGMENT - 1 PARTIAL SITE PLAN SEGMENT - 2 ENLARGED SITE PLAN DEMOLITION AND IMPROVEMENT FLOOR PLANS -DEMOLITION AND IMPROVEMENT FLOOR PLANS -DEMOLITION AND IMPROVEMENTN FLOOR PLANS -BLDG 3,4 DEMOLITION AND IMPROVEMENT FLOOR PLANS -BLDG 5,6 DEMOLITION AND IMPROVEMENT FLOOR PLANS -BLDG 7,8 DEMOLITION AND IMPROVEMENT FLOOR PLANS -BLDG 9,11 DEMOLITION REFLECTED CEILING PLAN - BLDG A,B IMPROVEMENT REFLECTED CEILING PLAN - BLDG A,B EXTERIOR ELEVATIONS EXTERIOR ELEVATIONS EXTERIOR ELEVATIONS EXTERIOR ELEVATIONS EXTERIOR ELEVATIONS ENLARGED PLANS INTERIOR ELEVATIONS INTERIOR ELEVATIONS INTERIOR ELEVATIONS INTERIOR ELEVATIONS INTERIOR IMAGES FINISH SCHEDULE SITE DETAILS - MISC SITE DETAILS - MISC INTERIOR DETAILS S4.02 DETAILS MECHANICAL DEMOLITION AND IMPROVEMENT FLOOR PLANS - BLDG 1 MECHANICAL DEMOLITION AND IMPROVEMENT FLOOR PLANS - BLDG 2 MECHANICAL DEMOLITION AND IMPROVEMENT FLOOR PLANS - BLDG 3, 4 MECHANICAL DEMOLITION AND IMPROVEMENT FLOOR PLANS - BLDG 5, 6 FLOOR PLANS - BLDG 7, 8 MECHANICAL DEMOLITION AND IMPROVEMENT FLOOR PLANS - BLDG 9, 11 MECHANICAL DEMOLITION AND IMPROVEMENT FLOOR PLANS - BLDG 10 MECHANICAL DEMOLITION AND IMPROVEMENT ROOF M4.11 PLANS - BLDG 1 MECHANICAL DEMOLITION AND IMPROVEMENT ROOF PLANS - BLDG 2 MECHANICAL DEMOLITION AND IMPROVEMENT ROOF PLANS - BLDG 3, 4 MECHANICAL DEMOLITION AND IMPROVEMENT ROOF PLANS - BLDG 5, 6 MECHANICAL DEMOLITION AND IMPROVEMENT ROOF PLANS - BLDG 7, 8 MECHANICAL ENLARGED FLOOR PLANS - BLDG 1 M5.11 MECHANICAL KITCHEN EQUIPMENT DRAWINGS MECHANICAL KITCHEN EQUIPMENT DRAWINGS M7.01 MECHANICAL CONTROLS MECHANICAL CONTROLS MECHANICAL CONTROLS MECHANICAL DETAILS MECHANICAL DETAILS

NUMBER NAME

PLUMBING LEGEND AND NOTES P0.02 PLUMBING SCHEDULES P1.11 PLUMBING SITE PLAN P2.11 PLUMBING DEMOLITION AND IMPROVEMENT FLOOR PLANS - BLDG 1 P2.12 PLUMBING DEMOLITION AND IMPROVEMENT FLOOR PLANS - BLDG 2

PLUMBING DEMOLITION AND IMPROVEMENT ROOF

PLUMBING ENLARGED FLOOR PLANS - BLDG 1

PLUMBING DEMOLITION AND IMPROVEMENT FLOOR PLANS - BLDG 5, 6 PLUMBING DEMOLITION AND IMPROVEMENT FLOOR PLANS - BLDG 7, 8 PLUMBING DEMOLITION AND IMPROVEMENT FLOOR PLANS - BLDG 9, 11 PLUMBING DEMOLITION AND IMPROVEMENT FLOOR PLANS - BLDG 10

PLANS - BLDG 1

PLUMBING DETAILS

ELECTRICAL NOTES

ELECTRICAL LEGENDS

ELECTRICAL SITE PLAN

FLOOR PLANS - BLDG 1

FLOOR PLANS - BLDG 2

FLOOR PLANS - BLDG 4

FLOOR PLANS - BLDG 8

FLOOR PLANS - BLDG 10

PLANS - BLDG 1

PLANS - BLDG 2

PLANS - BLDG 5

PLANS - BLDGS 7

ELECTRICAL DETAILS

T24.03 TITLE 24 COMPLIANCE - BUILDING 9 T24.04 TITLE 24 COMPLIANCE - BUILDING 9

T24.05 TITLE 24 COMPLIANCE - BUILDING 10

T24.06 TITLE 24 COMPLIANCE - BUILDING 10 T24.07 TITLE 24 COMPLIANCE - BUILDING 11

T24.08 TITLE 24 COMPLIANCE - BUILDING 11

FS1.1 FOOD SERVICE EQUIPMENT FLOOR PLAN

T24.09 TITLE 24 COMPLIANCE - KITCHEN T24.10 TITLE 24 COMPLIANCE - KITCHEN

SITE LIGHTING

SITE LIGHTING

USA SHADE STRUCTURE - P.C. 04-121917

P.C.T-1.0 P.C. TITLE SHEET

P.C.T-3.0 P.C. T & I FORMS

P.C.2.1-1000 P.C. DSA3013030-22

P.C.2.2-2000 P.C. DSA4013030-22

P.C.4.2-2000 P.C. DSA4014040-22

P.C.4.1-1000 P.C.4014040-22

Grand total: 148

P.C.T-2.0 P.C. UNIT SELECTION

KITCHEN

FLOOR PLANS - BLDGS 9, 11

ELECTRICAL ENLARGED SITE PLAN

ELECTRICAL PHOTOMETRIC SITE PLAN

ELECTRICAL DEMOLITION AND IMPROVEMENT

ELECTRICAL DEMOLITION AND IMPROVEMENT ROOF

TITLE 24 COMPLIANCE - ELECTRICAL BUILDING 2 AND

T24.12 TITLE 24 COMPLIANCE - ELECTRICAL BUILDING 2 AND

FOOD SERVICE EQUIPMENT PLUMBING PLAN

FOOD SERVICE EQUIPMENT ELECTRICAL PLAN

FOOD SERVICE EQUIPMENT EXHAUST HOOD

FOOD SERVICE EQUIPMENT EXHAUST HOOD

FOOD SERVICE EQUIPMENT ELEVATIONS

FOOD SERVICE EQUIPMENT ANCHORAGE DETAILS FOOD SERVICE EQUIPMENT ANCHORAGE DETAILS FOOD SERVICE EQUIPMENT ANCHORAGE DETAILS

FOOD SERVICE EQUIPMENT MECHANICAL PLAN FOOD SERVICE EQUIPMENT EXHAUST HOOD

ELECTRICAL ENLARGED FLOOR PLANS - BLDG 1

ELECTRICAL FIXTURE AND PANEL SCHEDULES

ELECTRICAL ONE-LINE DIAGRAM

TITLE 24 COMPLIANCE - BUILDING 8

TITLE 24 COMPLIANCE - BUILDING 8

ELECTRICAL LIGHTING SITE PLAN

KITCHEN

12

E0.01

E0.02

E1.11

E1.12

E5.11

E7.01

E8.01

TITLE 24

20

12

FS5.1

FS5.2

FS5.3

FS9.1

FOOD SERVICE

ELECTRICAL

C2.2

C3.1 C4.1 C5.1

LD1.2 LD2.2 L2.1 L2.2 L3.1

L4.1 L4.2

L5.1 13

ARCHITECTURE A1.22 A1.23

A1.31 A2.11 A2.12

A2.13 A2.14

A2.16

A4.11A ROOF PLAN - BLDG 1,2,3 A4.11B ROOF PLAN - BLDG 4,5,6,7

A5.12 A7.11

A8.12 A8.13 A8.14 A9.12 A10.01

A10.02 A10.03 A10.04 SIGNAGE DETAILS

STRUCTURAL S0.01 TYPICAL STRUCTURAL NOTES S2.01 STRUCTURAL PLAN - BUILDING 1 S4.01 DETAILS

MECHANICAL M0.01 MECHANICAL LEGEND AND NOTES M0.02 MECHANICAL SCHEDULES M1.11 MECHANICAL SITE PLAN

M2.15 MECHANICAL DEMOLITION AND IMPROVEMENT

M7.02 M7.03 M8.01 M8.02

PLUMBING

AGENCY APPROVAL:

UNIFIED SCHOOL DISTRICT

C-25193

REN. 07/31/25

DATE

HMC Architects

3186-070-000

2101 CAPITOL AVENUE, SUITE 100, SACRAMENTO, CA, 95816 916 368 7990 / www.hmcarchitects.com

ISSUE

△ **DESCRIPTION**

KEYNOTES

NOTES

MATSUYAMA ELEMENTARY SCHOOL **7680 WINDBRIDGE DRIVE** SACRAMENTO, CA 95831

MATSUYAMA ELEMENTARY SCHOOL MODERNIZATION

SHEET NAME: **SHEET INDEX**

DSA SUBMITTAL

DATE: 01/04/2024

LEGEND

ACCESSIBLE PATH OF TRAVEL / PATH OF TRAVEL TO PUBLIC WAY

————— ASSUMED PROPERTY LINE

EXISTING BUILDINGS IN SCOPE OF WORK

EXISTING ACCESSIBLE RESTROOMS

SAFE DISPERSAL AREA

= EXISTING PARKING LOT = EXISTING BOYS RESTROOM


= EXISTING DRINKING FOUNTAIN

CONCRETE PAVEMENT

PLANTING, SEE LANDSCAPE DWGS

SYNTHETIC RUBBERIZED RUNNING TRACK, SEE CIVIL



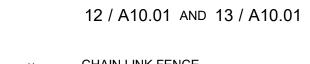



PATH OF TRAVEL STATEMENT

FREE ACCESS ROUTE WITHOUT ANY ABRUPT VERTICAL CHANGES EXCEEDING 1/2" BEVELED AT 1:2 MAXIMUM SLOPE EXCEPT LEVEL CHANGES THAT DO NOT EXCEED 1/4" VERTICAL. THE PATH OF TRAVEL IS AT LEAST 48" WIDE WITH SLIP RESISTANT SURFACE, STABLE, FIRM AND SMOOTH. CROSS-SLOPE DOES NOT EXCEED 2% AND SLOPE IN THE DIRECTION OF TRAVEL IS LESS THAN 5% UNLESS OTHERWISE INDICATED. THE PATH OF TRAVEL SHALL BE MAINTAINED FREE OF OVERHANGING OBSTRUCTION TO 80" A.F.F. MINIMUM AND WALL MOUNTED OBJECTS WITH THE BOTTOM EDGE BETWEEN 27" AND 80" A.F.F. MINIMUM AND WALL MOUNTED OBJECTS WITH THE BOTTOM EDGE BETWEEN 27" AND 80" A.F.F. SHALL PROTRUDE NO MORE THAN 4" INTO THE PEDESTRIAN CIRCULATION AREA. ARCHITECT TO VERIFY THAT ALL BARRIERS IN THE PATH OF TRAVEL HAVE BEEN REMOVED OR WILL BE REMOVED UNDER PROJECT, AND

DESIGN PROFESSIONAL IN GENERAL RESPONSIBLE THE P.O.T. IDENTIFIED IN THESE CONSTRUCTION DOCUMENTS IS COMPLIANT WITH THE CURRENT APPLICABLE CALIFORNIA BUILDING CODE ACCESSIBILITY PROVISIONS FOR PATH OF TRAVEL REQUIREMENTS FOR ALTERNATIONS, ADDITIONS AND STRUCTURAL REPAIRS. AS PART OF THE DESIGN OF THIS PROJECT, THE P.O.T. WAS EXAMINED AND ANY ELEMENTS, COMPONENTS OR PORTIONS OF THE P.O.T. THAT WERE DETERMINED TO BE NONCOMPLIANT 1) HAVE BEEN IDENTIFIED AND 2) THE CORRECTIVE WORK NECESSARY TO BRING THEM INTO COMPLIANCE HAS BEEN INCLUDED WITHIN THE SCOPE OF THIS PROJECT'S WORK THROUGH DETAILS, DRAWINGS, AND SPECIFICATIONS INCORPORATED INTO THESE CONSTRUCTION DOCUMENTS. ANY NONCOMPLIANT ELEMENTS, COMPONENTS, OR PORTIONS OF THE P.O.T. THAT WILL NOT BE CORRECTED BY THIS PROJECT BASED ON VIOLATION OF THRESHOLD LIMITATIONS OR A FINDING OF UNREASONABLE HARDSHIP ARE SO INDICATED IN THESE CONSTRUCTION

DURING CONSTRUCTION, IF P.O.T. ITEMS WITHIN THE



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ISSUE △ **DESCRIPTION**

C-25193 REN. 07/31/25

DATE

KEYNOTES

(E) FIRE HYDRANT (E) ACCESSIBLE PARKING SIGN DROP OFF AREA (E) KNOX BOX 32.23 (E) PARKING LOT ENTRANCE SIGN (E) VAN ACCESSIBLE PARKING SIGN

NOTES

PATH OF TRAVEL (P.O.T.) AS INDICATED, IS A BARRIER

PATH OF TRAVEL COMPLIES WITH CBC 1133B.

SCOPE OF THE PROJECT PRESENTED AS CODE COMPLIANT ARE FOUND TO BE NONCONFORMING BEYOND REASONABLE CONSTRUCTION TOLERANCES, THEY SHALL BE BROUGHT INTO COMPLIANCE WITH THE CBC AS PART OF THIS.

CODE ANALYSIS SITE PLAN

MATSUYAMA ELEMENTARY SCHOOL **7680 WINDBRIDGE DRIVE SACRAMENTO, CA 95831**

PROJECT:

MATSUYAMA ELEMENTARY SCHOOL MODERNIZATION

SHEET NAME: **CODE SITE PLAN**

DSA SUBMITTAL

DATE: 01/04/2024



- WARREN CONSULTING ENGINEERS, INC. (WCE) ASSUMES NO RESPONSIBILITY FOR ERRORS IN PHYSICAL LOCATION OF IMPROVEMENTS, HORIZONTAL OR VERTICAL, IF STAKED BY OTHERS. IN ADDITION, ANY SUCH ERRORS IN PHYSICAL LOCATION MAY AFFECT THE INTENDED DESIGN OF SUCH IMPROVEMENTS AND WCE CANNOT BE HELD RESPONSIBLE FOR SUCH CONDITIONS WHICH ARE A RESULT OF ERRORS IN SURVEYING OR IMPROPER CONSTRUCTION.
- 3. IF SUBSURFACE CULTURAL RESOURCES, REMAINS, AND/OR ARTIFACTS ARE UNCOVERED DURING PROJECT CONSTRUCTION, ALL WORK IN THE VICINITY SHALL BE STOPPED UNTIL SUCH ITEMS CAN BE ASSESSED BY AN APPROPRIATE MEMBER OF THE COUNTY ENVIRONMENTAL IMPACT SECTION STAFF.
- CONTRACTOR AGREES THAT HE/SHE SHALL ASSUME SOLE AND COMPLETE RESPONSIBILITY FOR JOB SITE CONDITIONS DURING THE COURSE OF CONSTRUCTION OF THIS PROJECT, INCLUDING SAFETY OF ALL PERSONS AND PROPERTY: THAT THIS REQUIREMENT SHALL APPLY CONTINUOUSLY AND SHALL NOT BE LIMITED TO NORMAL WORKING HOURS: AND THAT THE CONTRACTOR SHALL DEFEND, INDEMNIFY AND HOLD THE OWNER AND ENGINEER HARMLESS FROM ANY AND ALL LIABILITY, REAL OR ALLEGED, IN CONNECTION WITH THE PERFORMANCE OF WORK ON THIS PROJECT, EXCEPTING FOR LIABILITY ARISING FROM THE SOLE NEGLIGENCE OF THE OWNER OR ENGINEER.
- THE CONTRACTOR SHALL OBTAIN AN EXCAVATION PERMIT FROM THE STATE OF CALIFORNIA DEPARTMENT OF INDUSTRIAL SAFETY FOR ALL EXCAVATIONS OF 5 FEET OR MORE IN DEPTH.
- 6. IT SHALL BE THE CONTRACTOR'S RESPONSIBILITY TO MAKE ALL NECESSARY PRE-BID AND PRE-CONSTRUCTION SITE INSPECTION, AND/OR OBSERVATIONS ON THE SITE TO PRE-DETERMINE ALL HIS/HER MEANS AND METHODS NECESSARY TO COMPLETE THE IMPROVEMENTS SHOWN ON THESE PLANS AND PER THE PROJECT SPECIFICATIONS. IT IS THE CONTRACTORS RESPONSIBILITY TO DETERMINE, AND INCLUDE IN HIS/HER CONTRACT, ALL MEANS AND METHODS NECESSARY TO PERFORM A COMPLETE AND ACCEPTABLE JOB.
- WHERE IMPROVEMENTS LIE WITHIN AN EXISTING DEVELOPED AREA, CONTRACTOR SHALL USE CAUTION WHEN ACCESSING THE SITE THROUGH THESE EXISTING IMPROVEMENTS. IT IS THE CONTRACTORS RESPONSIBILITY TO PROTECT ANY SUCH EXISTING IMPROVEMENTS OUTSIDE THE PROJECT BOUNDARY, OR EXISTING IMPROVEMENTS WITHIN THE BOUNDARY WHICH ARE TO REMAIN. PROPER PRECAUTIONS SHALL BE PROVIDED AND MAINTAINED THROUGHOUT CONSTRUCTION. ANY DAMAGE SHALL BE REPAIRED OR REPLACED TO THE SATISFACTION OF THE OWNER.
- 8. IT IS THE RESPONSIBILITY OF THE CONTRACTOR TO KEEP DETAILED RECORDS OF MINOR CHANGES OR ADJUSTMENTS MADE DURING CONSTRUCTION (WHICH WERE NOT FORMALLY ISSUED). UPON PROJECT COMPLETION, THESE RECORDS AND/OR INFORMATION SHALL BE PROVIDED TO THE OWNER AND WARREN CONSULTING ENGINEERS, INC. UNLESS AN OFFICIAL "AS-BUILT" SET OF PLANS IS A REQUIREMENT OF THE CONTRACT. IF AS-BUILT PLANS ARE A REQUIREMENT OF THE CONTRACT, REFER TO SPECIFICATIONS FOR AS-BUILT DELIVERABLE REQUIREMENTS.
- IN VEHICULAR PATHWAYS, EXISTING ASPHALTIC AND/OR CONCRETE SURFACES SHALL BE CUT TO A NEAT AND STRAIGHT LINE, PARALLEL OR PERPENDICULAR TO THE VEHICULAR TRAVELED PATH. THIS IS TYPICALLY THE ROADWAY CENTERLINE, BUT MAY VARY. THAT SAWCUT EDGE SHALL BE PROTECTED FROM DAMAGE DURING CONSTRUCTION SO A CLEAN EDGE REMAINS FOR PATCH BACK.. IF EDGE IS DAMAGED, A NEW SAW CUT WILL BE REQUIRED. THE EXPOSED EDGE SHALL BE "TACKED" WITH EMULSION PRIOR TO PAVING.
- NO BURNING OR BLASTING SHALL BE ALLOWED ONSITE UNLESS SPECIFICALLY ADDRESSED ON PLANS, OR SPECIFICALLY APPROVED AND COORDINATED WITH THE ARCHITECT, ENGINEER, AND LOCAL AGENCY OR OTHER ADMINISTRATIVE AUTHORITY.
- SUBGRADE AND RESULTING FINISHED GRADE SHALL BE CONSTRUCTED SMOOTH AND UNIFORM BETWEEN SPOT ELEVATIONS, CONTOURS OR OTHER STRUCTURE ELEVATIONS SHOWN ON GRADING OR OTHER PLANS. NO MOUNDS, RUTS, DEPRESSIONS OR OTHER GRADING DEFICIENCIES WILL BE ALLOWED UNLESS SPECIFICALLY SHOWN ON PLANS.
- 12. ON NEW WATER SYSTEMS, SERVICE LATERALS SHALL BE MADE USING APPROPRIATE "TEE" AND "WYE" FITTINGS. SADDLE TAPS WILL ONLY BE ALLOWED WHEN MAKING CONNECTIONS TO EXISTING WATER MAINS.
- CURING COMPOUND SHALL BE APPLIED IN A CONTINUOUS SOLID WET FLOWING COAT. ANY "SPOTTY" APPLICATIONS SHALL BE RECOATED IMMEDIATELY. APPLICATION SHALL BE INSPECTED BY PROJECT INSPECTOR DURING APPLICATION.
- EMBEDMENT OF FEATURES IN CONCRETE PAVING, CURBS, OR WALLS, SUCH AS SQUARE OR ROUND TUBING, POSTS, OR COLUMNS, STEEL BOLTED PLATES, OR OTHER STRUCTURES, SHALL REQUIRE ADDITIONAL SCORE OR EXPANSION JOINTS TO PREVENT UNCONTROLLED CRACKING. THOSE ADDITIONAL JOINTS MAY OR MAY NOT BE SPECIFICALLY SHOWN ON PLANS BUT SHALL BE PROVIDED BY THE CONTRACTOR.
- 15. EMBEDMENT OF FEATURES IN CONCRETE PAVING, CURBS, OR WALLS, SUCH AS SQUARE OR ROUND TUBING, POSTS, OR COLUMNS, STEEL BOLTED PLATES, OR OTHER STRUCTURES, SHALL REQUIRE A MINOR ADJUSTMENT OF REBAR WITHIN CONCRETE TO ALLOW FOR SUCH STRUCTURE. THAT REBAR ADJUSTMENT MAY NOT BE SPECIFICALLY SHOWN ON PLANS.
- 16. NO MORE THAN 1 GALLON OF WATER PER YARD OF CONCRETE CAN BE ADDED TO THE TRUCK AFTER ARRIVAL TO PROJECT SITE. THE ADDITION OF WATER CAN ONLY BE ADDED UNDER THE SUPERVISION OF THE CONCRETE INSPECTOR OR LABORATORY TECHNICIAN.
- WHEN PUMPING CONCRETE FOR PLACEMENT, ABSOLUTELY NO WATER IS TO BE ADDED TO PUMP HOPPER. ANY WATER ADDED TO HOPPER WILL BE REASON FOR CONCRETE REJECTION AT THE CONTRACTORS
- 18. ALL CONTRACTION/CONSTRUCTION JOINTS "CJ" SHALL BE 1/4 THE SLAB THICKNESS DEEP, BUT NO LESS THAN 1" FOR CONTROLLING OF CRACKING. CONTRACTOR SHALL EXERCISE CAUTION WHEN FINAL TROWELING OF CONCRETE SO AS NOT TO FILL IN THESE JOINTS WITH CONCRETE CREAM. ANY CRACKS OUTSIDE OF JOINTS WHICH WERE CONSTRUCTED LESS THAN 1" DEEP, SHALL BE CAUSE FOR CONCRETE SLAB(S) TO BE REMOVED AND REPLACE AT CONTRACTORS EXPENSE.
- 19. ANY SCREED BOARDS SET WITHIN CONCRETE SLABS SHALL BE AN "OVERHEAD SCREED" SO THERE IS NO INTERFERENCE WITH THE PLACEMENT AND ALIGNMENT OF SLAB REINFORCING.
- 20. 3-1/2" FELT JOINTS WILL NOT BE ACCEPTED. PROVIDE A FULL 4" FELT JOINT FOR 4" SLAB CONSTRUCTION, AND A 6" FELT JOINT FOR A 6" SLAB SLAB CONSTRUCTION.
- SHOULD ANY SHRINKAGE CRACKS OCCUR OUTSIDE OF EITHER THE EXPANSION JOINTS OR CRACK CONTROL JOINTS, THEN THE CONCRETE SLAB SHALL BE SAWCUT AT THE NEAREST JOINTS ON EACH SIDE OF THE CRACK AND THE CONCRETE SECTION SHALL BE, REMOVED AND REPLACED. NEW CONCRETE SHALL BE DOWELED INTO EXISTING CONCRETE PER DRAWING DETAIL.
- 22. ALL AREAS DISTURBED BY GRADING OPERATIONS WHETHER SHOWN ON THE DRAWINGS OR NOT SHALL BE HYDRO SEEDED UNLESS OTHERWISE NOTED. HYDRO SEEDING SHALL CONFORM TO LOCAL CITY/COUNTY
- 23. REPAIR OR PATCHING OF GALVANIZED METALS, SUCH AS AFTER WELDING GALVANIZED COMPONENTS, SHALL BE MADE USING A ZINC COMPOSITION "HOT STICK" APPLICATION PER ASTM A 780-01. GALVANIZING PAINTS WILL NOT BE ALLOWED.

GENERAL PAVING SURFACE NOTES:

- 1. PROVIDE EQUIVALENT OF MEDIUM BROOM FINISH AT SLOPES UP TO 5.99%, TYPICAL. PROVIDE EQUIVALENT OF HEAVY BROOM FINISH AT SLOPES 6% AND GREATER. REFER TO SPECIFICATIONS.
- 2. ALL NEW PEDESTRIAN WALKWAYS (NON-RAMP) SHALL BE SLOPED NO GREATER THAN 2.0%, AND NO LESS THAN 0.75% IN ANY DIRECTION, UNLESS SPECIFICALLY LABELED OTHERWISE. ALL CONCRETE SHALL MEET THE FOLLOWING SLOPE REQUIREMENTS: - NO GREATER THAN 5% SLOPE IN THE DIRECTION OF TRAVEL.
- NO GREATER THAN 2% SLOPE CROSSING THE DIRECTION OF TRAVEL NO GREATER THAN 2% SLOPE IN ANY DIRECTION IN COURTYARD OR PLAZA AREAS.

CIVIL SHEET INDEX

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- C1.3 ENGINEERED FILL PLAN
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- C3.1 UTILITY PLAN
- C4.1 PAVING PLAN
- C5.1 DETAILS

CIVIL ABBREVIATIONS AND LEGEND

LEGEND <u>ABBREVIATIONS</u> NOTE: NOT ALL SYMBOLS MAY NOTE: NOT ALL ABBREVIATIONS BE USED ON THESE PLANS. MAY BE USED ON THESE PLANS. PROPOSED GRADING & DRAINAGE SYMBOLS: AGGREGATE BASE ASPHALTIC CONCRETE AREA DRAIN 8" SD STORM DRAIN LINE (SIZE AND FLOW SHOWN) ASSESSOR'S PARCEL NUMBER APN ARV AIR RELEASE VALVE STORM DRAIN MANHOLE ASB AGGREGATE SUB-BASE BLOW-OFF VALVE (SDMH) BUTTERFLY VALVE BACK OF WALK ----- CATCH BASIN (CB) CENTERLINE CATCH BASIN DROP INLET (DI) CLASS CORRUGATED METAL PIPE ----- AREA DRAIN (AD) CABLE TELEVISION CO CLEANOUT PLANTER DRAIN (PD) OR COMMUNICATION FLOOR DRAIN (FD) CONC. CONCRETE CONST. CONSTRUCT STORM DRAIN CLEANOUT CR CURB RETURN CS CONCRETE SURFACE ELEVATION DOUBLE CHECK VALVE DOUBLE DETECTOR CHECK VALVE FINISHED FLOOR ELEVATION FF=100.00 DG DECOMPOSED GRANITE DROP INLET PAD=99.33 BUILDING PAD ELEVATION DIA DIAMETER DUCTILE IRON PIPE CONCRETE SIDEWALK DRAWING DOWNSPOUT DS GRADED DIRECTION FOR ELECTRIC DRAINAGE FLOW EDGE OF PAVEMENT EASEMENT \longrightarrow --- \longrightarrow SWALE **EXISTING** ΕX FIRE SERVICE LINE FIRE DEPARTMENT CONNECTION FLOWLINE TREE TO BE REMOVED SANITARY SEWER FORCE MAIN FINISHED FLOOR ELEVATION RETAINING WALL FIRE HYDRANT GRATE ELEVATION PROPOSED SANITARY SEWER SYMBOLS: GRADE ELEVATION 6" SS SANITARY SEWER LINE GATE VALVE (SIZE AND FLOW SHOWN) HOSE BIBB HBD HEADER BOARD SANITARY SEWER HIGH DENSITY POLYETHYLENE PIPE MANHOLE (SSMH) HIGH POINT PIPE INVERT ELEVATION SEWER CLEANOUT JOINT UTILITY POLE LINEAL FEET FLUSHER BRANCH LIP OF GUTTER LEFT PROPOSED WATER SYMBOLS: MOWSTRIP NOT TO SCALE NTS 8" W WATER LINE & SIZE OVERHEAD PORTLAND CEMENT CONCRETE 8" FS FIRE LINE & SIZE PLANTER DRAIN POST INDICATOR VALVE 8" DW DOMESTIC WATER LINE & SIZE PROPERTY LINE 8" RW RECLAIMED WATER LINE & SIZE POWER POLE PUBLIC UTILITY EASEMEN 8" IRR IRRIGATION SERVICE LINE & SIZE POLYVINYL CHLORIDE REINFORCED CONCRETE PIPE RADIUS ───────────────────── NON POTABLE WATER LINE & SIZE MANHOLE RIM ELEVATION (SOLID COVER) REDUCED PRESSURE BACKFLOW PREVENTER 8" SP FIRE SPRINKLER SERVICE LINE & SIZE RIGHT OF WAY SCHEDULE → GATE VALVE STORM DRAIN STORM DRAIN MANHOLE ────M─── WATER METER SUBGRADE ELEVATION SANITARY SEWER FH FIRE HYDRANT ASSEMBLY SANITARY SEWER MANHOLE STD STANDARD FIRE DEPARTMENT CONNECTION S/W SIDEWALK TELEPHONE DETECTOR CHECK VALVE TOP OF CURB ——— DOUBLE DETECTOR CHECK VALVE TRENCH DRAIN TRENCH DRAIN CATCH BASIN TELEPHONE POLE REDUCED PRESSURE TOP OF RETAINING WALL **BACKFLOW PREVENTER** TRW TOP OF SEAT WALL TSW BUTTERFLY VALVE TOP OF WALK ELEVATION

DEMOLITION GENERAL NOTES

UTILITY

WATER

WITHOUT

WATER VALVE

WITH

UON

VCP

W/

W/O

UNDERGROUND

UNLESS OTHERWISE NOTED

VITRIFIED CLAY PIPE

- 1. IN THE EVENT THAT ANY UNUSUAL CONDITIONS NOT COVERED BY THE GEOTECHNICAL INVESTIGATION REPORT OR ARE ENCOUNTERED DURING GRADING OPERATIONS THE GEOTECHNICAL ENGINEER AND THE ARCHITECT SHALL BE IMMEDIATELY NOTIFIED FOR
- 2. NO BURNING OR BLASTING SHALL BE PERMITTED.
- ADDITIONAL DEMOLITION INFORMATION MAY BE SHOWN ON THE GRADING, DRAINAGE, AND UTILITY PLANS, AND THOSE PLANS PREPARED BY OTHER DISCIPLINES FOR THIS PROJECT.
- 4. ALL DEMOLISHED ITEMS SHALL BE DISPOSED OF OFFSITE AT A SUITABLE, LEGAL, DUMP SITE OR OTHER FACILITY.
- ALL DISPOSED OF MATERIALS SHALL BE RECYCLED IF POSSIBLE.
- 6. THE TYPES, LOCATIONS, SIZES AND/OR DEPTHS OF EXISTING UNDERGROUND UTILITIES AS SHOWN IN THESE PLANS WERE OBTAINED FROM SOURCES OF VARYING RELIABILITY. THE CONTRACTOR IS CAUTIONED THAT ONLY ACTUAL EXCAVATION WILL REVEAL THE TYPES. EXTENT, SIZES, LOCATIONS, AND DEPTHS OF SUCH UNDERGROUND UTILITIES. A REASONABLE EFFORT HAS BEEN MADE TO LOCATE AND DELINEATE ALL KNOWN UNDERGROUND UTILITIES. HOWEVER, WARREN CONSULTING ENGINEERS CAN ASSUME NO RESPONSIBILITY FOR THE COMPLETENESS OR ACCURACY OF ITS DELINEATION OF SUCH UNDERGROUND UTILITIES, NOR FOR THE EXISTENCE OF OTHER BURIED OBJECTS OR UTILITIES WHICH MAY BE ENCOUNTERED BUT WHICH ARE NOT SHOWN ON THESE DRAWINGS. THE CONTRACTOR OR ANY SUBCONTRACTOR FOR THIS CONTRACT SHALL NOTIFY THE DISTRICT TWO (2) WORKING DAYS IN ADVANCE OF PERFORMING ANY EXCAVATION WORK IN ORDER TO VERIFY TO THE GREATEST EXTENT POSSIBLE THE EXISTING UTILITY LINES, CONFLICTS AND PROPOSED UTILITY CONNECTION POINTS.
- 7. THE SCHOOL DISTRICT SHALL HAVE SALVAGE RIGHTS TO ANY DEMOLISHED ITEMS SHOWN HEREON. THE CONTRACTOR SHALL GIVE THE DISTRICT NOTICE 7 DAYS PRIOR TO THE START OF DEMOLITION. THE DISTRICT SHALL MOVE ANY RETAINED ITEMS OUT OF THE CONTRACTORS WORK AREA, UNLESS ANOTHER ARRANGEMENT IS MADE WITH THE CONTRACTOR. ANY REMAINING ITEMS BECOME THE PROPERTY OF THE CONTRACTOR AND SHALL BE REMOVED FROM THE SITE. ANY ITEMS NOT SHOWN FOR REMOVAL SHALL REMAIN AND SHALL BE PROTECTED FROM DAMAGE DURING CONSTRUCTION TO A REASONABLE EXTEND.
- 8. EXISTING UTILITY STRUCTURES IN AREAS OF NEW PAVING SHALL BE REMOVED AND REPLACED WITH NEW BOX/COVER AT NEW GRADE UNLESS SPECIFICALLY NOTED OTHERWISE.
- 9. ITEMS OUTSIDE THE LIMITS OF DEMOLITION SHALL REMAIN AND BE PROTECTED FROM DAMAGE DURING CONSTRUCTION.
- 10. EXISTING UTILITY STRUCTURES AND PIPING NOT SHOWN ON DEMOLITION PLAN TO BE REMOVED SHALL REMAIN AND BE

CONCRETE SAWCUT NOTE

POST INDICATOR VALVE

SAWCUTS AND SUBSEQUENT PATCH BACK OF CONCRETE WALKS, SHALL BE TO THE EXISTING CONCRETE JOINT BEYOND THE NEAREST LOCATION OF DEMOLITION AS SHOWN. A REASONABLE EFFORT HAS BEEN MADE TO LOCATE, SHOW AND COORDINATE WITH EXISTING JOINTS, HOWEVER IF FIELD CONDITIONS ARE OTHERWISE, IT IS UNDERSTOOD TO REMOVE AND PATCH BACK TO THE NEAREST JOINTS BEYOND DEMOLITION.

AIR RELEASE VALVE + SIZE

BLOW-OFF VALVE + SIZE

UTILITY VERIFICATION NOTE

PRIOR TO THE START OF CONSTRUCTION, LOCATE AND POTHOLE ALL UTILITY POINTS OF CONNECTION FOR LOCATION. DEPTH. AND SIZE. IF CONFLICT IS FOUND. CONTACT THE ENGINEER IMMEDIATELY FOR DIRECTION.

IRRIGATION DEMOLITION NOTE

WITHIN LANDSCAPE AREAS TO BE DEMOLISHED THERE MAY BE EXISTING IRRIGATION LINES NOT SHOWN ON THIS PLAN. CONTRACTOR SHALL REMOVE LATERAL LINES AND HEADS ENCOUNTERED. MAIN LINES AND CONTROL WIRES MAY ONLY BE REMOVED PROVIDED THAT ROUTING IS KNOWN AND REMOVAL WILL NOT DEACTIVATE AN IRRIGATION SYSTEMS INTENDED TO REMAIN. IF CONFLICT IS FOUND, CONTACT THE ENGINEER FOR DIRECTION.

AGENCY APPROVAL:

△ DESCRIPTION





DATE



MATSUYAMA ELEMENTARY SCHOOL 7680 WINDBRIDGE DR.

SACRMANETO. CA 95831

MATSUYAMA ELEMENTARY SCHOOL MODERNIZATION

SHEET NAME: **DETAILS**

DSA SUBMITTAL DATE: **01/04/2024** CLIENT PROJ NO: 3186-070-000

AGENCY APPROVAL: 3186-070-000 2101 CAPITOL AVENUE, SUITE 100 SACRAMENTO, CA, 95816 916 368 7990 / www.hmcarchitects.com △ **DESCRIPTION** THIS DRAWING MAY HAVE BEEN ENLARGED OR REDUCED. MATCHLINE - SEE SHEET C0.3 <u>NOTE:</u> SEE SHEET CO.3 FOR SURVEY LEGEND AND ABBREVIATIONS. BASIS OF BEARINGS: **ASSUMED** <u>B+B NOTES:</u> UTILITY LOCATIONS MAY NOT BE TO 4 CPF PK CL BC 10030.78 9538.41 5.14
5 CHISELED "+" 10158.68 9548.43 6.00
6 CHISELED "+" 10232.53 9642.92 5.36
7 CPF PK CL INTX 10307.60 9868.20 5.36
8 CHISELED "+" 10478.49 9735.19 5.73
9 CHISELED "+" 10788.00 10365.51 4.84
10 CHISELED "+" 10200.38 9388.46 6.00
11 CHISELED "+" 10260.40 9461.32 6.13
12 CHISELED "+" 10301.73 9512.78 5.83
13 CHISELED "+" 10371.20 9600.41 5.87
14 CHISELED "+" 10125.41 9312.19 5.83 SCALE

NOT ALL UTILITIES MAY BE SHOWN.

SOME LATERALS WERE NOT ACCESSIBLE

& WERE THEREFORE NOT LOCATED.

DEPTHS SHOWN ARE TO CENTER OF

CONDUCTIVE UTILITY & ARE GENERALLY

+/-10% OF ACTUAL DEPTH, WHEN NOT EL DORADO HILLS, CA 95762 | (916) 985-1870 7680 WINDBRIDGE DR. SACRMANETO, CA 95831 DISTORTED BY ADJACENT CONDUCTORS. 14 CHISELED "+" 10125.41 9312.19 5.83 CRITICAL DEPTHS REQUIRE VERIFICATION 15 CPF BM EL=4.66 11466.91 10499.40 4.66 16 CPS CHISELED "+" 10369.66 9423.50 6.24 BY POTHOLING. MATSUYAMA ELEMENTARY SCHOOL MODERNIZATION 17 CPS CHISELED "+" 10268.97 9381.83 6.04 <u>NDTE:</u> EXISTING UTILITIES BASED ON 18 CPS CHISELED "+" 10513.04 9420.57 7.25 19 CPS PK&WASHER 10519.87 9619.10 5.98 VISIBLE SURFACE STRUCTURES, 20 CPS PK&WASHER 10165.82 9146.10 6.72 SHEET NAME: UG LOCATING BY B+B, AND RECORD INFORMATION. **DSA SUBMITTAL** 031-1150-001 ___ ELEV. <u>4.664</u> BENCHMARK NO. 336-H3C



HMC Architects

DATE

WARREN CONSULTING ENGINEERS, INC. 1117 WINDFIELD WAY, SUITE 110

MATSUYAMA ELEMENTARY SCHOOL

PARTIAL TOPOGRAPHIC SURVEY

DATE: 01/04/2024

SHEET:

CLIENT PROJ NO: 3186-070-000

PLEASE RECYCLE

HILTI NAIL IN LIGHT BASE WEST SIDE OF RUSH

DRIVE AND WINDBRIDGE DRIVE

RIVER DRIVE 16' SOUTH OF THE DRIVEWAY & 222'
NORTHERLY OF THE INTERSECTION OF RUSH RIVER

AGENCY APPROVAL:



HMC Architects 3186-070-000

DATE

2101 CAPITOL AVENUE, SUITE 100 SACRAMENTO, CA, 95816 916 368 7990 / www.hmcarchitects.com

△ **DESCRIPTION**

ANTHONY J. TASSANO WARREN CONSULTING ENGINEERS, INC. 1117 WINDFIELD WAY, SUITE 110

EL DORADO HILLS, CA 95762 | (916) 985-1870

MATSUYAMA ELEMENTARY SCHOOL **7680 WINDBRIDGE DR. SACRMANETO, CA 95831**

MATSUYAMA ELEMENTARY SCHOOL MODERNIZATION

SHEET NAME: PARTIAL TOPOGRAPHIC SURVEY

DSA SUBMITTAL

DATE: 01/04/2024

CLIENT PROJ NO: 3186-070-000

— — t — — = TELEPHONE LINE (UNDERGROUND LOCATING) □ = TRAFFIC SIGNAL B□X

= WATER VALVE = WATER METER = WATER BOX

= FIRE HYDRANT

= SPRINKLER = HOSE BIBB

□────── □R 💢 = LIGHT STANDARD = SIGNAL LIGHT = FLOOD LIGHT

= ELECTRICAL DUTLET

= GAS MANHOLE © = GAS VALVE = GAS METER

---- t ---- = TELEPHONE LINE

— G — = GAS LINE (SIZE INDICATED) — — — G — — — = GAS LINE (RECORD INFORMATION) — — G — — = GAS LINE (UNDERGROUND LOCATING)

= ELECTRIC MANHOLE

= ELECTRIC METER = ELECTRIC BOX = STREET LIGHTING BOX

———— = UNDERGROUND ELECTRIC LINE

= IRRIGATION CONTROL VALVE

= UNDERGROUND ELECTRIC LINE (RECORD INFORMATION)

= UTILITY POLE (WITH GUY WIRE)

= BACKFLOW PREVENTER

= HARD SURFACE ELEVATION

PLEASE RECYCLE

SAVE SAVE SAVE SAVE SAVE **GRAPHIC SCALE** SAVE THIS DRAWING MAY HAVE BEEN ENLARGED OR REDUCED. SAVE 6 MATCHLINE - SEE SHEET C0.3 **DEMOLITION NOTES** REMOVE EXISTING ASPHALT PAVING AND AGGREGATE BASE. 14. REMOVE AND DISPOSE OF BACK STOP. WHERE SAWCUT EDGES ARE SHOWN, THEY SHALL BE A NEAT STRAIGHT LINE. MAINTAIN CLEAN STRAIGHT CUT EDGE UNTIL 15. REMOVE AND SALVAGE FUNNEL BALL APPARATUS AND NEW PAVING PLACED. REINSTALL PER ARCHITECTURAL PLANS. IRRIGATION DEMOLITION NOTE REMOVE EXISTING CONCRETE PAVING AND AGGREGATE BASE. 16. RELOCATE STORAGE CONTAINER DURING CONSTRUCTION AND WHERE SAWCUTS ARE NECESSARY, THEY SHALL BE A NEAT PLACE STORAGE CONTAINER AT COMPLETION OF PROJECT. WITHIN LANDSCAPE AREAS TO BE DEMOLISHED THERE MAY STRAIGHT LINE. CUT SHALL BE MADE AT NEAREST EXISTING BE EXISTING IRRIGATION LINES NOT SHOWN ON THIS PLAN. JOINT TO LOCATION SHOWN. CONTRACTOR SHALL REMOVE LATERAL LINES AND HEADS ENCOUNTERED. MAIN LINES AND CONTROL WIRES MAY ONLY REMOVE AND DISPOSE OF EXISTING TURF AND ASSOCIATED BE REMOVED PROVIDED THAT ROUTING IS KNOWN AND IRRIGATION PIPING/SPRINKLERS WITHIN AREAS OF WORK. CUT REMOVAL WILL NOT DEACTIVATE AN IRRIGATION SYSTEMS AND CAP ANY MAINLINES NEAR WHERE THEY ENTER THE BOUNDARY OF THE PROJECT. MARK ALL CAPPED LINES WITH AN INTENDED TO REMAIN. IF CONFLICT IS FOUND, CONTACT THE ENGINEER FOR DIRECTION. SEE LANDSCAPE PLANS FOR IRRIGATION VALVE BO. ALL EXISTING IRRIGATION AREAS OUTSIDE THE PROJECT WORK AREA SHALL BE PRESERVED AND FURTHER DIRECTION. OPERATIONAL. INTEGRITY SHALL BE MAINTAINED WITH PROPER SPRINKLER COVERAGE TO TURF AREAS TO REMAIN. 4. REMOVE AND DISPOSE OF EXISTING APPARATUS CURB, RAMP, BARK. — — — — 5. REMOVE AND DISPOSE OF EXISTING CONCRETE CURB. — — — — 6. REMOVE AND DISPOSE OF APPARATUS BARK BORDER. 7. REMOVE AND DISPOSE OF EXISTING TREE, TRUNK AND ASSOCIATED ROOTS 8. EXISTING TREE TO REMAIN AND BE PROTECTED. 9. REMOVE AND DISPOSE OF EXISTING APPARATUS. DSA SUBMITTAL 10. REMOVE AND DISPOSE OF EXISTING BASKETBALL POLE AND ASSOCIATED FOOTINGS. 11. REMOVE AND DISPOSE OF EXISTING TETHERBALL POST AND DATE: 01/04/2024 12. SAVE AND PROTECT BALL WALL. 13. REMOVE AND DISPOSE OF GOAL POSTS. PLEASE RECYCLE 🖏

AGENCY APPROVAL:



DATE

HMC Architects

3186-070-000

2101 CAPITOL AVENUE, SUITE 100 SACRAMENTO, CA, 95816 916 368 7990 / www.hmcarchitects.com

△ **DESCRIPTION**

WARREN CONSULTING ENGINEERS, INC. 1117 WINDFIELD WAY, SUITE 110

EL DORADO HILLS, CA 95762 | (916) 985-1870


MATSUYAMA ELEMENTARY SCHOOL

7680 WINDBRIDGE DR. SACRMANETO, CA 95831

MATSUYAMA ELEMENTARY SCHOOL MODERNIZATION

SHEET NAME:

PARTIAL DEMOLITION PLAN

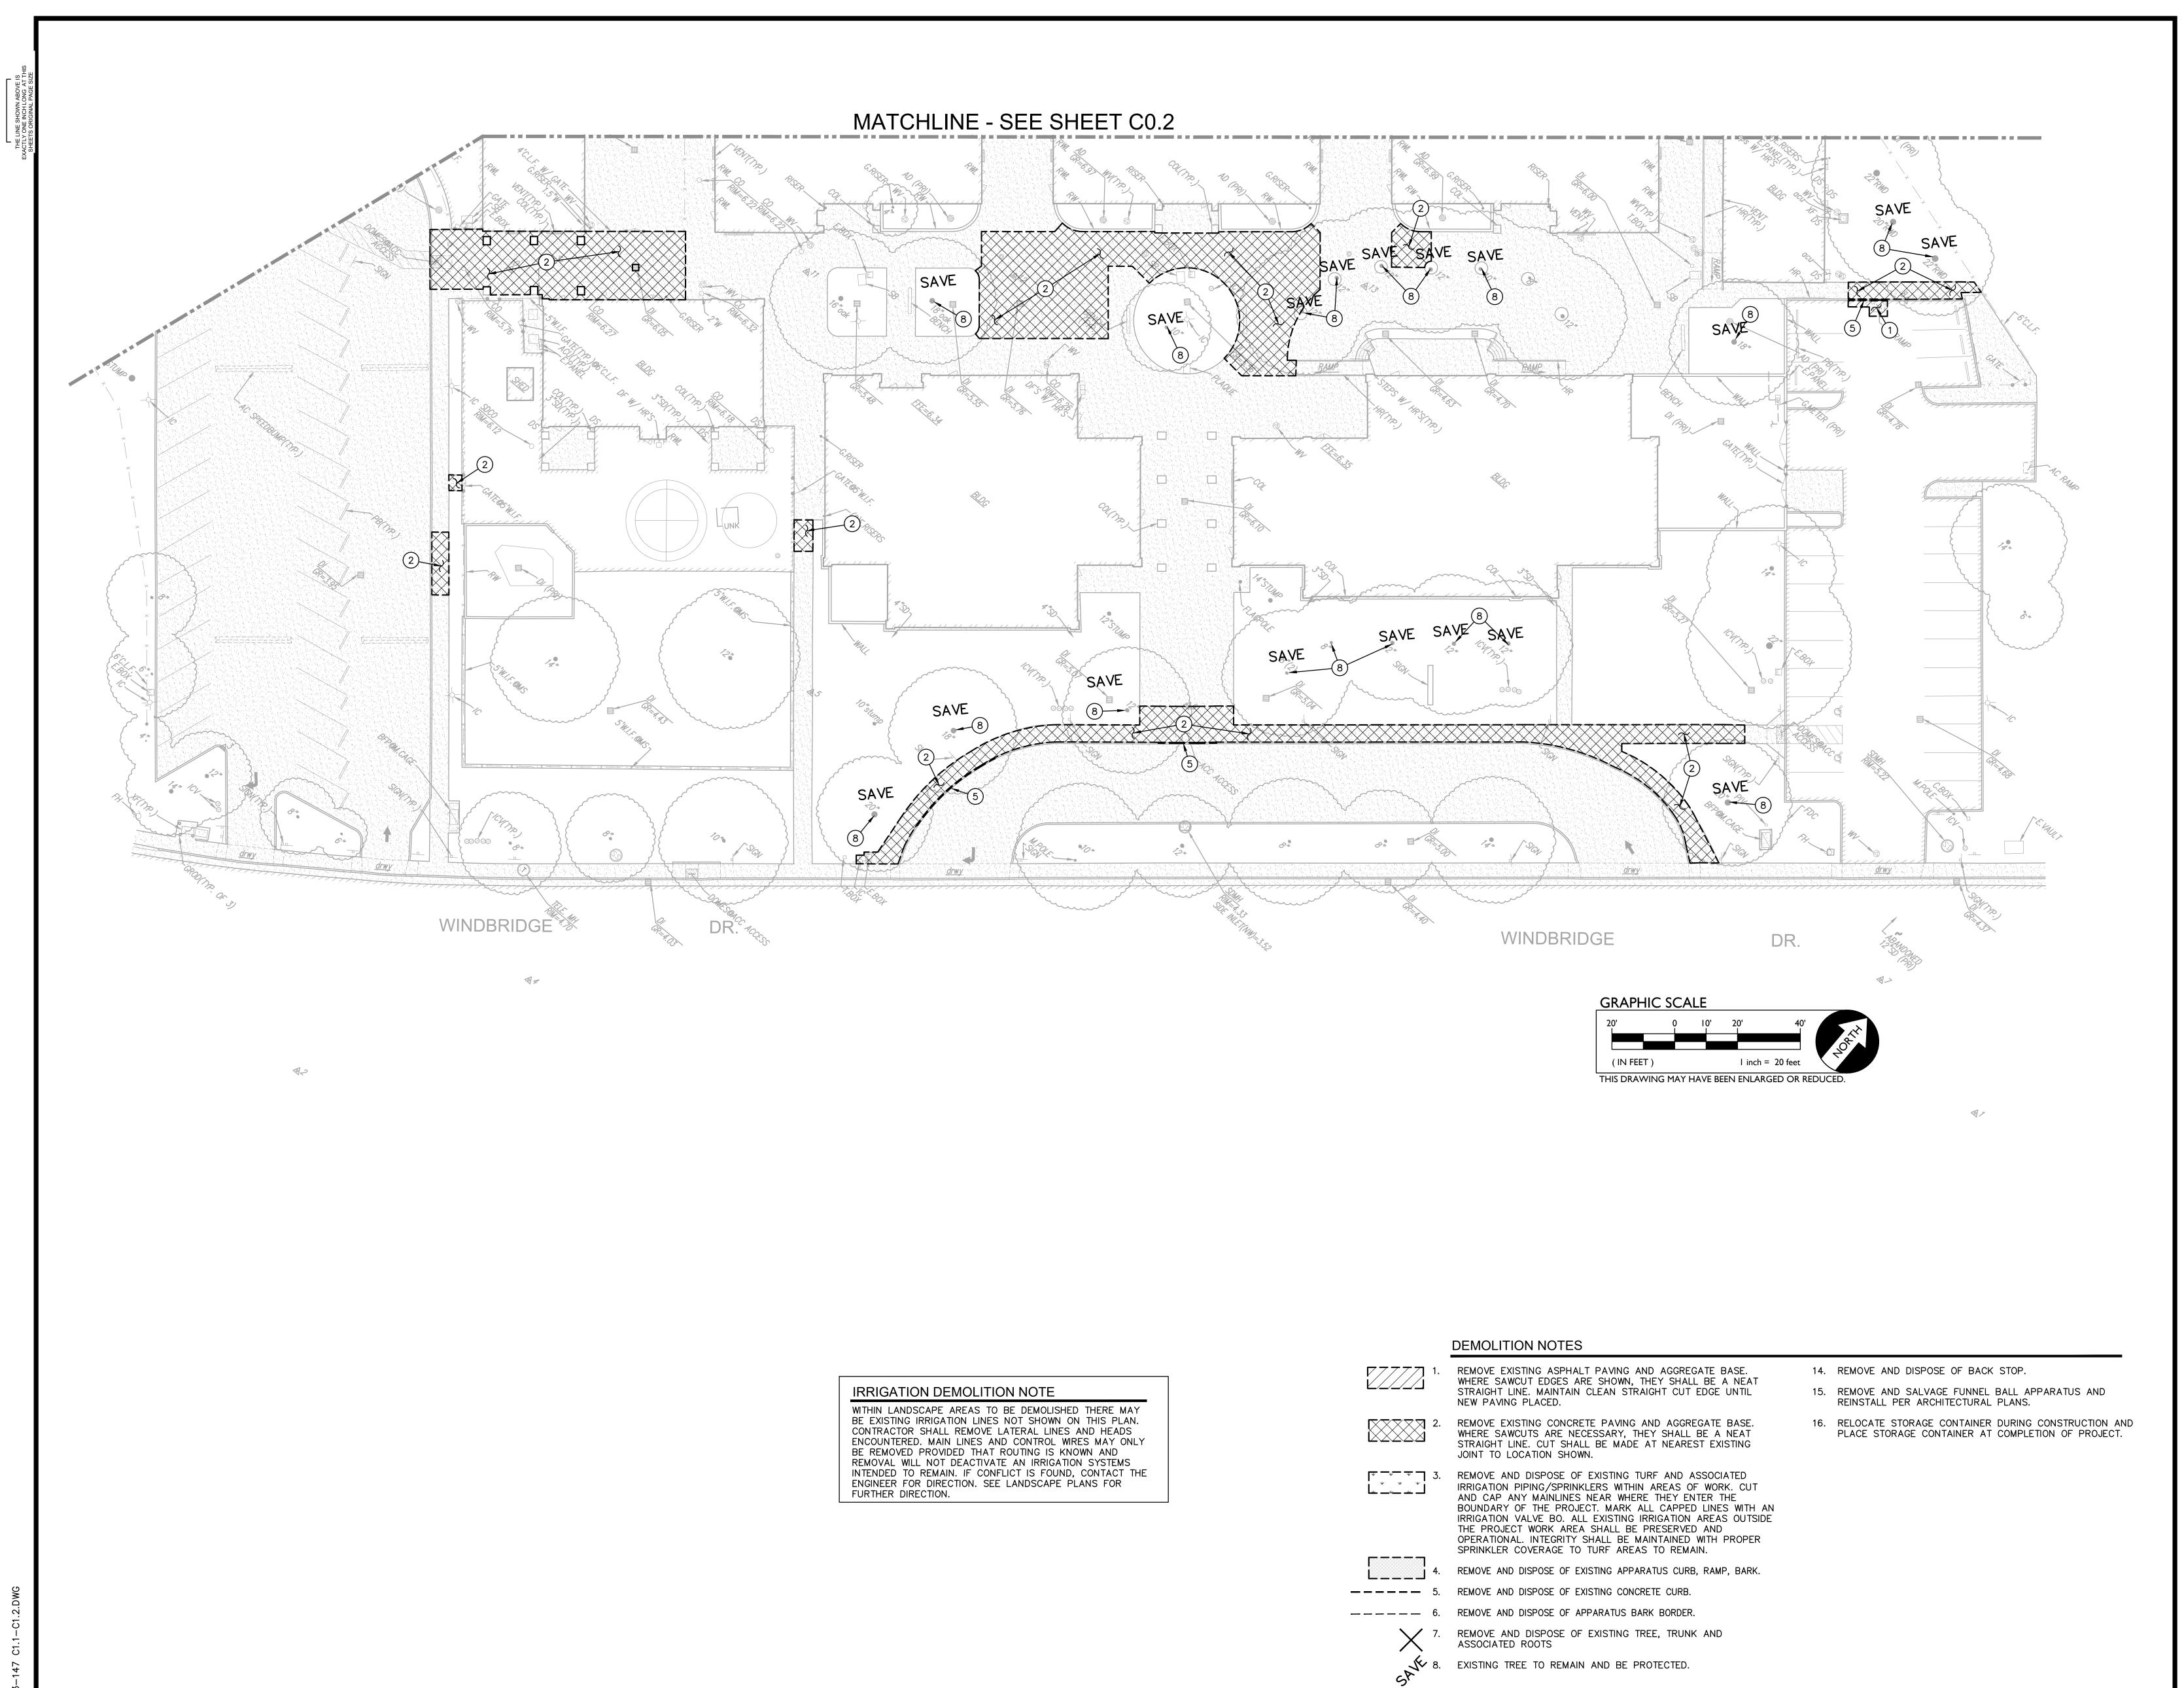

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WARREN CONSULTING ENGINEERS, INC.
1117 WINDFIELD WAY, SUITE 110
EL DORADO HILLS, CA 95762 | (916) 985-1870

FACILITY: 0\$768<\$0\$ (/(0(17\$5< 6&+22/ ^* :,1'%5,'*('5

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PROJECT: 0 \$ 7 6 8 < \$ 0 \$ (/(0(17\$5 < 6 & +22/ 02'(51, = \$ 7, 21

SHEET NAME:

3\$57,\$/'(02/,7,21 3/\$1

DSA SUBMITTAL

DATE: **01/04/2024**

CLIENT PROJ NO: 3186-070-000

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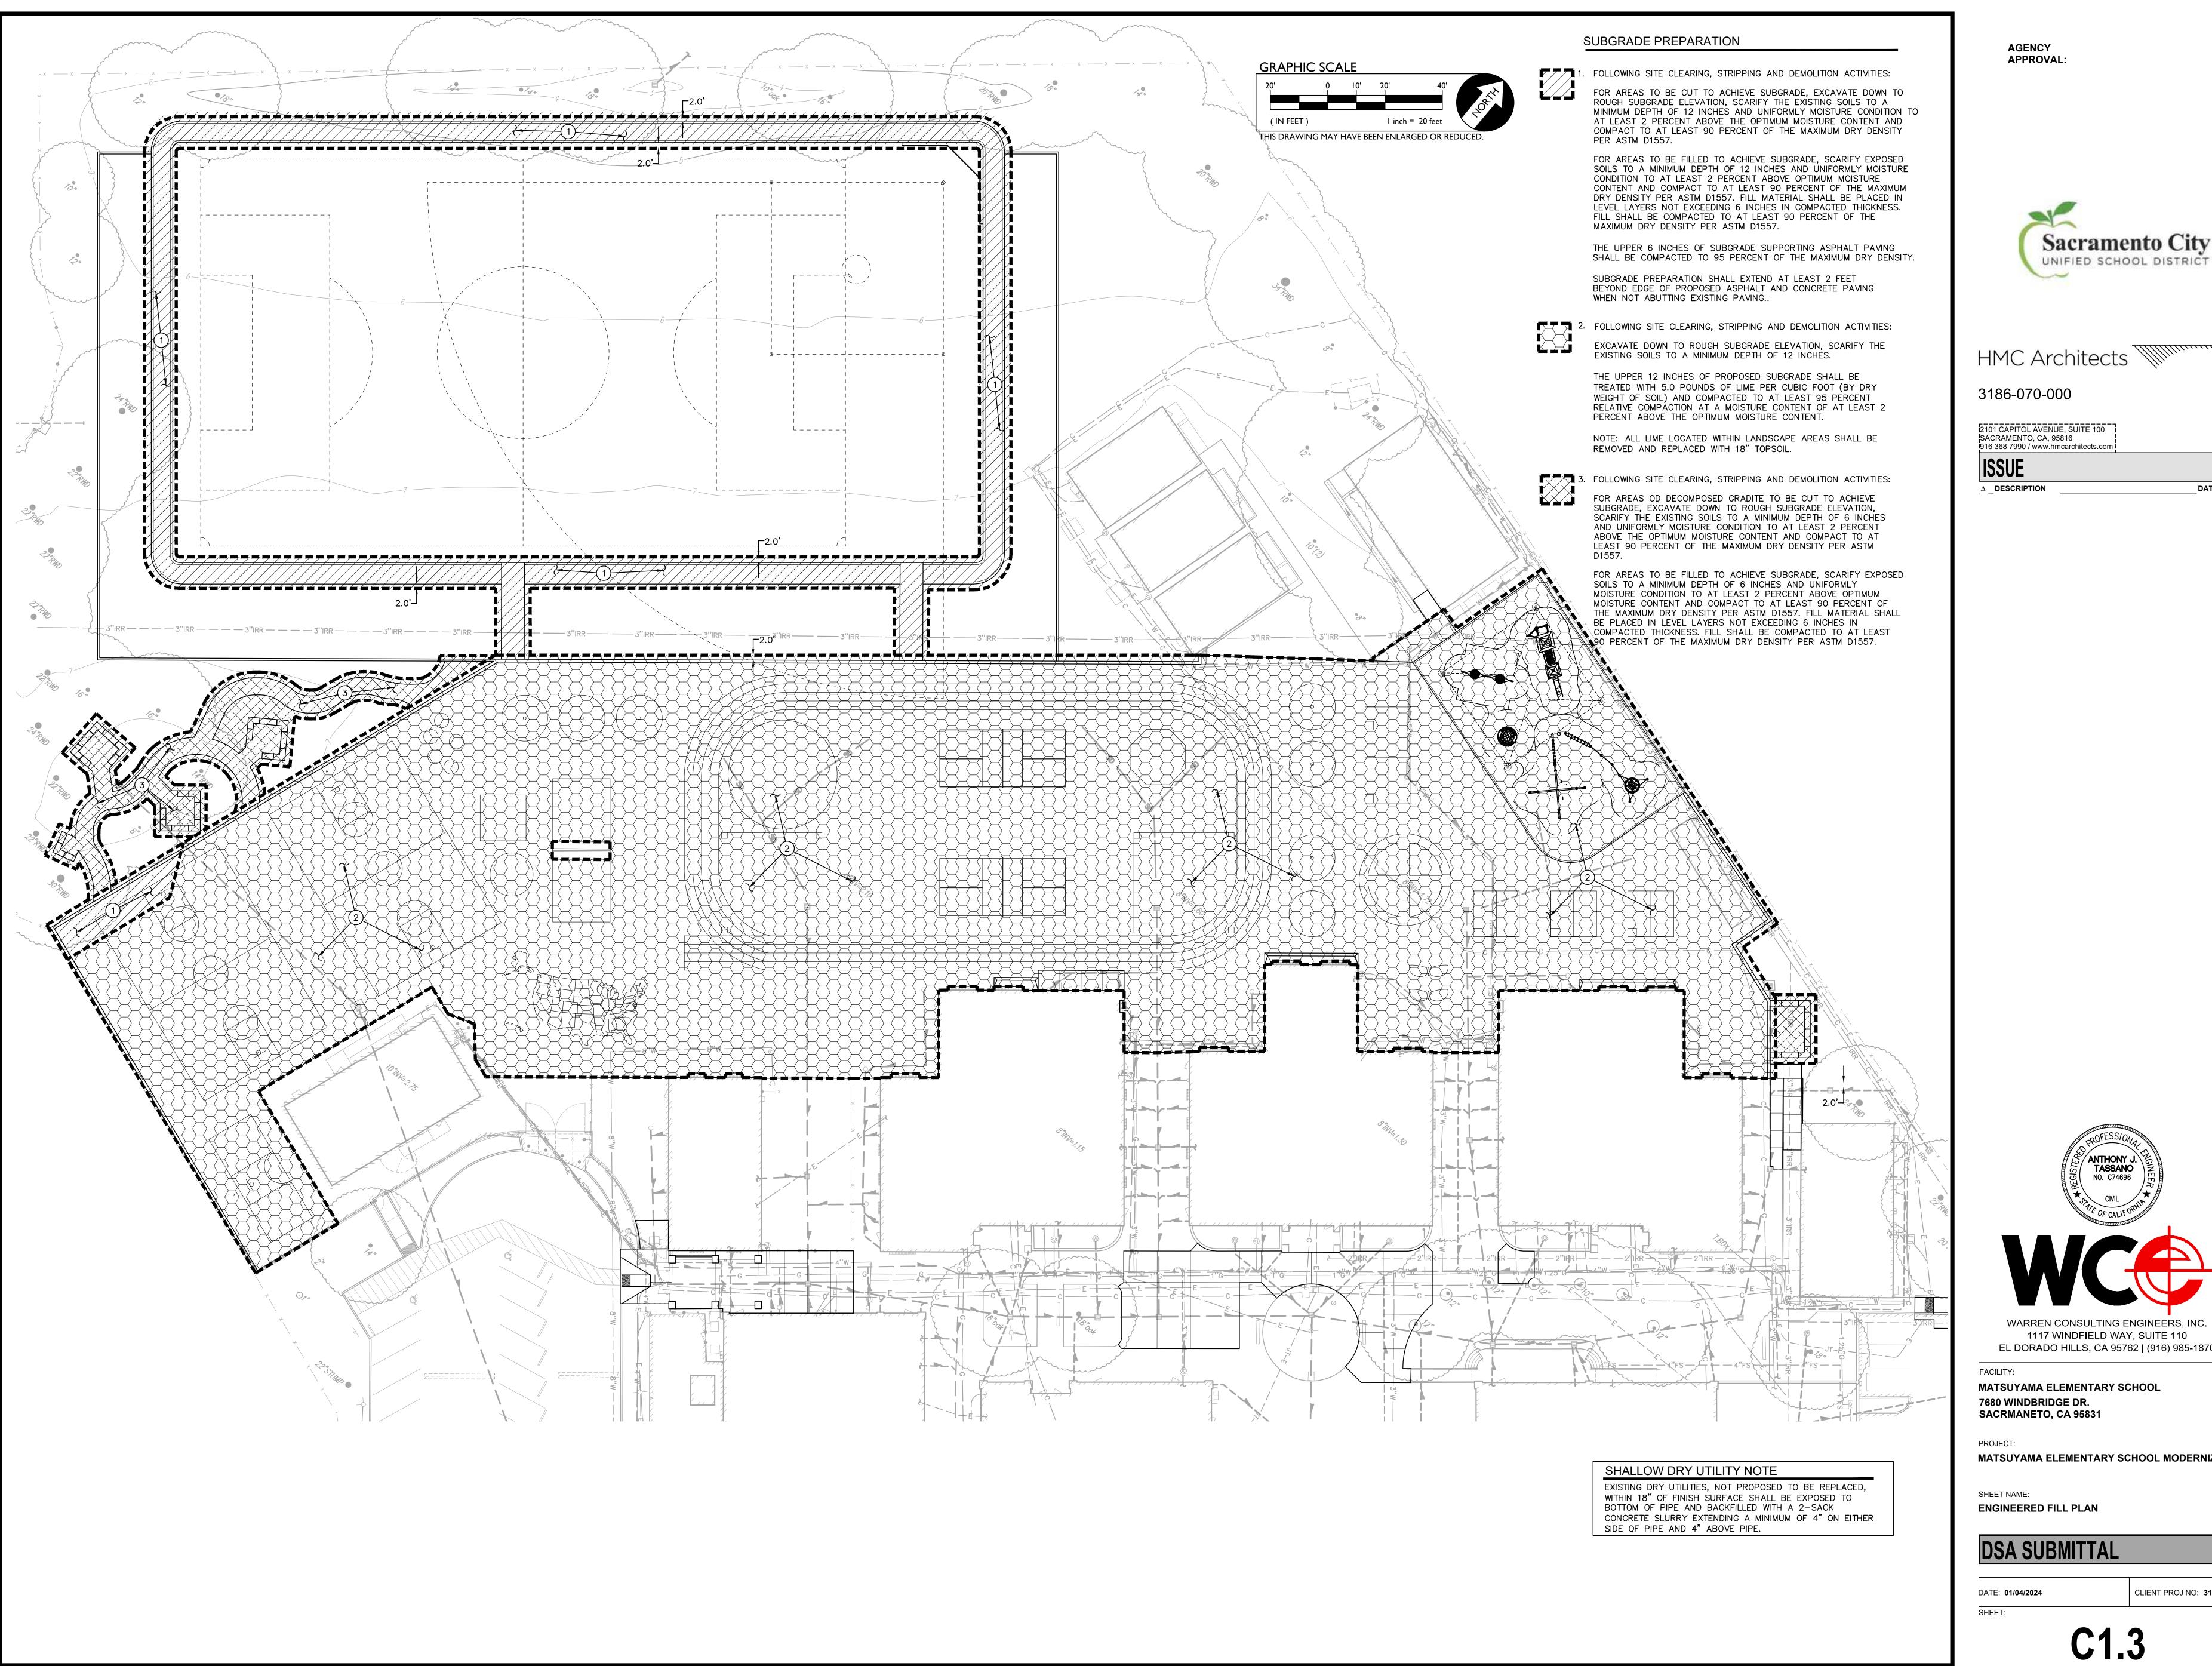
9. REMOVE AND DISPOSE OF EXISTING APPARATUS.

12. SAVE AND PROTECT BALL WALL.

13. REMOVE AND DISPOSE OF GOAL POSTS.

 REMOVE AND DISPOSE OF EXISTING BASKETBALL POLE AND ASSOCIATED FOOTINGS.

11. REMOVE AND DISPOSE OF EXISTING TETHERBALL POST AND



AGENCY



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1117 WINDFIELD WAY, SUITE 110

MATSUYAMA ELEMENTARY SCHOOL 7680 WINDBRIDGE DR. SACRMANETO, CA 95831

MATSUYAMA ELEMENTARY SCHOOL MODERNIZATION

SHEET NAME:

APPROVAL: <u>5.62TW</u> <u>в</u> – – – – – – – – е THIS DRAWING MAY HAVE BEEN ENLARGED OR REDUCED. 6.46±AC/CS 6.27AC (EX)DI 9 /GR=5.78 9_{5.} 6.46±AC/CS 1 6.40±TW/AC (1) 5.85±TW 1 MATCHLINE - SEE SHEET C2.2 GRADING NOTES 1. MATCH EXISTING GRADE/ELEVATION. 2. MATCH EXISTING FLOOR ELEVATION. 3. GRADE UNIFORMLY TO SWALE AND/OR INLET. 4. CONSTRUCT CONCRETE CURB PER $\frac{2}{C5.1}$ EL DORADO HILLS, CA 95762 | (916) 985-1870 6. CONSTRUCT APPARATUS CURB PER ARCHITECTURAL PLAN. PLACE EXISTING STORAGE CONTAINER BACK IN IT'S ORIGINAL LOCATION UPON COMPLETION OF PROJECT. 7680 WINDBRIDGE DR. SACRMANETO, CA 95831 8. INSTALL TRUNCATED DOMES PER $\left(\frac{7}{C5}\right)$ 9. ADJUST DRAIN INLET GRATE TO ELEVATION SHOWN. 10. CONSTRUCT OFFSET VALLEY GUTTER PER $\frac{9}{C5.1}$ SHEET NAME: **GENERAL PAVING NOTES:** A. SLOPE OF FINISHED PEDESTRIAN CONCRETE FLATWORK TO BE 0.5% MINIMUM AND THE MAXIMUM SLOPE SHALL BE AS FOLLOWS; CROSS SLOPE PERPENDICULAR TO PATH OF TRAVEL — 2%. DIRECTION OF TRAVEL — 5%. RAMP IN DIRECTION OF TRAVEL — 8.33%. PLAZA 2% — IN ANY DIRECTION DATE: 01/04/2024 PLEASE RECYCLE

AGENCY



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DATE


WARREN CONSULTING ENGINEERS, INC. 1117 WINDFIELD WAY, SUITE 110

MATSUYAMA ELEMENTARY SCHOOL

MATSUYAMA ELEMENTARY SCHOOL MODERNIZATION

PARTIAL GRADING PLAN

DSA SUBMITTAL

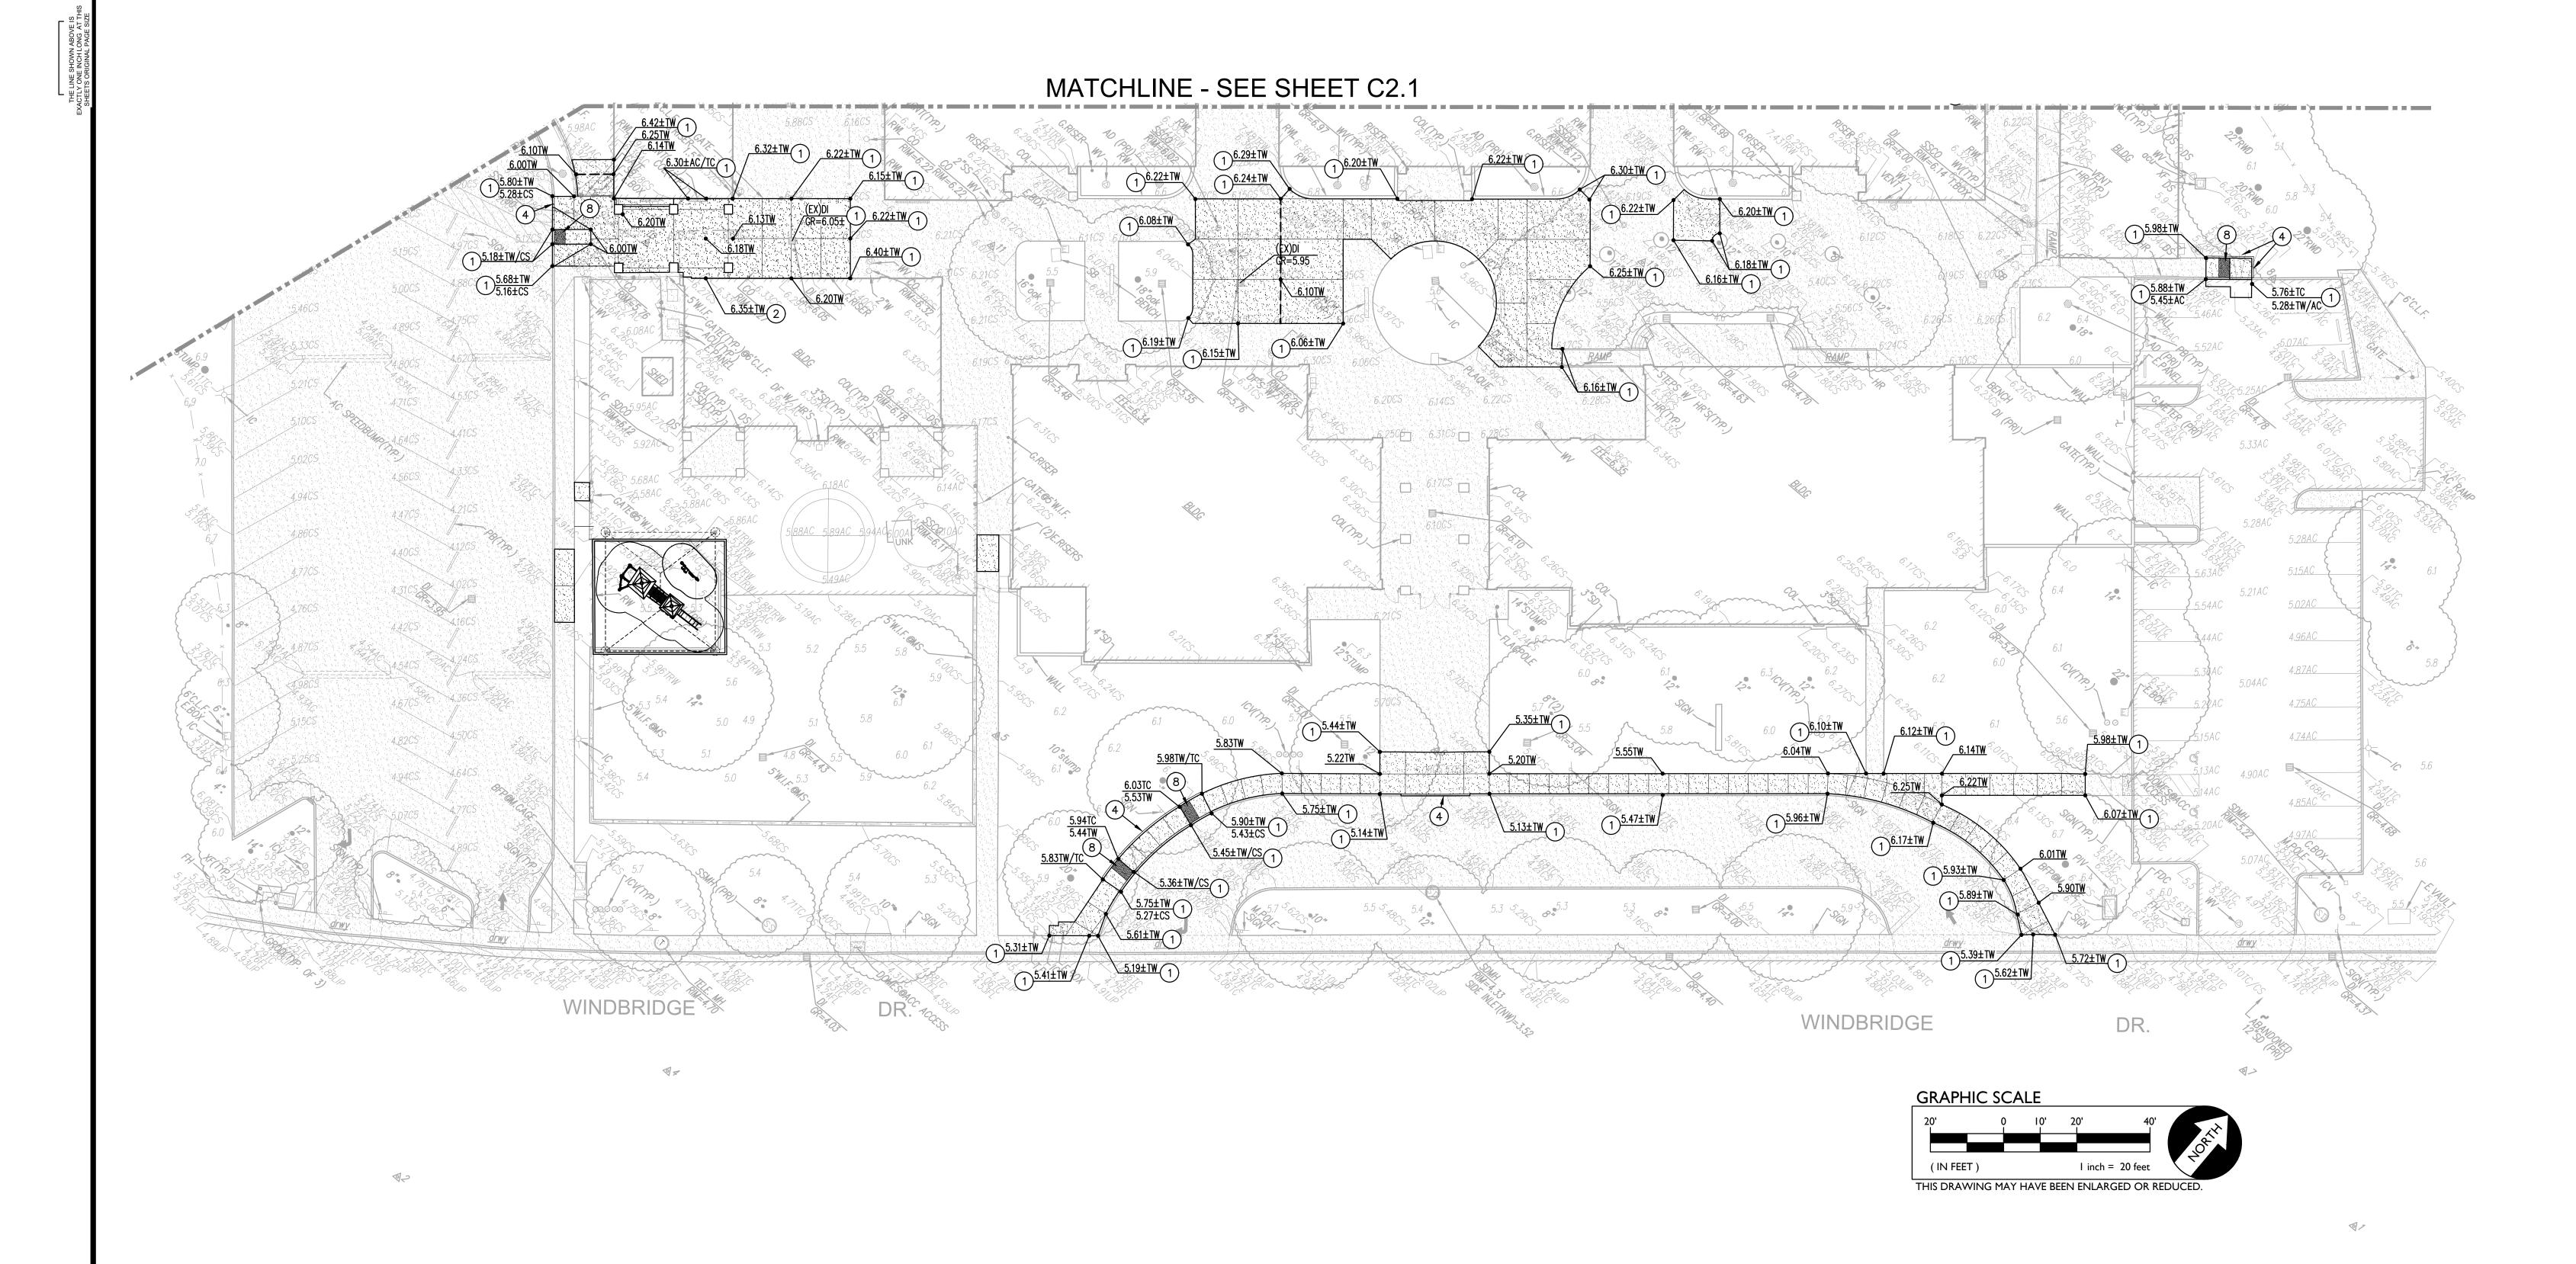

GRADING NOTES

- MATCH EXISTING GRADE/ELEVATION.
- 2. MATCH EXISTING FLOOR ELEVATION.
- 3. GRADE UNIFORMLY TO SWALE AND OR INLET.
- 4. CONSTRUCT CONCRETE CURB PER $\left(\frac{2}{C5.1}\right)$
- 5. CONSTRUCT 12" WIDE CONCRETE FLUSH CURB PER (5.1)6. CONSTRUCT APPARATUS CURB PER ARCHITECTURAL PLAN.
- PLACE EXISTING STORAGE CONTAINER BACK IN IT'S ORIGINAL LOCATION UPON COMPLETION OF PROJECT.
- 8. INSTALL TRUNCATED DOMES PER $\left(\frac{7}{C5.1}\right)$
- 9. ADJUST DRAIN INLET GRATE TO ELEVATION SHOWN.
- 10. CONSTRUCT OFFSET VALLEY GUTTER PER $\frac{9}{(5.1)}$

GENERAL PAVING NOTES:

A. SLOPE OF FINISHED PEDESTRIAN CONCRETE FLATWORK TO BE 0.5% MINIMUM AND THE MAXIMUM SLOPE SHALL BE AS FOLLOWS; CROSS SLOPE PERPENDICULAR TO PATH OF TRAVEL - 2%. DIRECTION OF TRAVEL - 5%. RAMP IN DIRECTION OF TRAVEL - 8.33%. PLAZA 2% - IN ANY DIRECTION

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MATSUYAMA ELEMENTARY SCHOOL 7680 WINDBRIDGE DR.


SACRMANETO, CA 95831

MATSUYAMA ELEMENTARY SCHOOL MODERNIZATION

SHEET NAME: **PARTIAL GRADING PLAN**


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DATE: 01/04/2024

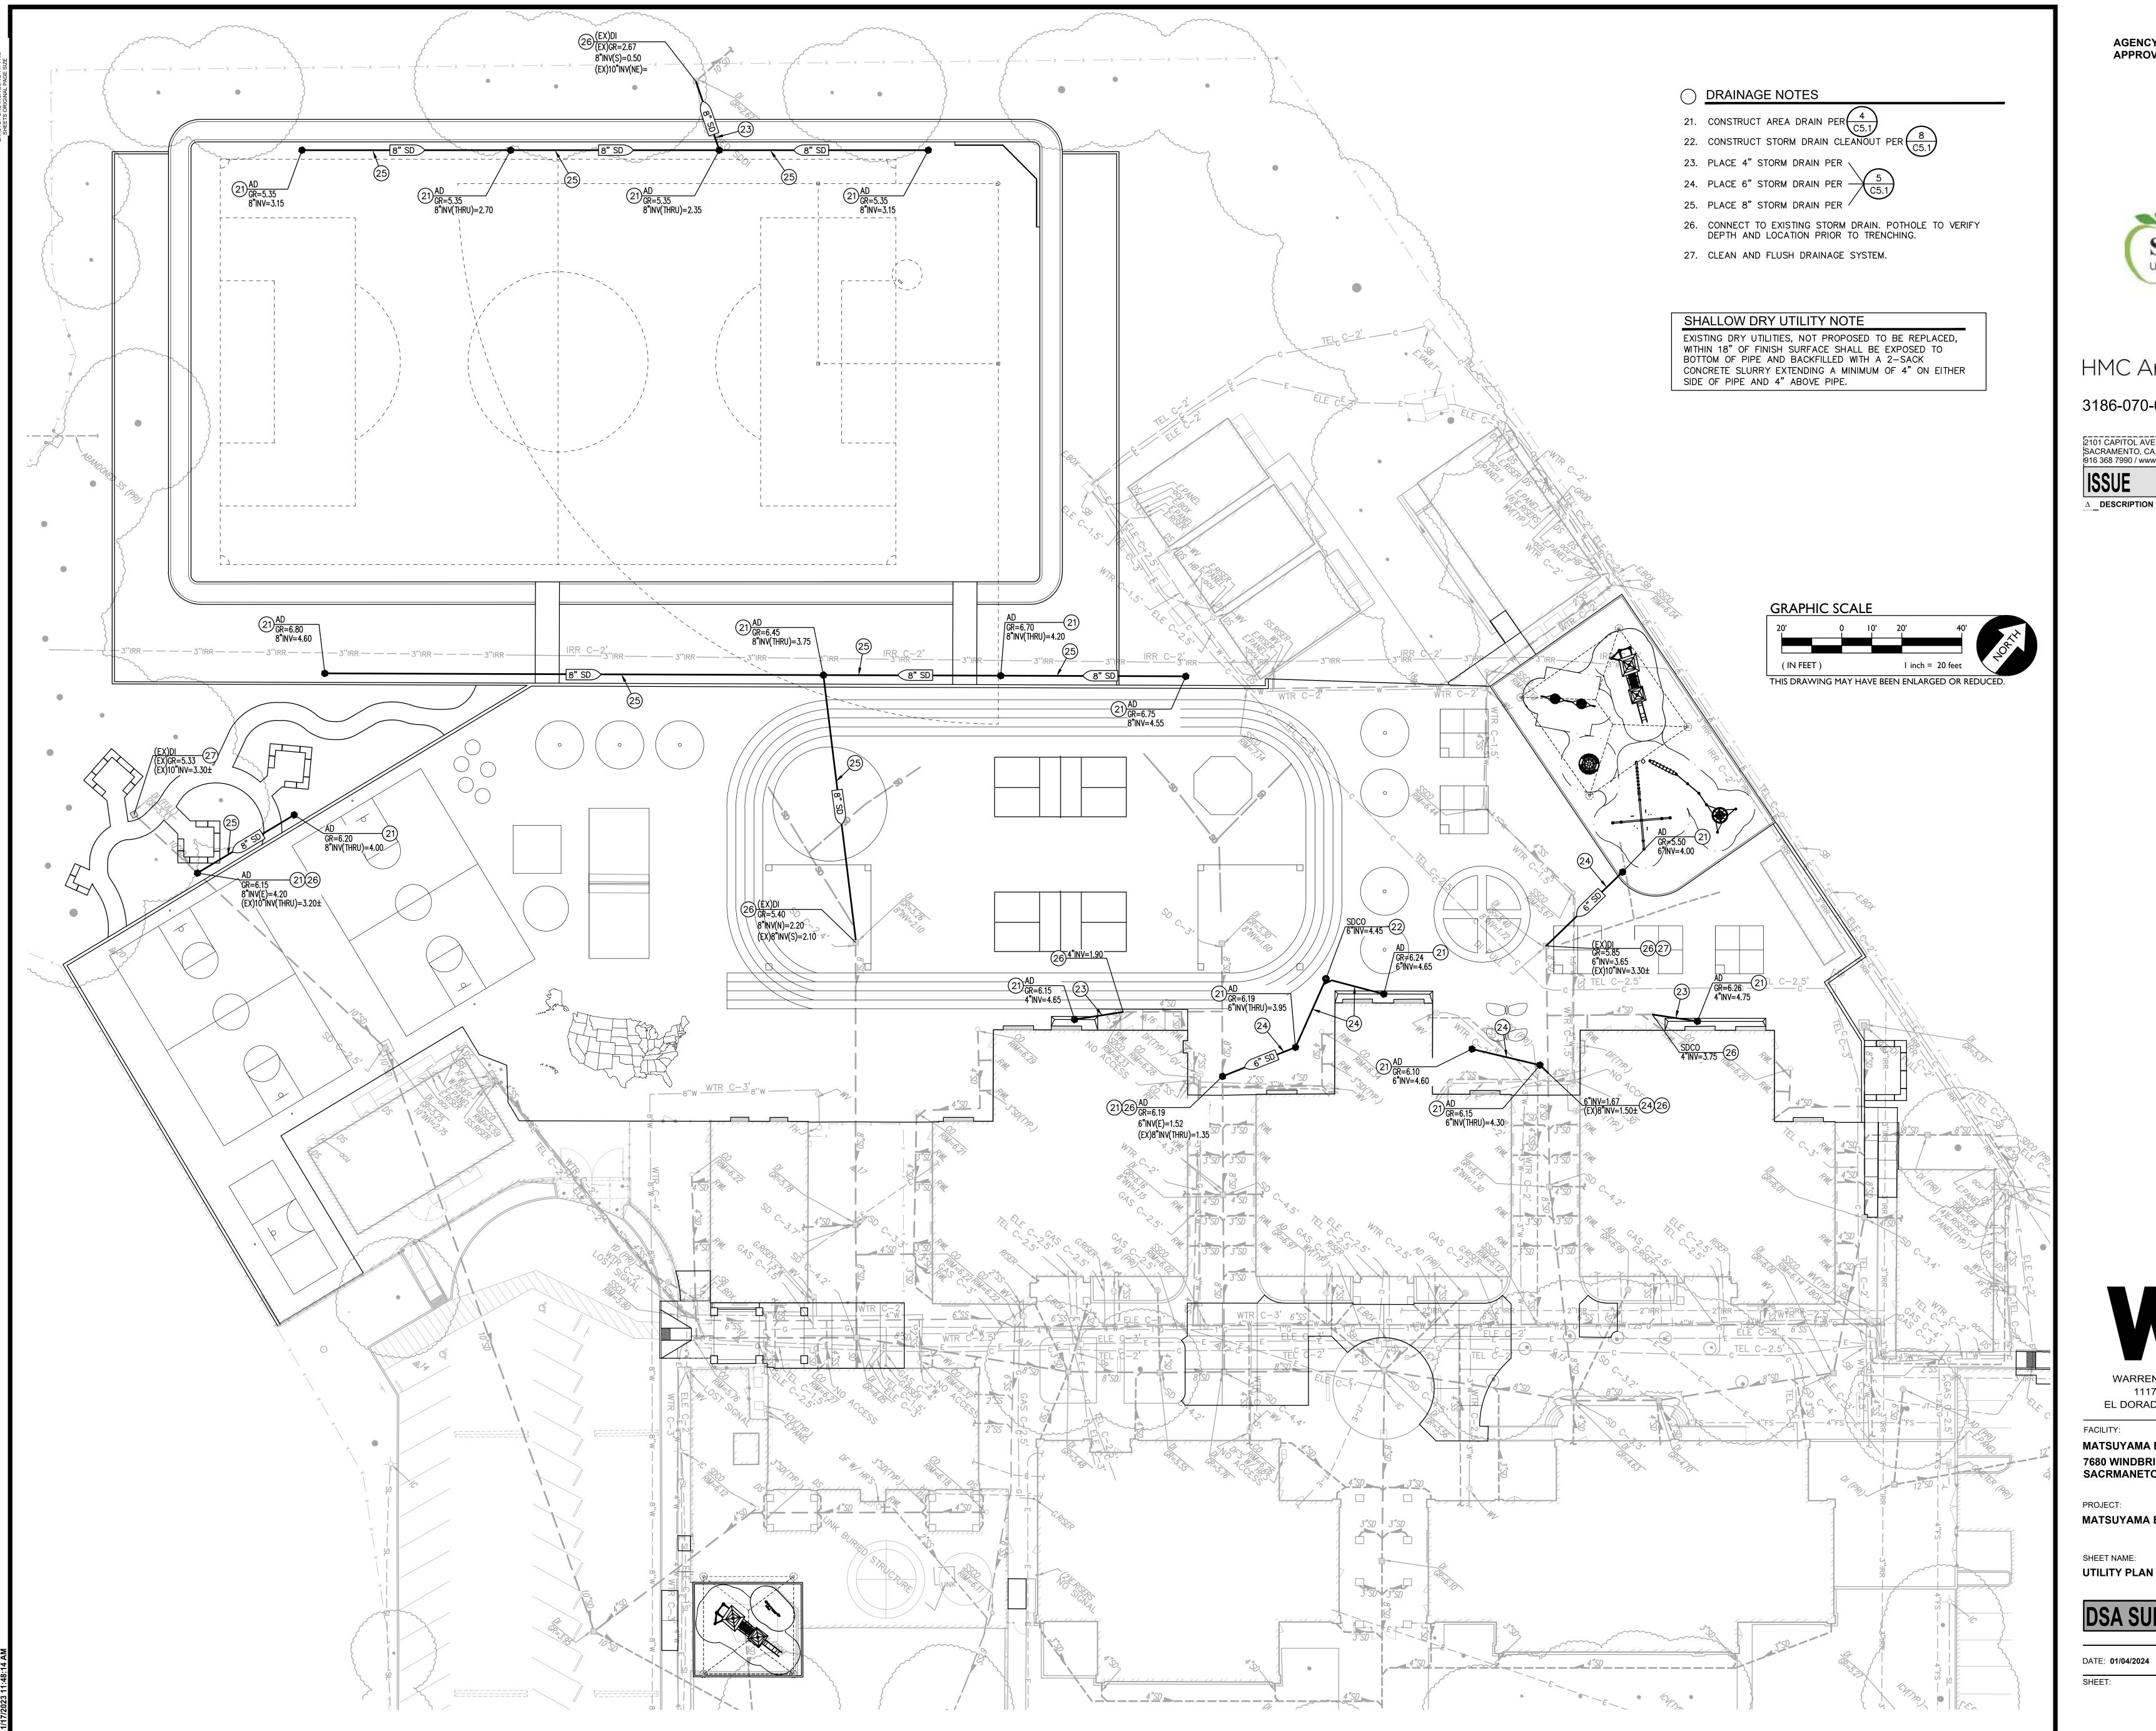

AGENCY APPROVAL:



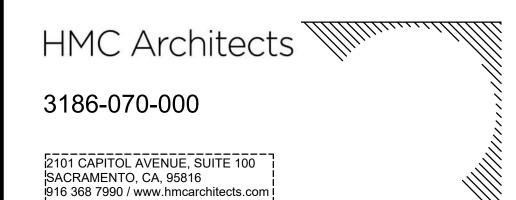

DATE



MATSUYAMA ELEMENTARY SCHOOL 7680 WINDBRIDGE DR. SACRMANETO, CA 95831

MATSUYAMA ELEMENTARY SCHOOL MODERNIZATION

UTILITY PLAN

DSA SUBMITTAL

DATE: 01/04/2024

PLACE <u>5"</u> PCC WITH #4 REBAR @ 24" O.C.E.W. OVER 5" CLASS II AB ON COMPACTED SUBGRADE.

2 TYPE 2 PAVING
PLACE 5" PCC WITH #4 REBAR @ 24" O.C.E.W. OVER 16" CLASS II AB ON COMPACTED SUBGRADE.

TYPE 3 PAVING

PLACE <u>5"</u> PCC WITH #4 REBAR @ 24" O.C.E.W. OVER 4" CLASS II AB ON LIME TREATED SUBGRADE.



PLACE <u>3"</u> AC OVER 8" CLASS II AB ON A TENSAR BX1100 GEOGRID, OR APPROVED EQUAL, ON COMPACTED SUBGRADE.

PLACE <u>3.0"</u> AC OVER 4" CLASS II AB ON LIME TREATED SUBGRADE.

MATCH EXISTING PAVING SECTION (MINIMUM 3"AC OVER 8"AB)

7 TYPE 7 PAVING

PLACE 1/2" POUR IN PLACE RUBBER WEAR COURSE OVER 3" SBR CUSHION LAYER ON 6" OF CLASS II AB ON LIME TREATED SUBGRADE.



PLACE <u>5"</u> PCC WITH #4 REBAR @ 24" O.C.E.W. OVER 16" 6 C5.1

PLACE 13MM (MIN) SYNTHETIC TRACK SURFACING OVER TYPE 3 CONCRETE PAVING PER THE SECTION AND DETAILS PROVIDED. DO NOT TOOL RADIUS EDGES OF FELT EXPANSION JOINTS UNDER TRACK SURFACING AND USE SMALL RADIUS (1/4") TOOL FOR TOOLED JOINTS UNDER TRACK SURFACING.
SEE SPECS FOR ALL OTHER JOINTS NOT UNDER TRACK
SURFACING.

9 TYPE 9 PAVING PLACE DG ON COMPACTED SUBGRADE AND METAL EDGING PER LANDSCAPE PLANS.

AGENCY APPROVAL:



DATE

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MATSUYAMA ELEMENTARY SCHOOL 7680 WINDBRIDGE DR. SACRMANETO, CA 95831

MATSUYAMA ELEMENTARY SCHOOL MODERNIZATION


SHEET NAME: **PAVING PLAN**

DSA SUBMITTAL

DATE: 01/04/2024


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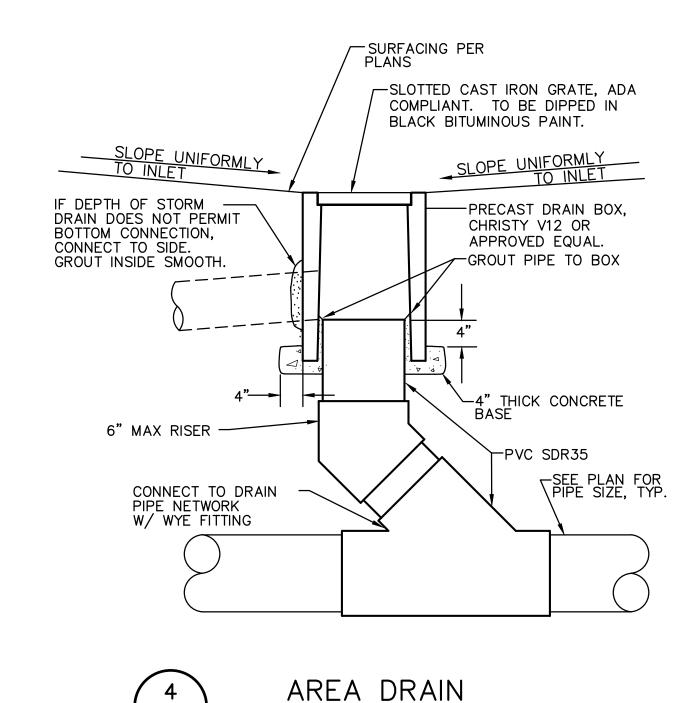
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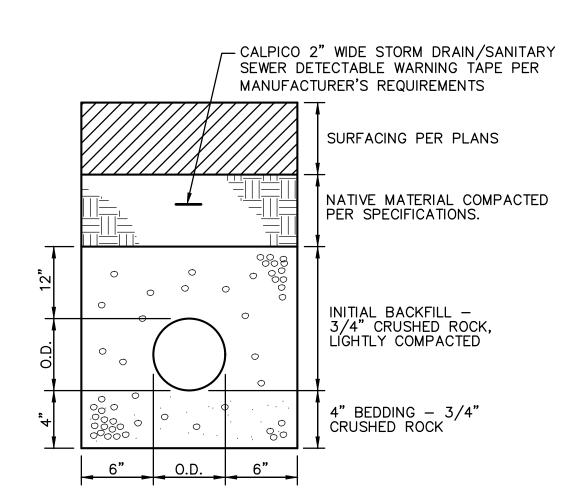


1. PROVIDE FELT EXPANSION JOINTS (E.J.) AT 60 FEET O.C. PROVIDE CONTROL JOINTS AT 10 FEET O.C., EXCEPT WHEN PLACING ADJACENT TO CONCRETE WALKS THE EXPANSION JOINTS SHALL ALIGN WITH THE EXPANSION JOINTS SHOWN FOR THE CONCRETE WALKS.

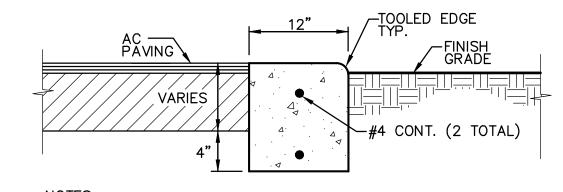2. AT E.J. USE 1/2"X24" SMOOTH DOWELS, ALIGN WITH REBAR, GREASE 1/2 THE LENGTH BEFORE CONCRETE PLACEMENT.







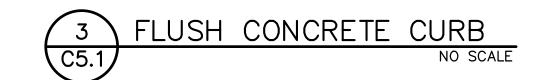


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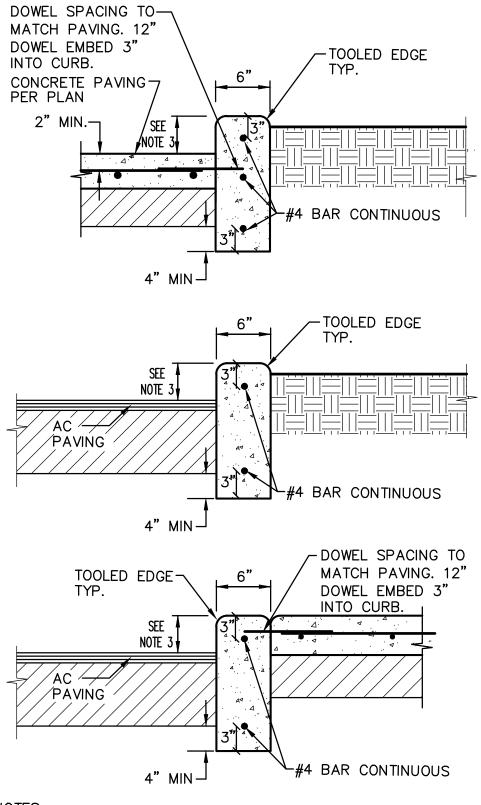
NOTES:

1. PROVIDE FELT EXPANSION JOINTS AT 20 FEET O.C. MAX.

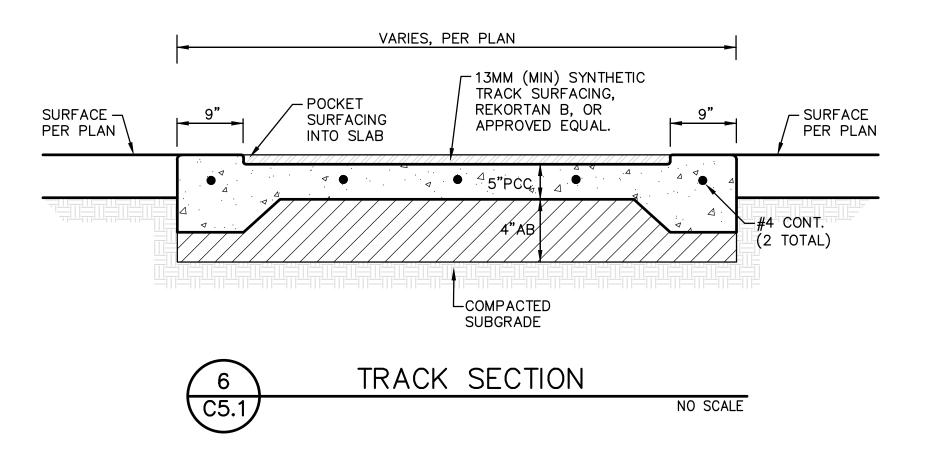SEE PLAN FOR LAYOUT.

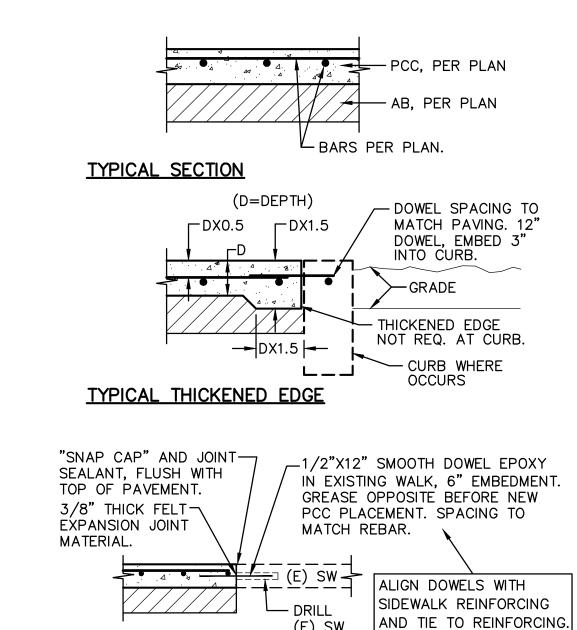PROVIDE CONTROL JOINTS AT 10 FEET O.C. MAX. SEE PLAN FOR LAYOUT.
 EXPANSION OR CONTROL JOINTS SHALL NOT EXCEED 1/2" IN SURFACE WIDTH.

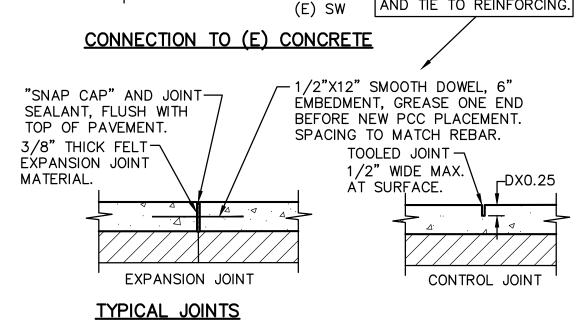



NOTES:

1. PROVIDE FELT EXPANSION JOINTS (E.J.) AT 60 FEET O.C. MAXIMUM PROVIDE CONTROL JOINTS AT 10 FEET O.C. MAXIMUM, EXCEPT WHEN PLACING ADJACENT TO CONCRETE WALKS THE EXPANSION JOINTS SHALL ALIGN WITH THE EXPANSION JOINTS SHOWN FOR THE CONCRETE WALKS.

2. AT E.J. USE 1/2"X24" SMOOTH DOWELS, ALIGN WITH REBAR,

GREASE 1/2 THE LENGTH BEFORE CONCRETE PLACEMENT.


3. CURB HEIGHT IS 6" UNLESS NOTED OTHERWISE BY GRADES SHOWN ON GRADING PLAN.



AGENCY APPROVAL:

 Δ **DESCRIPTION**



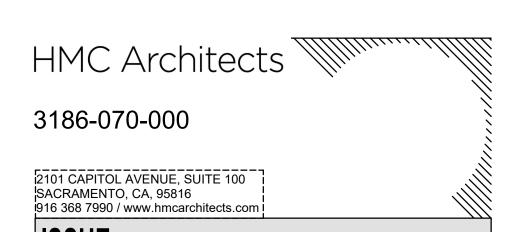

DATE



FACILITY:

MATSUYAMA ELEMENTARY SCHOOL

7680 WINDBRIDGE DR.

SACRMANETO, CA 95831

PROJECT:

MATSUYAMA ELEMENTARY SCHOOL MODERNIZATION


SHEET NAME:

DSA SUBMITTAL

DATE: 01/04/2024 CLIENT PROJ NO: 3186-070-000
SHEET:

C5.1

_ENAME: I: \23—147\CIVIL\DWG\23

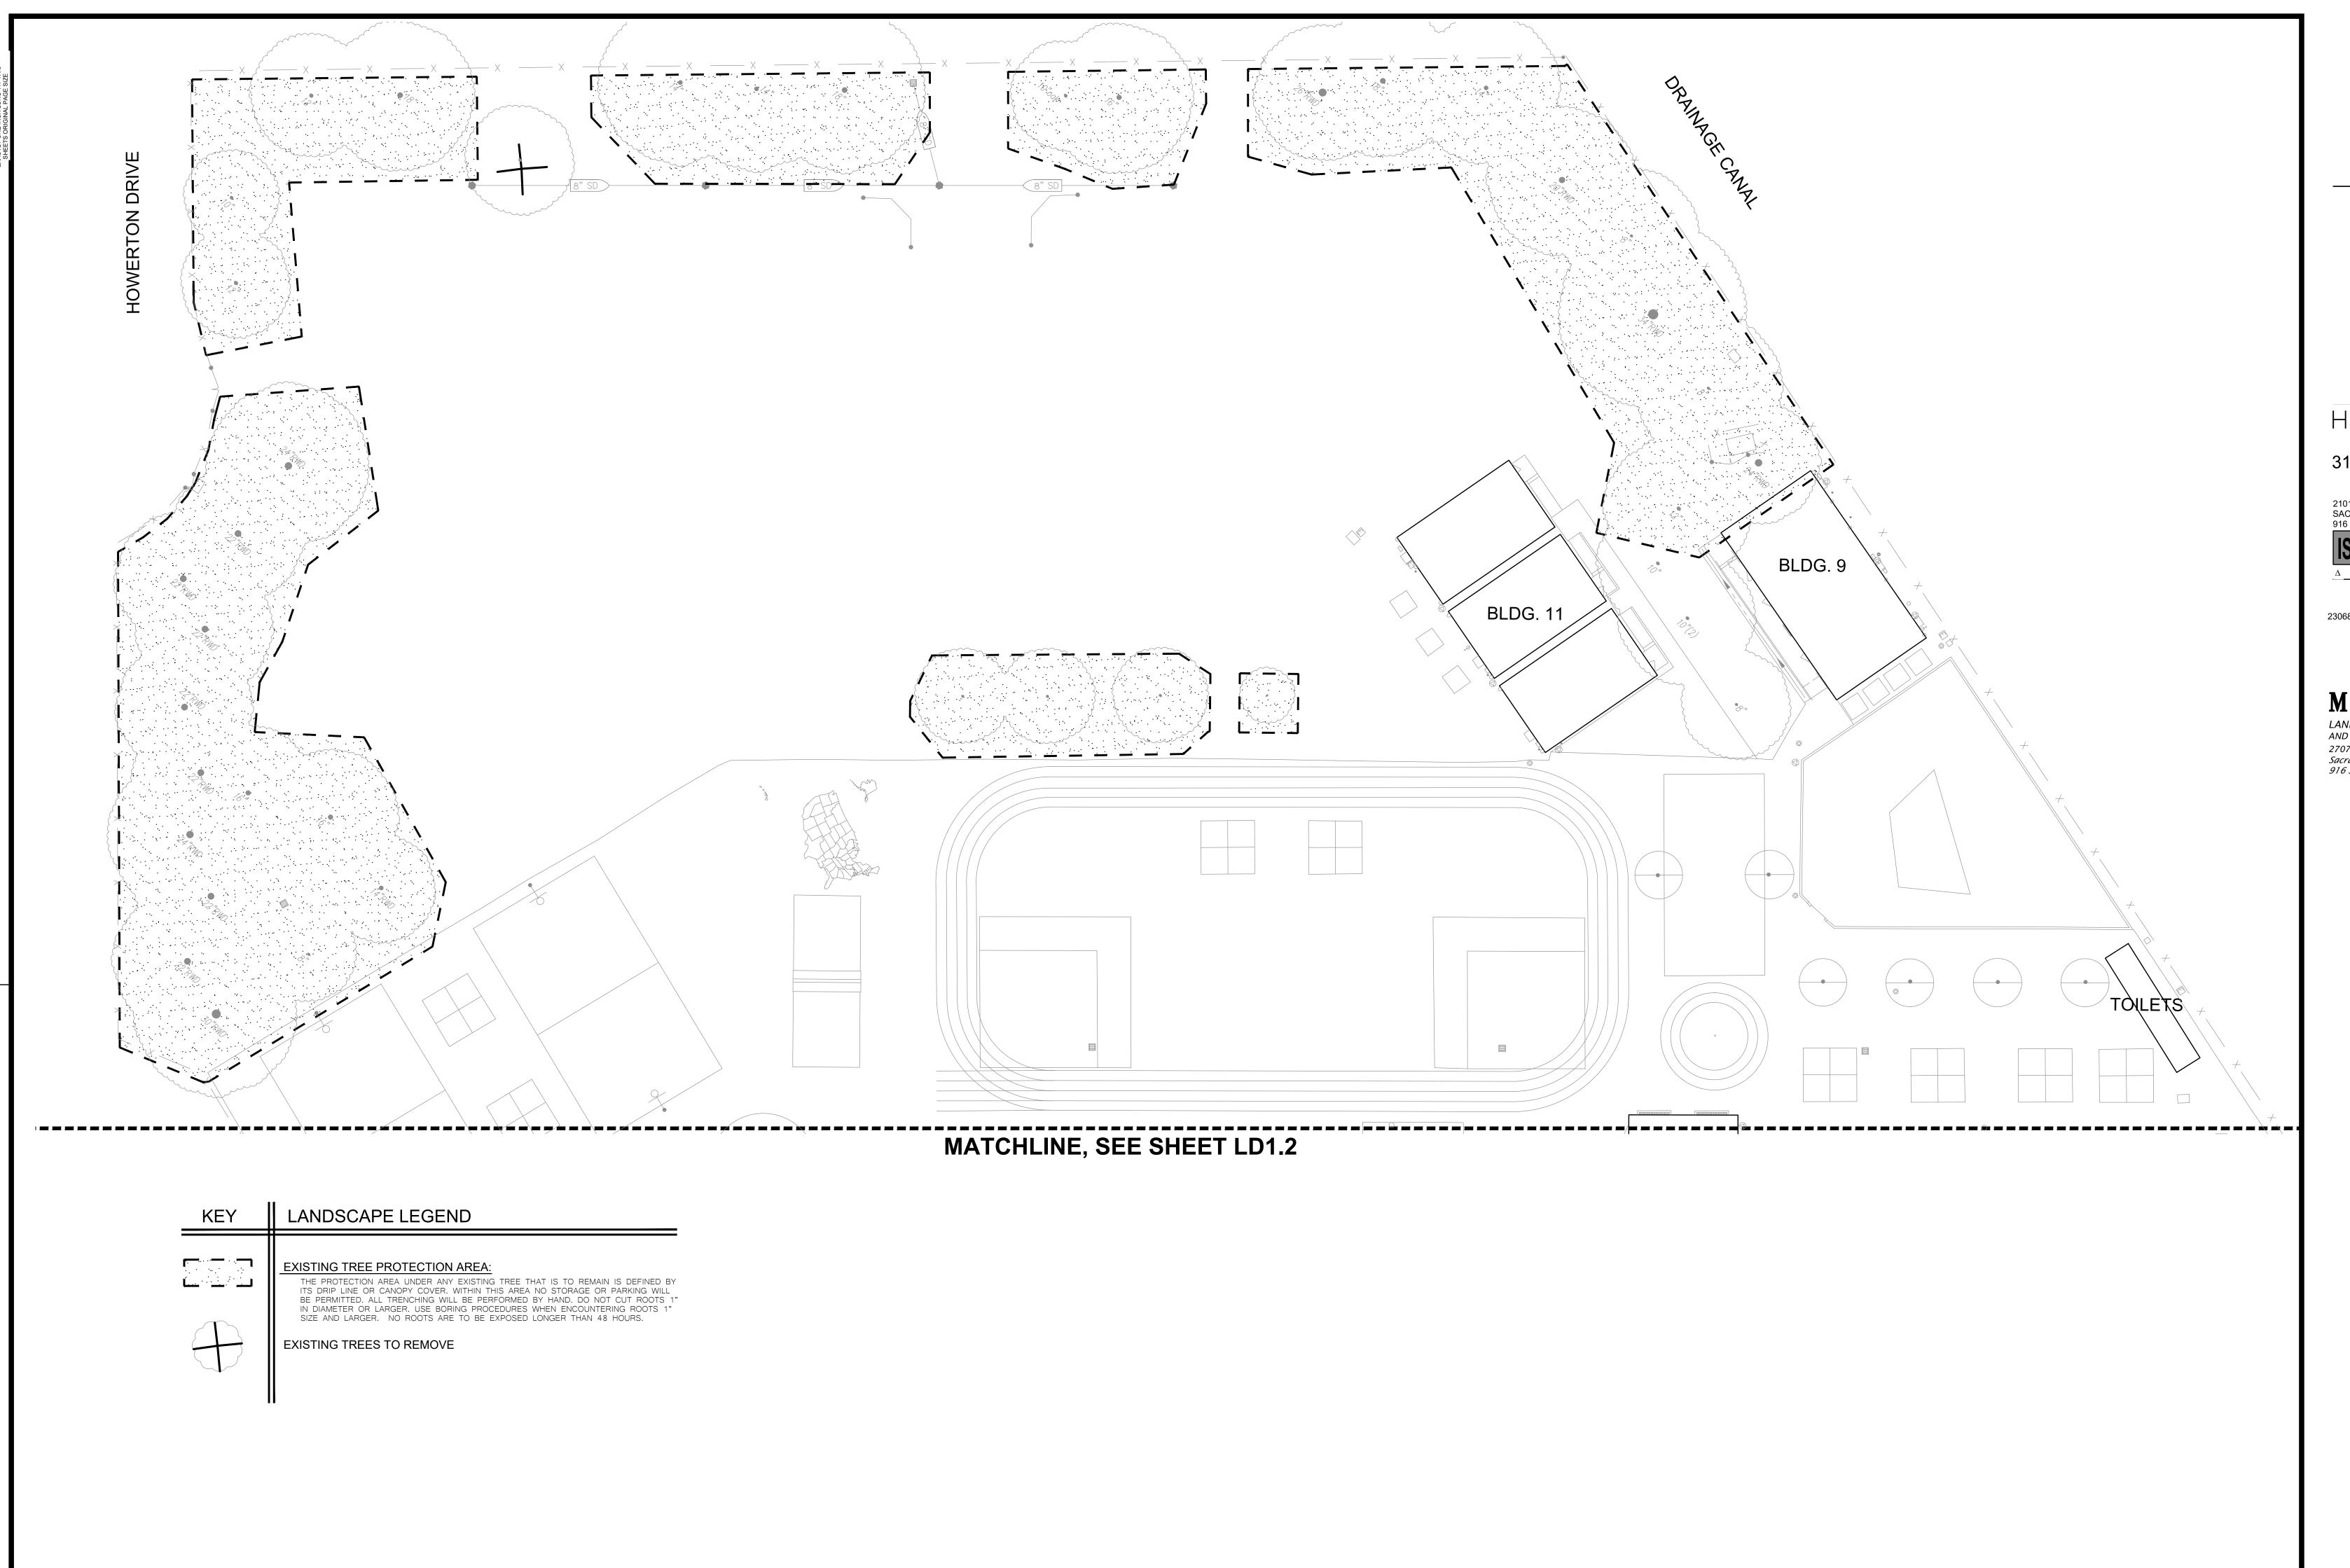

SCALE: 1"= 20'-0"

AGENCY APPROVAL:



HMC Architects

3186-070-000

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Δ DESCRIPTION

LANDSCAPE ARCHITECTURE
AND PLANNING
2707 K Street, Suite 201
Sacramento, CA 95816
916 369-3990

DATE ____

Peter D. Larimer


MATSUYAMA ELEMENTARY SCHOOL 7680 WINDBRIDGE DR. SACRMANETO, CA 95831

MATSUYAMA ELEMENTARY SCHOOL MODERNIZATION

TREE PROTECTION PLAN

DSA SUBMITTAL

CLIENT PROJ NO: 3186-070-000 DATE: 01/04/2024

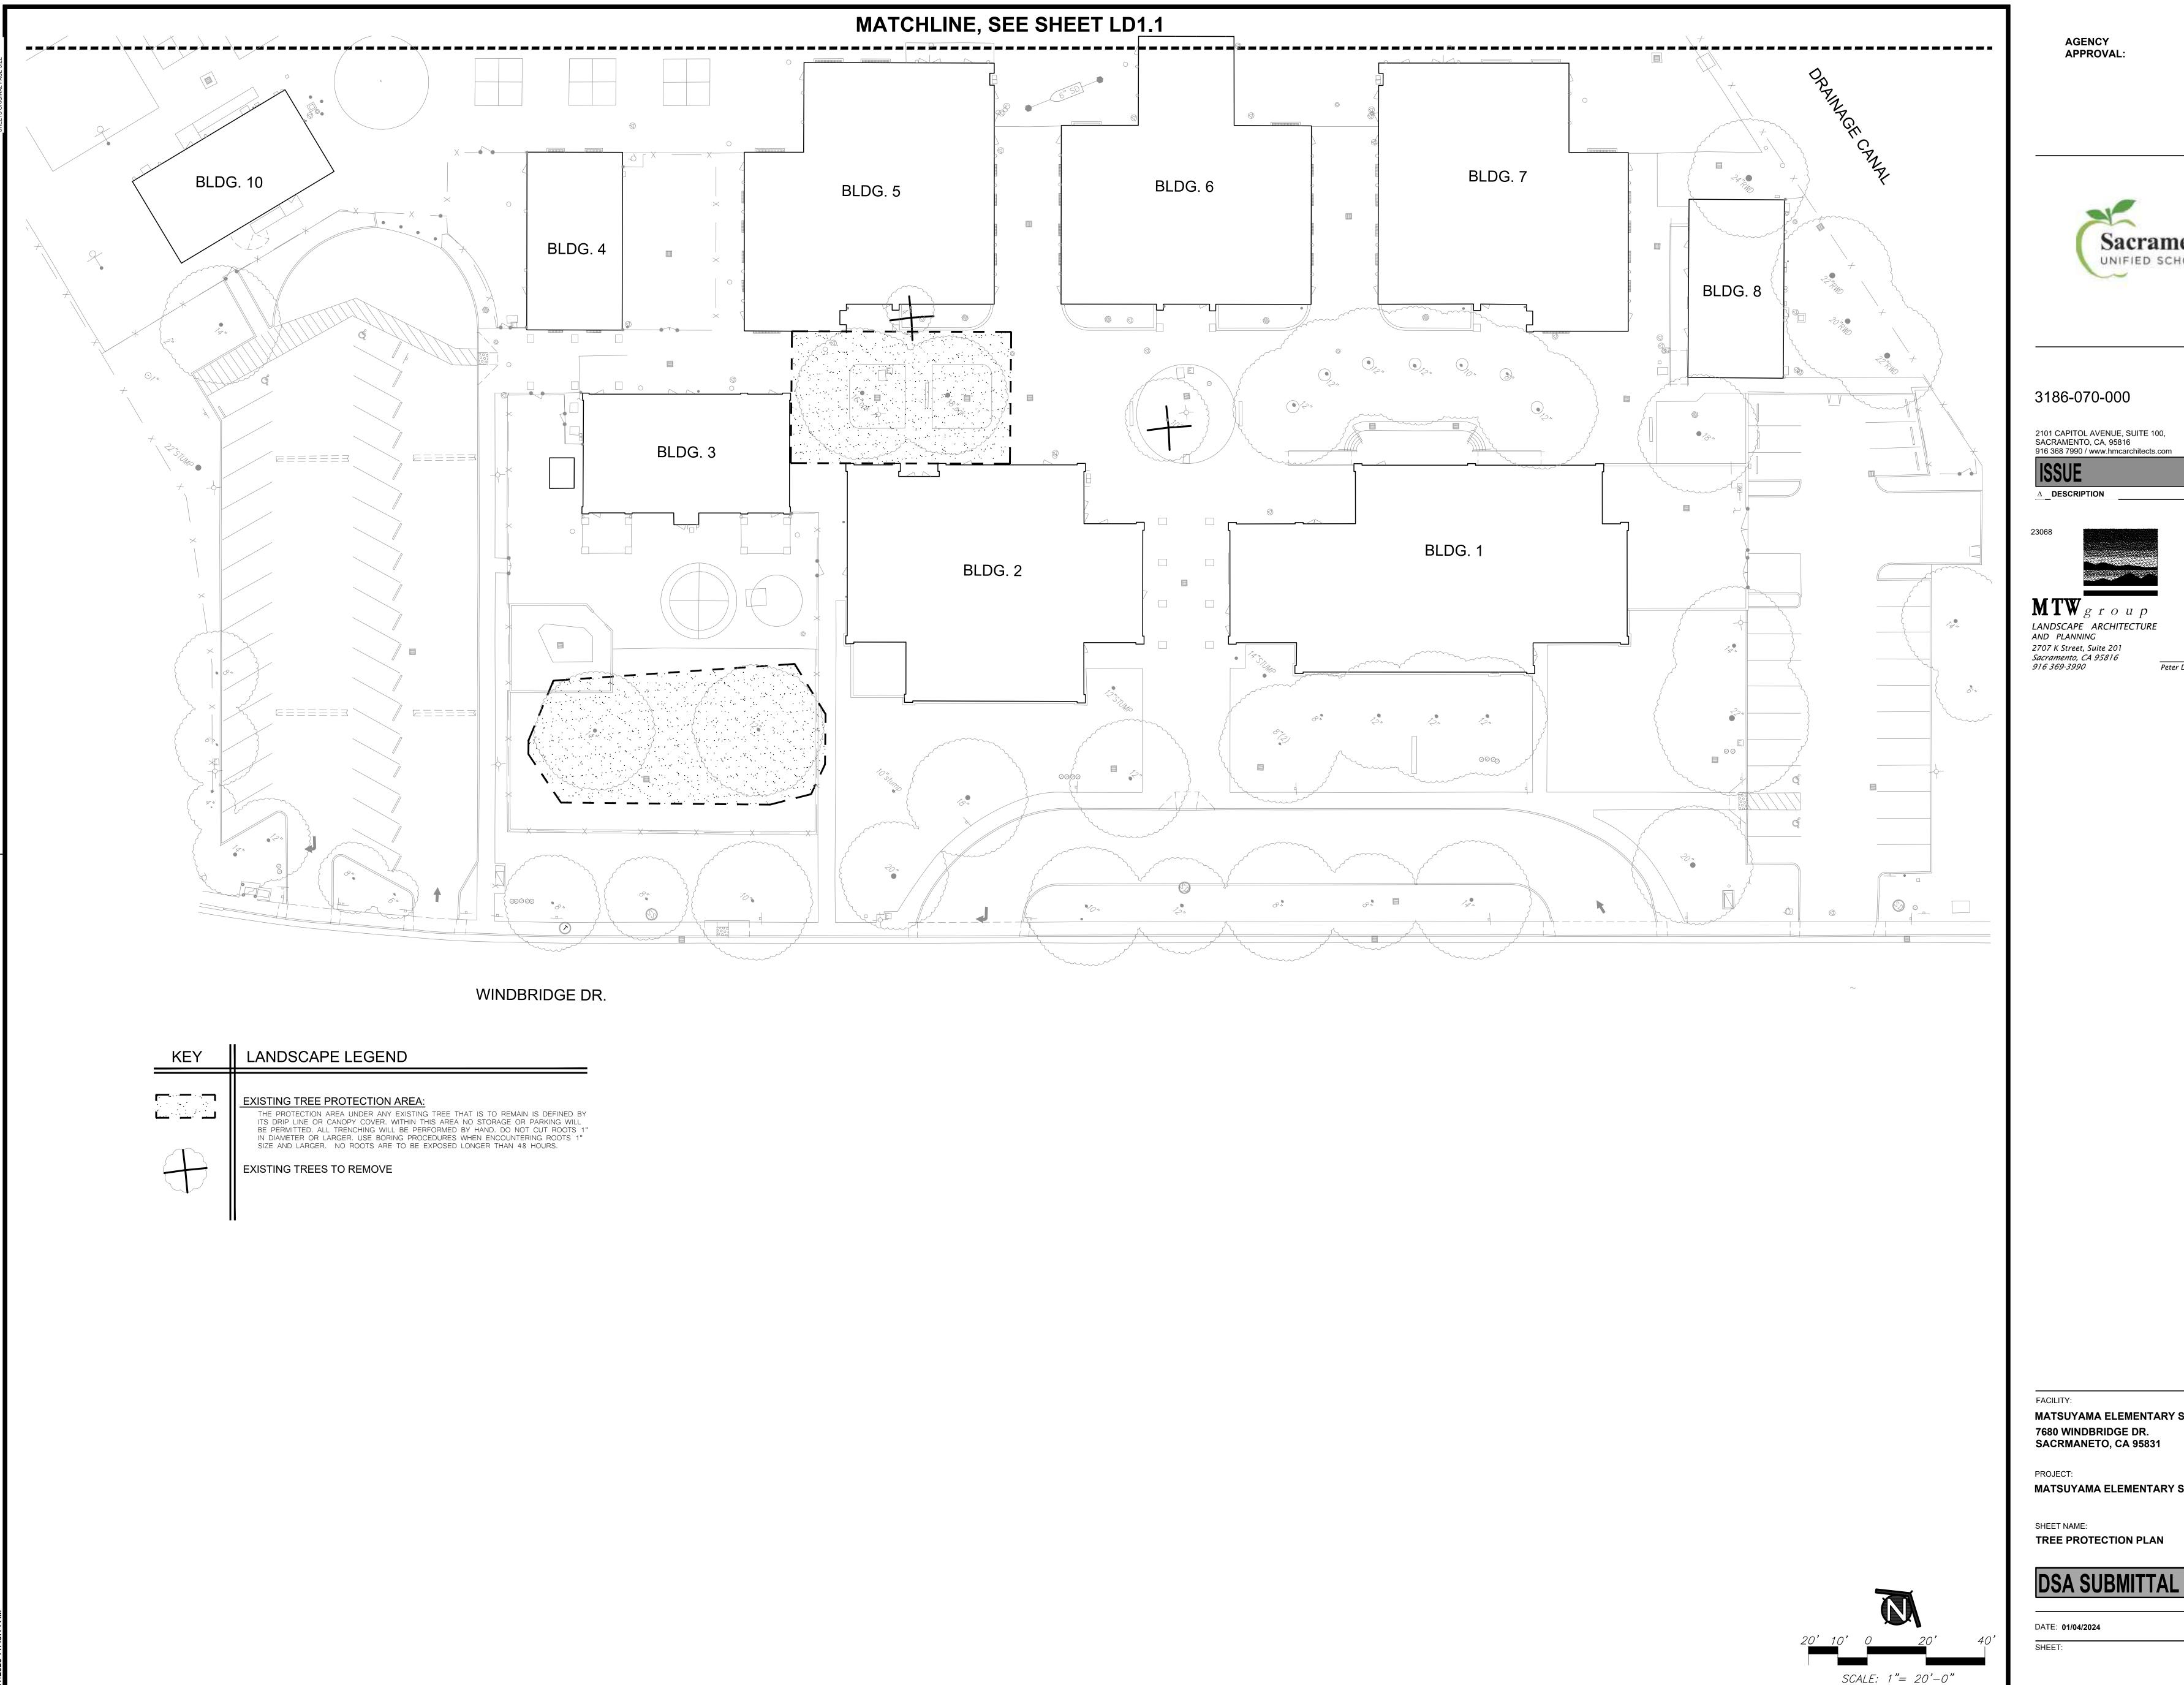




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Peter D. Larimer

MATSUYAMA ELEMENTARY SCHOOL 7680 WINDBRIDGE DR.

MATSUYAMA ELEMENTARY SCHOOL MODERNIZATION

TREE PROTECTION PLAN

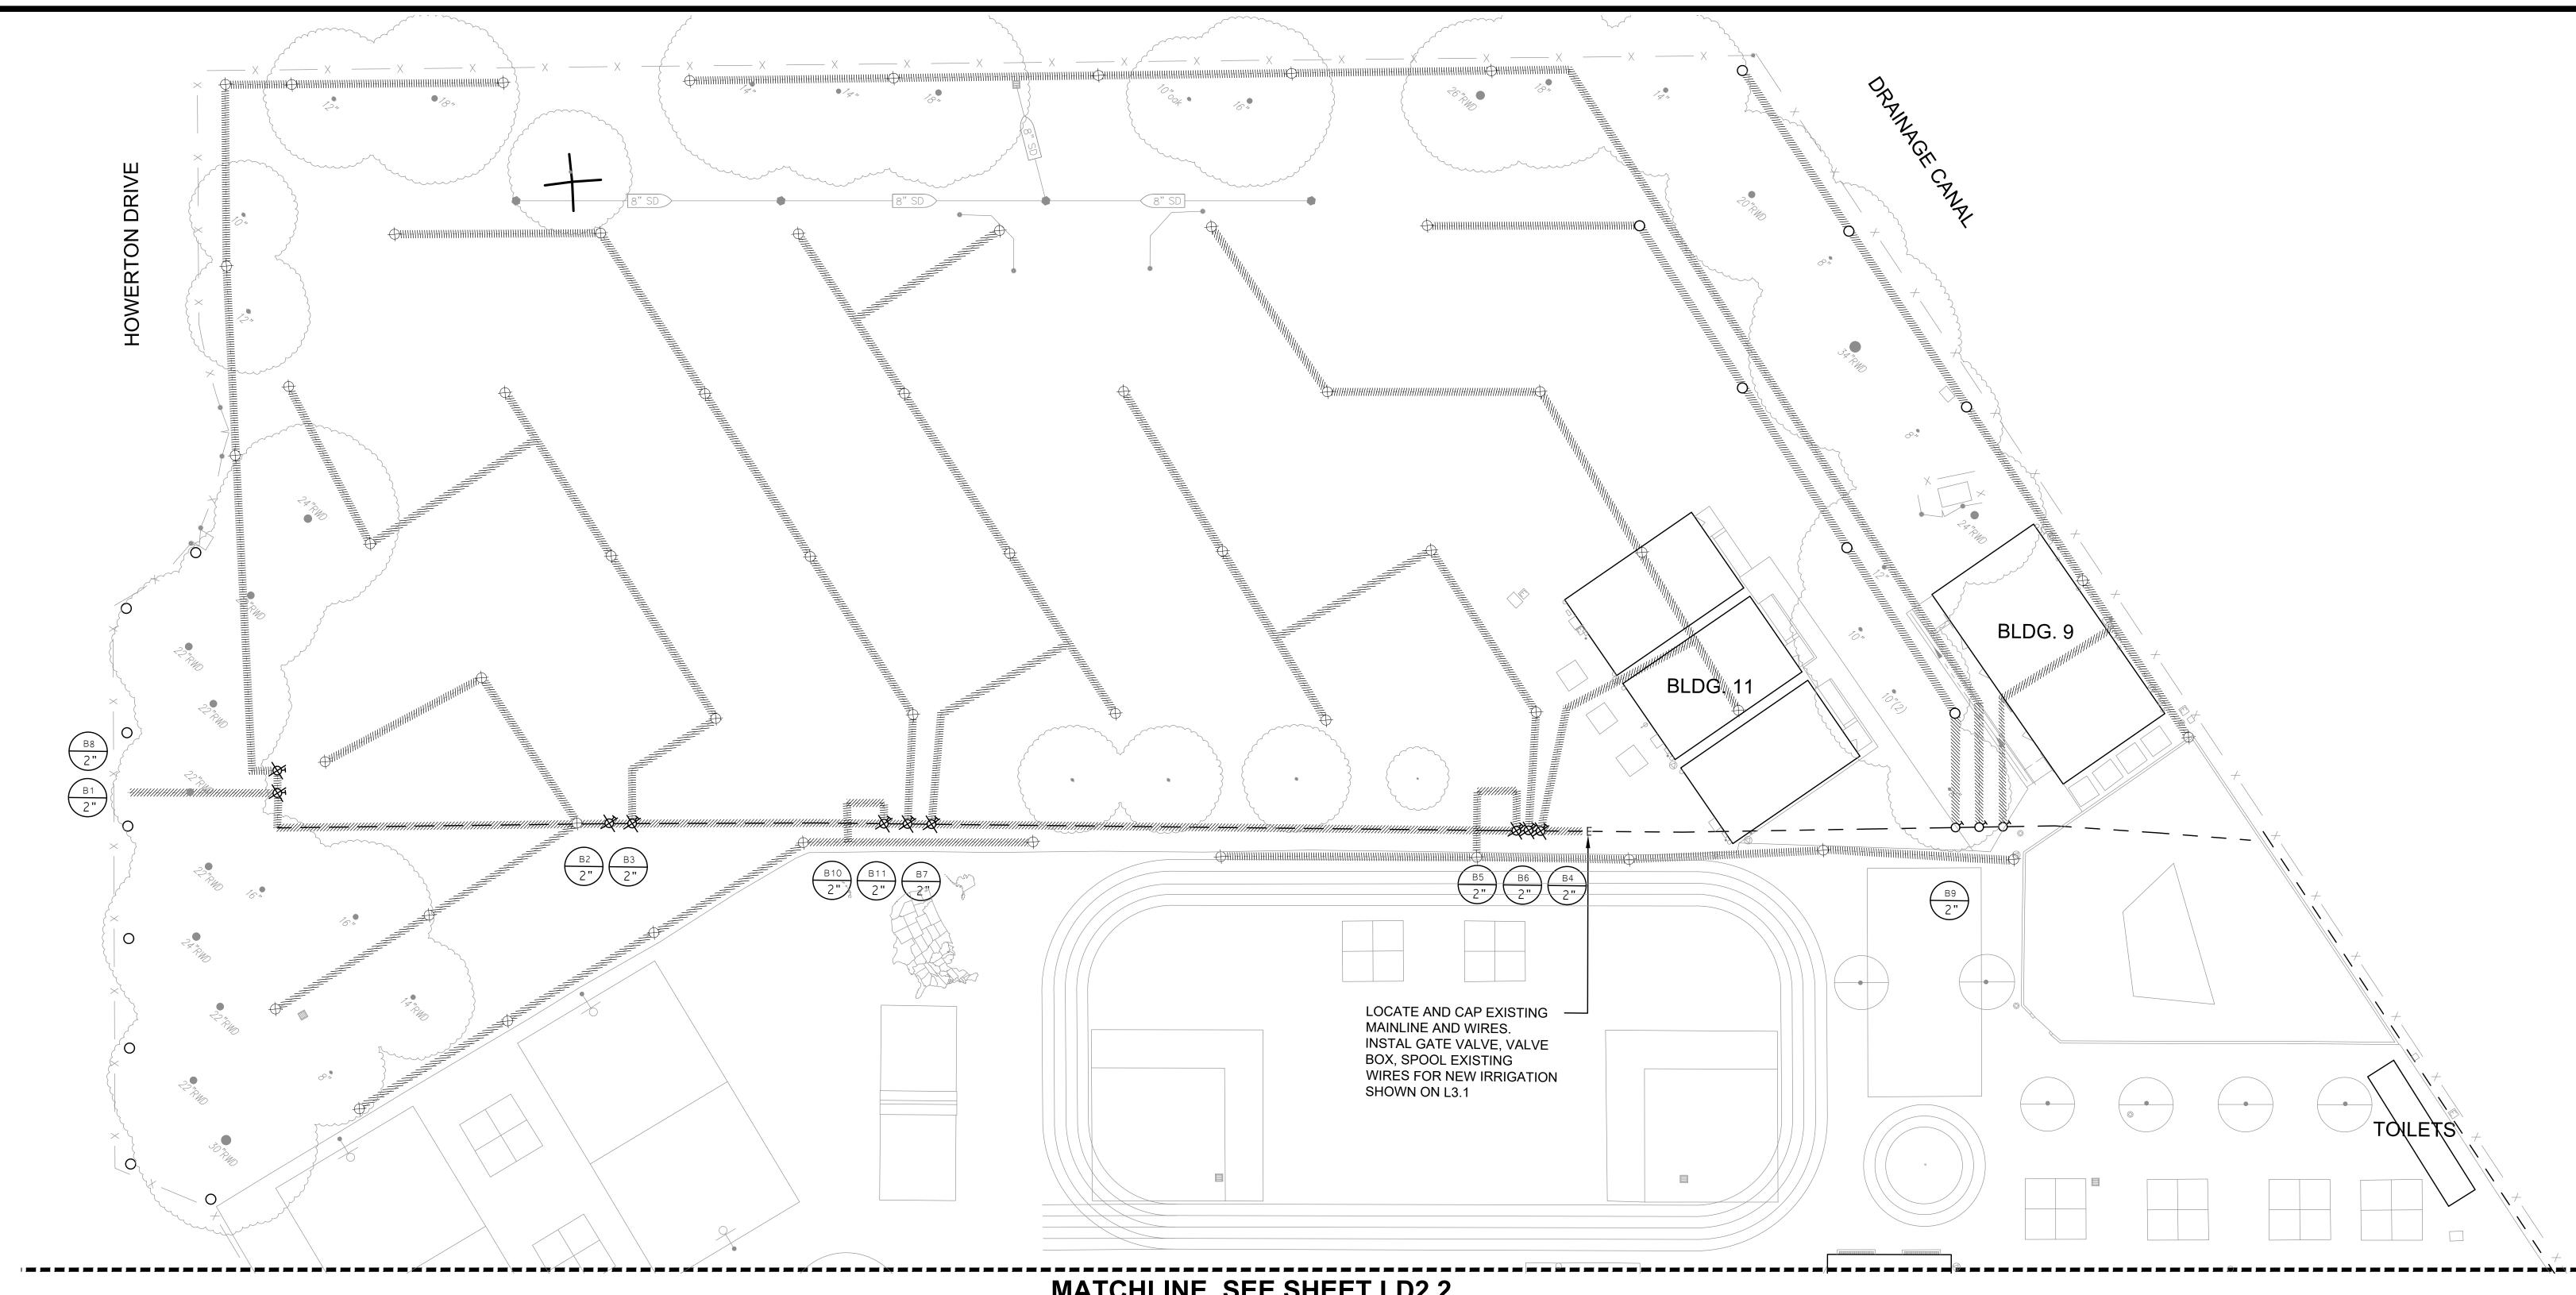

MATCHLINE, SEE SHEET LD2.2

KEY	IRRIGATION DEMOLITION LEGEND			
	EXISTING TREE TO REMAIN			
	EXISTING TREES TO REMOVE			
\boxtimes	EXISTING BOOSTER PUMP TO REMOVE			
	EXISTING IRRIGATION CONTROLLER TO BE REMOVED			
Q,	EXISTING AUTOMATIC CONTROL VALVE TO REMAIN			
#	EXISTING AUTOMATIC CONTROL VALVE TO REMOVE			
0	EXISTING SPRINKLER HEAD TO REMAIN			
\boxtimes	EXISTING SPRINKLER HEAD TO REMOVE			
	EXISTING IRRIGATION MAINLINE TO REMAIN			
4444//4444//4444	EXISTING IRRIGATION MAINLINE TO REMOVE			
	EXISTING LATERAL LINE TO REMAIN			
WWW.	EXISTING LATERAL LINE TO REMOVE			
\bigwedge_{A1}	INDICATES CONTROL VALVE AND STATION NUMBER			
2"	INDICATES CONTROL VALVE SIZE			
	1			

PRE-CONSTRUCTION SPRINKLER IRRIGATION NOTES

- 1. PRIOR TO START OF CONSTRUCTION CONTRACTOR REQUIRED TO CONTACT DISTRICT PERSONAL TO SET UP A MEETING ON SITE TO OPERATE THE EXISTING SPRINKLER IRRIGATION SYSTEM AND
- 2. CONTRACTOR TO OPERATE AND PROGRAM EXISTING SPRINKLER IRRIGATION SYSTEM THAT IS TO REMAIN IN ORDER TO PROVIDE WATER TO THE EXISTING LANDSCAPE TO REMAIN.
- 3. CONTRACTOR TO REMOVE ALL EXISTING PIPE AND SPRINKLER HEADS WHEN THEY ARE IN NEW
- 4. CONTRACTOR TO RESTORE AND REPAIR ANY EXISTING SPRINKLER IRRIGATION SYSTEM OR EXISTING LANDSCAPE WHICH IS IN AREAS TO REMAIN THAT IS DAMAGED BY NEW WORK.
- 5. ALL WORK TO EXISTING SPRINKLER IRRIGATION SYSTEM TO BE COMPLETED PRIOR TO SITE DEMOLITION.

SCALE: 1"= 20'-0"

AGENCY APPROVAL:

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Δ DESCRIPTION



LANDSCAPE ARCHITECTURE AND PLANNING 2707 K Street, Suite 201 Sacramento, CA 95816 916 369-3990

DATE

Peter D. Larimer


MATSUYAMA ELEMENTARY SCHOOL 7680 WINDBRIDGE DR. SACRMANETO, CA 95831

MATSUYAMA ELEMENTARY SCHOOL MODERNIZATION

IRRIGATION DEMOLITION PLAN

DSA SUBMITTAL

CLIENT PROJ NO: 3186-070-000 DATE: 01/04/2024

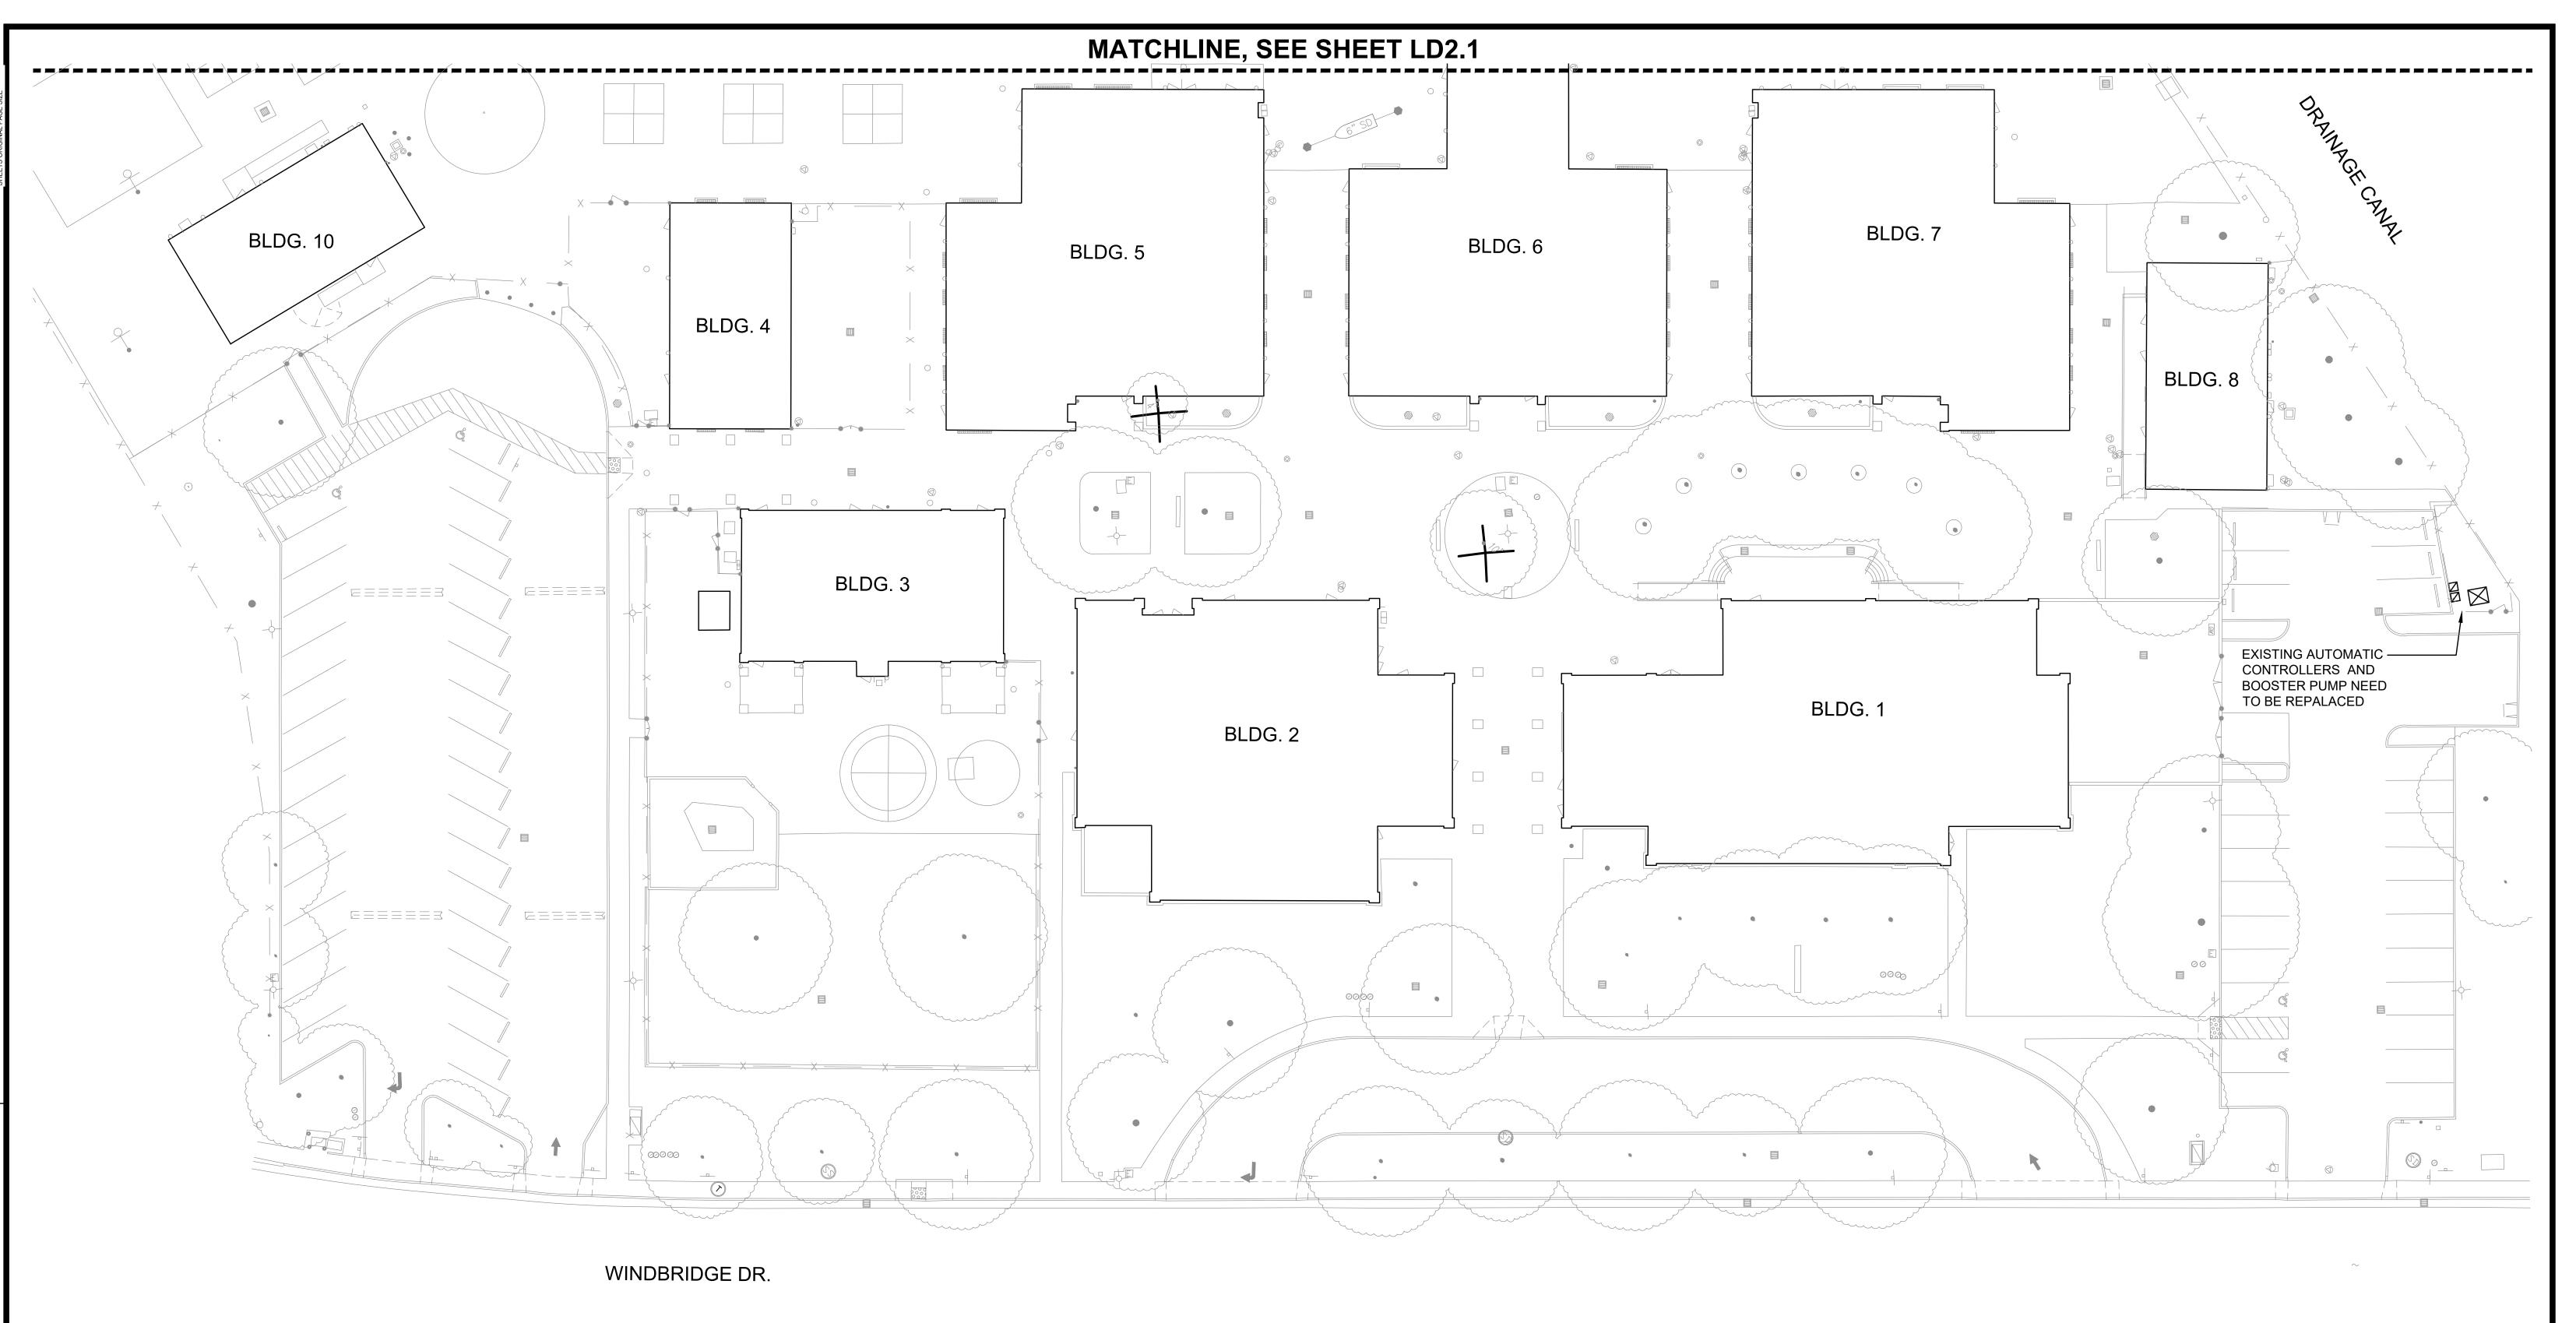

KEY	IRRIGATION DEMOLITION LEGEND
	EXISTING TREE TO REMAIN
	EXISTING TREES TO REMOVE
\boxtimes	EXISTING BOOSTER PUMP TO REMOVE
	EXISTING IRRIGATION CONTROLLER TO BE REMOVED
Q,	EXISTING AUTOMATIC CONTROL VALVE TO REMAIN
#	EXISTING AUTOMATIC CONTROL VALVE TO REMOVE
0	EXISTING SPRINKLER HEAD TO REMAIN
\boxtimes	EXISTING SPRINKLER HEAD TO REMOVE
	EXISTING IRRIGATION MAINLINE TO REMAIN
44441/44441/4444.	EXISTING IRRIGATION MAINLINE TO REMOVE
	EXISTING LATERAL LINE TO REMAIN
411111111111111111111111111111111111111	EXISTING LATERAL LINE TO REMOVE
A1	INDICATES CONTROL VALVE AND STATION NUMBER
2"	INDICATES CONTROL VALVE SIZE

PRE-CONSTRUCTION SPRINKLER IRRIGATION NOTES

- 1. PRIOR TO START OF CONSTRUCTION CONTRACTOR REQUIRED TO CONTACT DISTRICT PERSONAL TO SET UP A MEETING ON SITE TO OPERATE THE EXISTING SPRINKLER IRRIGATION SYSTEM AND DISCUSS THE MODIFICATIONS THAT ARE TO BE MADE TO THE EXISTING SYSTEM TO ACCOMMODATE FOR THE NEW CONSTRUCTION.
- 2. CONTRACTOR TO OPERATE AND PROGRAM EXISTING SPRINKLER IRRIGATION SYSTEM THAT IS TO REMAIN IN ORDER TO PROVIDE WATER TO THE EXISTING LANDSCAPE TO REMAIN.
- 3. CONTRACTOR TO REMOVE ALL EXISTING PIPE AND SPRINKLER HEADS WHEN THEY ARE IN NEW PLANTING AREAS.
- 4. CONTRACTOR TO RESTORE AND REPAIR ANY EXISTING SPRINKLER IRRIGATION SYSTEM OR
- EXISTING LANDSCAPE WHICH IS IN AREAS TO REMAIN THAT IS DAMAGED BY NEW WORK.
- 5. ALL WORK TO EXISTING SPRINKLER IRRIGATION SYSTEM TO BE COMPLETED PRIOR TO SITE DEMOLITION.

DSA SUBMITTAL DATE: 01/04/2024

HMC Architects 3186-070-000 2101 CAPITOL AVENUE, SUITE 100, SACRAMENTO, CA, 95816 916 368 7990 / www.hmcarchitects.com DATE ____ $\mathbf{M} \mathbf{T} \mathbf{W} g r o u p$

AGENCY APPROVAL:

Peter D. Larimer

2707 K Street, Suite 201 Sacramento, CA 95816

MATSUYAMA ELEMENTARY SCHOOL MODERNIZATION

7680 WINDBRIDGE DR. SACRMANETO, CA 95831

IRRIGATION DEMOLITION PLAN

MATSUYAMA ELEMENTARY SCHOOL

CLIENT PROJ NO: 3186-070-000

SCALE: 1"= 20'-0"

KEY	LANDSCAPE LEGEND
100% 100% 7-AAA.	TREES - NOT ALL SYMBOLS SHOWN WITH TREE SHADING CANOPY PERCENTAGE SHADE PERCENTAGE CONCRETE MOWSTRIP REDWOOD HEADERBOARD ROOT BARRIER, INSTALL WHERE SHOWN ON PLANS PLANT QUANTITY PLANT KEY
	EXISTING TREES TO REMAIN

TREE MATERIAL LIST

SIZE	QTY.	KEY	BOTANICAL NAME COMMON NAME	WATER USE
			TREES:	
24" BOX 24" BOX	4 1	ACE.R. CER.	ACER RUBRUM 'OCTOBER GLORY' RED MAPLE CERCIS CANADENSIS RED BUD	MEDIUM LOW

GENERAL LANDSCAPE REQUIREMENTS/NOTES

- 1. NO PLANTING SHALL BE STARTED UNTIL SPRINKLER IRRIGATION SYSTEM HAS BEEN TESTED BY CONTRACTOR IN PRESENCE OF OWNER'S REPRESENTATIVE AND NOTED DEFICIENCIES CORRECTED.
- 2. NO PLANTING SHALL BE STARTED UNTIL SOIL PREPARATION AND FINISH GRADING OPERATIONS HAVE BEEN COMPLETED AND APPROVED BY THE OWNER'S REPRESENTATIVE.
- 3. QUANTITIES SHOWN ON PLANT MATERIAL LIST ARE APPROXIMATE. PROVIDE QUANTITIES INDICATED ON LANDSCAPE PLAN.
- 4. PLANT MATERIAL IS SUBJECT TO APPROVAL OF OWNER'S REPRESENTATIVE.

5. SEE SHEET L4.1 FOR PLANTING INSTALLATION DETAILS. ENVIRONMENTAL REQUIREMENTS:

GENERAL: PROCEED WITH WORK IN ORDERLY AND TIMELY MANNER TO COMPLETE INSTALLATION OF LANDSCAPING WITHIN CONTRACT LIMITS.

PROTECTION:

EXISTING CONSTRUCTION: EXECUTE WORK IN AN ORDERLY AND CAREFUL MANNER TO PROTECT NEW CONCRETE WALKS, WORK OF OTHER TRADES, AND OTHER IMPROVEMENTS.

EXISTING UTILITIES: DETERMINE LOCATION OF UNDERGROUND UTILITIES AND PERFORM WORK IN A MANNER WHICH WILL AVOID POSSIBLE DAMAGE. HAND EXCAVATE, AS REQUIRED, TO MINIMIZE POSSIBILITY OF DAMAGE TO UNDERGROUND UTILITIES. MAINTAIN GRADE STAKES SET BY OTHERS UNTIL REMOVAL IS MUTUALLY AGREED UPON BY ALL PARTIES CONCERNED. BE RESPONSIBLE FOR PROTECTION OF EXISTING UTILITIES WITHIN CONSTRUCTION AREA; REPAIR DAMAGE TO UTILITIES THAT OCCUR AS A RESULT OF OPERATIONS OF THIS WORK.

LANDSCAPING: PROTECT LANDSCAPE WORK AND MATERIALS FROM DAMAGE DUE TO LANDSCAPE OPERATIONS, OPERATIONS BY OTHER CONTRACTORS AND TRADES AND TRESPASSERS. MAINTAIN PROTECTION DURING INSTALLATION AND MAINTENANCE PERIODS. TREAT, REPAIR OR REPLACE DAMAGED LANDSCAPE WORK AS DIRECTED AT NO ADDITIONAL COST TO CONTRACT.

ADVERSE CONDITIONS: WHEN CONDITIONS DETRIMENTAL TO SOD OR PLANT GROWTH ARE ENCOUNTERED, SUCH AS RUBBLE FILL, ADVERSE DRAINAGE CONDITIONS, OR OBSTRUCTIONS, NOTIFY OWNER'S REPRESENTATIVE BEFORE STARTING WORK.

PLANTING AND TURF INSTALLATION SEASONS AND CONDITIONS NO WORK SHALL BE DONE WHEN GROUND IS FROZEN, SNOW COVERED, TOO WET OR IN

NO WORK SHALL BE DONE WHEN GROUND IS FROZEN, SNOW COVERED, TOO WET OR IN AN OTHERWISE UNSUITABLE CONDITION FOR AMENDING SOIL, FINISH GRADING OR PLANTING.

SOIL TESTING/SOIL IMPROVEMENT:

SEE SPECIFICATIONS 32 90 00, SECTION 3.02 SOIL TESTING AND SECTION 3.03 PREPARATION.

SOIL PERCOLATION


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PLANT MATERIAL STANDARDS

PLANTS SHALL BE IN ACCORDANCE WITH AMERICAN NATIONAL STANDARDS INSTITUTE (ANSI) ANSI Z60.1-AMERICAN STANDARD FOR NURSERY STOCK, EXCEPT AS OTHERWISE STATED IN SPECIFICATIONS OR SHOWN ON DRAWINGS. WHERE DRAWINGS OR SPECIFICATIONS ARE IN CONFLICT WITH ANSI Z60.1, DRAWINGS AND SPECIFICATIONS SHALL PREVAIL. PRUNE, THIN OUT AND SHAPE TREES IN ACCORDANCE WITH ANSI STANDARD HORTICULTURAL PRACTICE. PRUNE TREES TO RETAIN REQUIRED HEIGHT AND SPREAD. UNLESS OTHERWISE DIRECTED BY LANDSCAPE ARCHITECT, DO NOT CUT TREE LEADERS, AND REMOVE ONLY INJURED OR DEAD BRANCHES FROM FLOWERING TREES.

EXISTING LANDSCAPE AND SPRINKLER IRRIGATION SYSTEM

WORK LIMITS OF THIS PROJECT EXTEND INTO AREAS THAT WERE PREVIOUSLY DEVELOPED UNDER OTHER CONTRACTS. PRIOR TO START OF WORK, CONTRACTOR SHALL MEET WITH OWNER'S REPRESENTATIVE TO LOCATE ALL CONNECTIONS CALLED FOR ON DRAWINGS. WORK LIMITS/FENCING SHALL BE LAID OUT BY CONTRACTOR AND VERIFIED BY OWNER'S REPRESENTATIVE. FENCE TO BE INSTALLED AND IRRIGATION SYSTEM SHALL BE TESTED WITH CONTRACTOR, INSPECTOR, AND OWNER'S REPRESENTATIVE PRESENT. DEFICIENCIES SHALL BE NOTED AT THIS TIME AND ARE THE RESPONSIBILITY OF OWNER. AT COMPLETION OF WORK, SYSTEM WILL AGAIN BE TESTED, DEFICIENCIES NOTED AT THIS TIME THAT WERE NOT NOTED PREVIOUSLY WILL BE RESPONSIBILITY OF CONTRACTOR. EXISTING LANDSCAPE THAT HAS BEEN DAMAGED DUE TO CONSTRUCTION SHALL BE RESTORED TO ORIGINAL CONDITION BY CONTRACTOR AT NO ADDITIONAL COST TO OWNER. PRIOR TO MAKING ANY CONNECTION TO MAIN LINE, CONTRACTOR SHALL NOTIFY OWNER 1 WEEK IN ADVANCE SO ADJUSTMENTS TO EXISTING WATERING PROGRAMS CAN BE MADE.

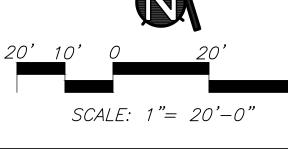

AGENCY APPROVAL:



HMC Architects

3186-070-000

2101 CAPITOL AVENUE, SUITE 100, SACRAMENTO, CA, 95816 916 368 7990 / www.hmcarchitects.com

△ DESCRIPTION

23068



MIW group

LANDSCAPE ARCHITECTURE

AND PLANNING

2707 K Street, Suite 201

Sacramento, CA 95816

916 369-3990

Peter D. Larimer

DATE

FACILITY

MATSUYAMA ELEMENTARY SCHOOL 7680 WINDBRIDGE DR. SACRMANETO, CA 95831

JECT:

MATSUYAMA ELEMENTARY SCHOOL MODERNIZATION

SHEET NAME:
TREE PLANTING PLAN

DSA SUBMITTAL

DATE: **01/04/2024**

4/2024 CLIENT PROJ NO: 3186-070-000

L1.

MATCHLINE, SEE SHEET L2.2

BOTANICAL NAME ... COMMON NAME

PLANT MATERIAL LIST

SIZE QTY. KEY

LANDSCAPE LEGEND			
TREE OUTLINE FOR REFERENCE			
SHRUBS			
3" DEPTH BARK MULCH			
LAWN (SOD)			
SHRUBS/GROUNDCOVER			
DECOMPOSED GRANITE			
CONCRETE MOWSTRIP			
REDWOOD HEADERBOARD			
PLANT QUANTITY			
—PLANT KEY			
EXISTING TREES TO REMAIN			

SIZE	QTY.	KEY	BOTANICAL NAME COMMON NAME	
			SHRUBS:	
1 G.C. C.		ABE. AGA. ARC. AZA. BAC. BUL. CAR. CEA. CIS. COP. DIE. ESC. EUO. GRE.N. LIG. LOR. MAH. NAN. PHO. PIT. RHA.J. ROS. SAL. VIB. WES. XYL.	ABELIA GRANDIFLORA 'SHERWOODII' GLOSSY ABELIA AGAPANTHUS AFRICANUS LILY-OF-THE-NILE ANIGOZANTHOS FLAVIDUS KANGAROO PAW ARCTOSTAPHYLOS SPECIES MANZANITA AZALEA (WHITE) WHITE DECIDUOUS AZALEA BACCHARIS PILULARIS 'TWIN PEAKS' DWARF COYOTE BRUSH BULBINE FRUTESCENS 'HALLMARK' HALLMARK BULBINE CALLISTEMON VIMINALIS 'LITTLE JOHN' DWARF WEEPING BOTTLEBRUSH CAREX DIVULSA EUROPEAN GREY SEDGE CEANOTHUS 'JOYCE COULTER' CEANOTHUS CISTUS HYBRIDUS WHITE ROCKROSE COPROSMA REPENS MIRROR PLANT COTONEASTER PARNEYI PARNEY COTONEASTER DIETES VEGETA FORTNIGHT LILY ESCALLONIA RUBBA 'NEWPORT DWARF' DWARF ESCALLONIA EUONYMUS MICROPHYLLA 'VARIEGATA' VARIEGATED EUONYMUS GREVILLEA LANIGERA 'MT. TAMBORITHA' WOOLY GREVILLEA GREVILLEA NOELII GREVILLEA HYPERICUM MOSERANUM GOLD FLOWER LIGUSTRUM JAPONICUM 'TEXANUM' WAX-LEAF PRIVET LIRIOPE MUSCARI LILY TURF LOMANDRA 'PLATINUM BEAUTY' PLATINUM BEAUTY LOMANDRA LOROPETALUM CHINENSE 'RUBRUM' CHINESE FRINGE FLOWER MAHONIA 'SOFT CARESS' SOFT CARESS OREGON GRAPE MUHLENBERGIA RIGENS DEER GRASS NANDINA DOMESTICA 'HARBOR DWARF' DWARF HEAVENLY BAMBOO PHOTINIA FRASERI PHOTINIA PITTOSPORUM TOBIRA 'WHEELER'S DWARF' DWARF PITTOSPORUM RHAPHIOLEPIS INDICA 'JACK EVANS' DWARF INDIA HAWTHORN RHAPHIOLEPIS UMBELLATA 'SOUTHERN MOON' YEDDA HAWTHORN RHAPHIOLEPIS UMBELLATA 'SOUT	LOW
			GROUNDCOVER:	
1 G.C. 1 G.C. FLATS 1 G.C. 1 G.C. 1 G.C. 1 G.C. 1 G.C. 1 G.C.	48" O.C. 60" O.C. 9" O.C. 48" O.C. 48" O.C. 36" O.C. 36" O.C. 36" O.C. 36" O.C.	ARC.E. COT.H. GAZ. JUN.S. LAN. MYO. ROS. SCA. TRA.A. TRA.J. VIN.	ARCTOSTAPHYLOS 'EMERALD CARPET' MANZANITA COTONEASTER HORIZONTALIS ROCK COTONEASTER GAZANIA 'MITSUWA YELLOW' TRAILING GAZANIA JUNIPERUS SABINA 'BUFFALO' JUNIPER LANTANA 'GOLD RUSH' YELLOW LANTANA MYOPORUM PARVIFOLIUM MYOPORUM ROSMARINUS 'PROSTRATUS' DWARF ROSEMARY SCAEVOLA 'MAUVE CLUSTERS' FAN FLOWER TRACHELOSPERMUM ASIATICUM ASIAN JASMINE TRACHELOSPERMUM JASMINOIDES STAR JASMINE VINCA MINOR DWARF PERIWINKLE	LOW

GENERAL LANDSCAPE REQUIREMENTS/NOTES

- 1. NO PLANTING SHALL BE STARTED UNTIL SPRINKLER IRRIGATION SYSTEM HAS BEEN TESTED BY CONTRACTOR IN PRESENCE OF OWNER'S REPRESENTATIVE AND NOTED DEFICIENCIES CORRECTED.
- 2. NO PLANTING SHALL BE STARTED UNTIL SOIL PREPARATION AND FINISH GRADING OPERATIONS HAVE BEEN COMPLETED AND APPROVED BY THE OWNER'S REPRESENTATIVE.
- 3. QUANTITIES SHOWN ON PLANT MATERIAL LIST ARE APPROXIMATE. PROVIDE QUANTITIES INDICATED ON LANDSCAPE PLAN.
- 4. PLANT MATERIAL IS SUBJECT TO APPROVAL OF OWNER'S REPRESENTATIVE.
- 5. SEE SHEET L4.1 FOR PLANTING INSTALLATION DETAILS. **ENVIRONMENTAL REQUIREMENTS:**

GENERAL: PROCEED WITH WORK IN ORDERLY AND TIMELY MANNER TO COMPLETE INSTALLATION OF LANDSCAPING WITHIN CONTRACT LIMITS.

PROTECTION:

WATER

EXISTING CONSTRUCTION: EXECUTE WORK IN AN ORDERLY AND CAREFUL MANNER TO PROTECT NEW CONCRETE WALKS, WORK OF OTHER TRADES, AND OTHER IMPROVEMENTS.

EXISTING UTILITIES: DETERMINE LOCATION OF UNDERGROUND UTILITIES AND PERFORM WORK IN A MANNER WHICH WILL AVOID POSSIBLE DAMAGE. HAND EXCAVATE, AS REQUIRED, TO MINIMIZE POSSIBILITY OF DAMAGE TO UNDERGROUND UTILITIES. MAINTAIN GRADE STAKES SET BY OTHERS UNTIL REMOVAL IS MUTUALLY AGREED UPON BY ALL PARTIES CONCERNED. BE RESPONSIBLE FOR PROTECTION OF EXISTING UTILITIES WITHIN CONSTRUCTION AREA; REPAIR DAMAGE TO UTILITIES THAT OCCUR AS A RESULT OF OPERATIONS OF THIS WORK.

LANDSCAPING: PROTECT LANDSCAPE WORK AND MATERIALS FROM DAMAGE DUE TO LANDSCAPE OPERATIONS, OPERATIONS BY OTHER CONTRACTORS AND TRADES AND TRESPASSERS. MAINTAIN PROTECTION DURING INSTALLATION AND MAINTENANCE PERIODS. TREAT, REPAIR OR REPLACE DAMAGED LANDSCAPE WORK AS DIRECTED AT NO ADDITIONAL COST TO CONTRACT.

ADVERSE CONDITIONS: WHEN CONDITIONS DETRIMENTAL TO SOD OR PLANT GROWTH ARE ENCOUNTERED, SUCH AS RUBBLE FILL, ADVERSE DRAINAGE CONDITIONS, OR OBSTRUCTIONS, NOTIFY OWNER'S REPRESENTATIVE BEFORE

PLANTING AND TURF INSTALLATION SEASONS AND CONDITIONS

NO WORK SHALL BE DONE WHEN GROUND IS FROZEN, SNOW COVERED, TOO WET OR IN AN OTHERWISE UNSUITABLE CONDITION FOR AMENDING SOIL, FINISH GRADING OR PLANTING.

SOIL TESTING/SOIL IMPROVEMENT:

SEE SPECIFICATIONS 32 90 00, SECTION 3.2 SOIL TESTING AND SECTION 3.3 PREPARATION.

SOIL PERCOLATION


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AGENCY APPROVAL:



3186-070-000

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LANDSCAPE ARCHITECTURE AND PLANNING 2707 K Street, Suite 201 Sacramento, CA 95816 916 369-3990

Peter D. Larimer

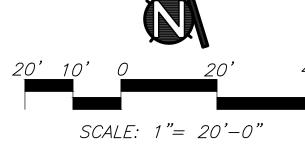DATE

SHEET NAME:

MATSUYAMA ELEMENTARY SCHOOL 7680 WINDBRIDGE DR. **SACRMANETO, CA 95831**

MATSUYAMA ELEMENTARY SCHOOL MODERNIZATION

SHRUB/TURF PLANTING PLAN

DSA SUBMITTAL

DATE: 01/04/2024 CLIENT PROJ NO: 3186-070-000

WINDBRIDGE DR.

LANDSCAPE LEGEND TREE OUTLINE FOR REFERENCE $\odot \odot \odot \odot$ SHRUBS 3" DEPTH BARK MULCH LAWN (SOD) SHRUBS/GROUNDCOVER **DECOMPOSED GRANITE** CONCRETE MOWSTRIP REDWOOD HEADERBOARD -PLANT KEY EXISTING TREES TO REMAIN

PLANT MATERIAL LIST

SIZE	QTY.	KEY	BOTANICAL NAME COMMON NAME	
			SHRUBS:	
1 G.C.	000000000000000000000000000000000000000	ABE. AGA. ANI. ARC. AZA. BAC. BUL. CAR. CEA. CIS. COP. DIE. ESC. EUO. GRE.L. GRE.N. HYP. LIG. LIR. LOM. LOR. MAH. MUH. NAN. PHO. PIT. RHA.B. RHA.J. ROS. SAL. TEU. VIB. WES. XYL.	ABELIA GRANDIFLORA 'SHERWOODII' GLOSSY ABELIA AGAPANTHUS AFRICANUS LILY-OF-THE-NILE ANIGOZANTHOS FLAVIDUS KANGAROO PAW ARCTOSTAPHYLOS SPECIES MANZANITA AZALEA (WHITE) WHITE DECIDIOUS AZALEA BACCHARIS PILULARIS 'TWIN PEAKS' DWARF COYOTE BRUSH BULBINE FRUTESCENS 'HALLMARK' HALLMARK BULBINE CALLISTEMON VIMINALIS 'LITTLE JOHN' DWARF WEEPING BOTTLEBRUSH CAREX DIVULSA EUROPEAN GREY SEDGE CEANOTHUS 'JOYCE COULTER' CEANOTHUS CISTUS HYBRIDUS WHITE ROCKROSE COPROSMA REPENS MIRROR PLANT COTONEASTER PARNEY! PARNEY COTONEASTER DIETES VEGETA FORTNIGHT LILY ESCALLONIA RUBRA 'NEWPORT DWARF' DWARF ESCALLONIA EUONYMUS MICROPHYLLA 'VARIEGATA' VARIEGATED EUONYMUS GREVILLEA NOELI! GREVILLEA HYPERICUM MOSERANUM GOLD FLOWER LIGUSTRUM JAPONICUM 'TEXANUM' WAX-LEAF PRIVET LIRIOPE MUSCAR! LILY TURF LOMANDRA 'PLATINUM BEAUTY' PLATINUM BEAUTY LOMANDRA LOROPETALUM CHINENSE 'RUBRUM' CHINESE FRINGE FLOWER MAHONIA 'SOFT CARESS' SOFT CARESS OREGON GRAPE MUHLENBERGIA RIGENS DEER GRASS NANDINA DOMESTICA 'HARBOR DWARF' DWARF HEAVENLY BAMBOO PHOTINIA FRASER! PHOTINIA PITTOSPORUM TOBIRA 'WHEELER'S DWARF' DWARF PITTOSPORUM RHAPHIOLEPIS INDICA 'BALLERINA' DWARF INDIA HAWTHORN RHAPHIOLEPIS INDICA 'BALLERINA' DWARF INDIA HAWTHORN RHAPHIOLEPIS INDICA 'BALLERINA' DWARF INDIA HAWTHORN RHAPHIOLEPIS INDICA 'JACK EVANS' PINK INDIA HAWTHORN RHAPHIOLEPIS INDICA 'JACK EVANS' PINK INDIA HAWTHORN ROSMARINUS 'TUSCAN BLUE' TUSCAN BLUE ROSEMARY SALVIA MICROPHYLLA 'HOT LIPS' HOT LIPS SAGE TEUCRIUM CHAMAEDRYS GERMANDER VIBURNUM DAVIDII DAVID'S VIBURNUM	
			GROUNDCOVER:	
1 G.C. 1 G.C. FLATS 1 G.C.	48" O.C. 60" O.C. 9" O.C. 48" O.C. 48" O.C. 36" O.C. 24" O.C. 36" O.C. 36" O.C.	ARC.E. COT.H. GAZ. JUN.S. LAN. MYO. ROS. SCA. TRA.A. TRA.J. VIN.	ARCTOSTAPHYLOS 'EMERALD CARPET' MANZANITA COTONEASTER HORIZONTALIS ROCK COTONEASTER GAZANIA 'MITSUWA YELLOW' TRAILING GAZANIA JUNIPERUS SABINA 'BUFFALO' JUNIPER LANTANA 'GOLD RUSH' YELLOW LANTANA MYOPORUM PARVIFOLIUM MYOPORUM ROSMARINUS 'PROSTRATUS' DWARF ROSEMARY SCAEVOLA 'MAUVE CLUSTERS' FAN FLOWER TRACHELOSPERMUM ASIATICUM ASIAN JASMINE TRACHELOSPERMUM JASMINOIDES STAR JASMINE VINCA MINOR DWARF PERIWINKLE	LOW

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ENVIRONMENTAL REQUIREMENTS:

GENERAL: PROCEED WITH WORK IN ORDERLY AND TIMELY MANNER TO COMPLETE INSTALLATION OF LANDSCAPING WITHIN CONTRACT LIMITS.

PROTECTION:

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SOIL TESTING/SOIL IMPROVEMENT:

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SOIL PERCOLATION


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AGENCY APPROVAL:

HMC Architects 3186-070-000 2101 CAPITOL AVENUE, SUITE 100, SACRAMENTO, CA, 95816 916 368 7990 / www.hmcarchitects.com DATE



2707 K Street, Suite 201 Sacramento, CA 95816 Peter D. Larimer

MATSUYAMA ELEMENTARY SCHOOL **7680 WINDBRIDGE DR. SACRMANETO, CA 95831**

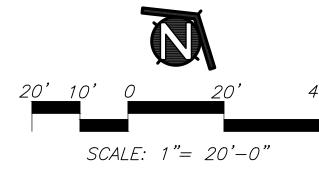MATSUYAMA ELEMENTARY SCHOOL MODERNIZATION

SHEET NAME: SHRUB/TURF PLANTING PLAN

DATE: 01/04/2024 CLIENT PROJ NO: 3186-070-000

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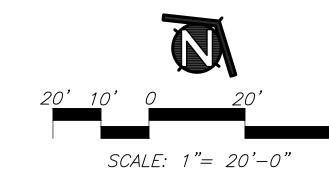
	KEY	SPRINKLER IRRIGATION LEGEND	
•		NEW AUTOMATIC CONTROLLER: HUNTER ACC2 - 42 STATION CONTROLLER MODEL#: A2C-1200-PED-SS WITH (5) A2M-600, A2C-LAN, ROAMXL-KIT. CONTROLLER TO BE ASSEMBLED IN STAINLESS STEEL PEDESTAL ENCLOSURE WITH ETHERNET MODEM, ROAM SMART PORT, AND ROAMXL TRANSMITTER, RECEIVER, AND CARRYING CASE.	
		AND GROUNDING ROD/PLATE TO BE INSTALLED AS PER THE GROUNDING DETAIL. COORDINATE 110V SERVICE AND POWER CONNECTION WITH ELECTRICAL SUB-CONTRACTOR. COORDINATE ETHERNET CONNECTION WITH THE ELECTRICAL SUB-CONTRACTOR.	
	•	POINT OF CONNECTION: IRRIGATION SYSTEM OPERATING WATER PRESSURE: 70 PSI MAXIMUM FLOW IS 200 GPM CONTRACTOR SHALL LOCATE IRRIGATION MAINLINE AS SHOWN ON PLANS. CONNECT AT THIS POINT AND EXTEND AS INDICATED ON DRAWINGS.	
	\boxtimes	NEW BOOSTER PUMP: BOOSTER PUMP SHALL BE BY: V-POWER EQUIPMENT, MODEL # 110MTW12192023-1-7.5VFD-208-3. CONTACT CHRIS MURRAY AT 916-266-6743.	•
		INLET PRESSURE: 28 PSI OUTLET PRESSURE: 80 PSI MIN/MAX WATER DEMAND: 30GPM/110GPM POWER INPUT: 280V, 3 PHASE	
	×	GATE VALVE: TYPE: LEEMCO LMV-XXBB BELL WITH A NON-RISING STEM AND OPERATING NUT. GATE VALVE INSTALLLED IN A VALVE BOX WITH TOP OF BOX SET FLUSH TO FINISH GRADE. GATE VALVE TO BE LINE SIZE.	
		EXISTING PRESSURE MAIN LINE:	
	· · — · · —	PRESSURE MAIN LINE: TYPE: ASTM D1785, PVC SCHEDULE 40. TRENCH DEPTH: IN PLANTED AREAS: 24" MINIMUM COVER. UNDER PAVED AREAS: 24" MINIMUM COVER. PVC SCHEDULE 40 SLEEVES ARE REQUIRED FOR ALL PIPING UNDER PAVEMENT.	
		LATERAL LINE: TYPE: ASTM D1785, PVC SCHEDULE 40, SOLVENT WELD ALL UNSIZED PIPE SHALL BE 3/4" SIZE. TRENCH DEPTH: IN PLANTED AREAS: POP-UP SPRAY HEADS - 12" MINIMUM COVER. ROTOR HEADS: - 18" MINIMUM COVER. BUBBLER HEADS: - 12" MINIMUM COVER. UNDER PAVED AREAS: 24" MINIMUM COVER. PVC SCHEDULE 40 SLEEVES ARE REQUIRED FOR ALL PIPING UNDER PAVEMENT.	
	•`	AUTOMATIC CONTROL VALVE: RAINBIRD PEB-PRS-D SERIES, TORO P220-27 SERIES, HUNTER ICV-AS OR	
	◆	APPROVED EQUAL. VALVE SHALL HAVE PRESSURE REGULATION OPTION. QUICK COUPLER VALVE: RAINBIRD 44NP, TORO 100-2SLLVC, HUNTER HQ-44-LRC-R OR APPROVED EQUAL. VALVES SHALL HAVE LOCKING RUBBER COVERS, INSTALLED IN VALVE BOXES. TOP OF VALVE BOX SHALL HAVE BOLT DOWN LID AND TOP SET LEVEL TO FINISH GRADE.	

IRRIGATION WIRE SPLICE BOX:

KEY	SPRINKLER IRRIGATION LEGEND
◆←	LAWN POP-UP ROTOR HEADS: FULL CIRCLE HUNTER: I-40-04-SS-15 THREE QUARTER HUNTER: I-40-04-SS-15 HALF CIRCLE HUNTER: I-40-04-SS-15 QUARTER CIRCLE HUNTER: I-40-04-SS-15
	LAWN POP-UP SPRAY HEADS: HUNTER: I-20-04-SS-2.0 HALF AND QUARTER SPRAY PATTERNS.
• •	LAWN POP-UP SPRAY HEADS: HUNTER: PROS-06-PRS40-CV WITH HUNTER MP2000 SERIES NOZZLES. (40 PSI REGULATION) HALF, AND QUARTER SPRAY PATTERNS.
•	SHRUB BUBBLER: HUNTER HEB-20 EMITTER WITH SCREEN CV.
	AUTOMATIC DRIP IRRIGATION VALVE/FILTER/PRESSURE REGULATOR: RAINBIRD CONTROL ZONE KIT MODEL XCZ-100-PRB-COM.
A1 2" 0.00	INDICATES CONTROL VALVE AND STATION NUMBER INDICATES GALLONS PER MINUTE EXISTING TREE PROTECTION AREA: THE PROTECTION AREA UNDER ANY EXISTING TREE THAT IS TO REMAIN IS DEFINED BY ITS DRIP LINE OR CANOPY COVER. WITHIN THIS AREA NO STORAGE OR PARKING WILL BE PERFORMED BY HAND. DO NOT CUT ROOTS 1" IN DIAMETER OR LARGER. USE BORING PROCEDURES WHEN ENCOUNTERING ROOTS 1" SIZE AND LARGER. NO ROOTS ARE TO BE EXPOSED LONGER THAN 48 HOURS.


SPRINKLER IRRIGATION NOTES

- 1. COMPOSITE BASE SHEET: PROPOSED IMPROVEMENTS SHOWN ON DRAWINGS ARE SUPERIMPOSED ON A COMPOSITE BASE SHEET. THE COMPOSITE BASE SHEET IS A COMPILATION OF ARCHITECTURAL, ENGINEERING, AND OTHER DATA THAT IS PROVIDED. THE LANDSCAPE ARCHITECT SHALL NOT BE HELD LIABLE FOR CHANGES, INACCURACIES, OMISSIONS, OR ERRORS PERTAINING TO THE COMPOSITE BASE SHEET. CONTRACTOR SHALL BE RESPONSIBLE FOR REVIEWING THESE DOCUMENTS. ANY DISCREPANCIES NEED TO BE BROUGHT TO THE ATTENTION OF THE DESIGN TEAM AND RESOLVED PRIOR TO CONTINUATION OF WORK.
- 2. DESIGN PRESSURE SHOWN ON PLANS HAS BEEN FURNISHED BY WATER COMPANY OR WATER DISTRICT SERVING SITE. VERIFY PRESSURE ON-SITE PRIOR TO THE INSTALLATION OF ANY SPRINKLER IRRIGATION EQUIPMENT. IF THERE IS A DISCREPANCY, NOTIFY OWNER'S REPRESENTATIVE IMMEDIATELY IN WRITING SO ADJUSTMENTS CAN BE MADE BY LANDSCAPE ARCHITECT. FAILURE TO REPORT DISCREPANCIES AND CONTINUANCE OF WORK WILL RESULT IN ALL RE-DESIGN COSTS BEING CHARGED TO CONTRACTOR.
- 3. DETERMINE LOCATION OF UNDERGROUND UTILITIES. DAMAGE CAUSED BY INSTALLATION OF THIS WORK SHALL BE REPAIRED TO SATISFACTION OF GOVERNING AGENCY OR OWNER AT NO ADDITIONAL COST TO THE CONTRACT.
- 4. SPRINKLER OVER SPRAY SHALL NOT BE ALLOWED ON PUBLIC SIDEWALKS, BUILDING WALLS OR FENCES. MINIMUM OVERSPRAY MAY OCCUR IN PARKING AREAS. USE ADJUSTABLE NOZZLES WHENEVER POSSIBLE TO CONTROL SPRINKLER OVERSPRAY.
- 5. ALL LOCAL CODES AND ORDINANCES SHALL BE COMPLIED WITH. IF THERE IS A CONFLICT, NOTIFY OWNER'S REPRESENTATIVE
- 6. TESTING:
- A. PRESSURE TEST ALL UNDERGROUND PIPING AS FOLLOWS: SYSTEMS WITH BOOSTER PUMP: MAIN LINE - AT 100 PSI FOR 4 HOURS.
 - LATERAL LINES AT 100 PSI FOR 2 HOURS. SYSTEMS WITH OUT BOOSTER PUMP:
 - MAIN LINE AT STATIC PSI FOR 4 HOURS. LATERAL LINES - AT STATIC PSI FOR 2 HOURS.
- B. COVERAGE TEST: NOTE: PRIOR TO REQUESTING COVERAGE TEST, INSURE ALL HEADS ARE SET PLUMB, NOZZLES ARE ADJUSTED PROPERLY AND SYSTEM HAS BEEN CHECKED FOR AUTOMATION. REQUEST OWNER'S REPRESENTATIVES PRESENCE ON-SITE WHEN SPRINKLER SYSTEM IS COMPLETELY INSTALLED AND FULLY AUTOMATIC. PROVIDE ADEQUATE PERSONNEL AT THIS MEETING TO ADJUST AND FINE TUNE SYSTEM TO SATISFACTION OF OWNER'S REPRESENTATIVE.
- 7. LAYOUT ALL WORK PRIOR TO TRENCHING OPERATIONS TO DETERMINE IF MINOR MODIFICATIONS OR ADJUSTMENTS WILL BE REQUIRED.
- 8. INSTALL ALL SPRINKLER HEADS PERPENDICULAR TO SLOPES OR GRADE. 9. CONTROL WIRE SHALL BE UF-14, COLOR FOR LEAD AND WHITE FOR COMMON. SPLICES SHALL BE PERMITTED AT VALVE BOX LOCATIONS
- 10. PROVIDE AND INSTALL AUTOMATIC CONTROLLER AND UF-14 CONTROL WIRE. ELECTRICAL SUBCONTRACTOR SHALL PROVIDE 110V
- SERVICE AND SERVICE HOOKUP FROM POWER SOURCE TO AUTOMATIC CONTROLLER.
- 11. COORDINATE ALL WORK WITH OTHER TRADES SO PROGRESS OF WORK IS NOT INTERRUPTED AND CAN BE COMPLETED IN A TIMELY
- 12. NO PLANTING SHALL BE STARTED UNTIL ALL SPRINKLER WORK HAS BEEN TESTED AND APPROVED IN PRESENCE OF OWNER'S
- 13. FOR SPRINKLER IRRIGATION INSTALLATION DETAILS, SEE SHEET NO. L4.2 AND L4.3.



AGENCY APPROVAL:



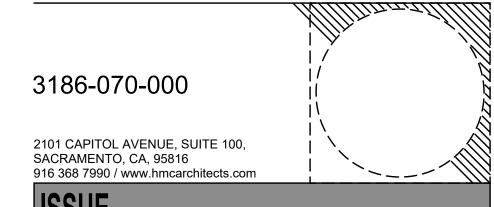

 Δ **DESCRIPTION**

LANDSCAPE ARCHITECTURE AND PLANNING 2707 K Street, Suite 201 Sacramento, CA 95816 916 369-3990 Peter D. Larimer

DATE


MATSUYAMA ELEMENTARY SCHOOL 7680 WINDBRIDGE DR. SACRMANETO, CA 95831

MATSUYAMA ELEMENTARY SCHOOL MODERNIZATION

LANDSCAPE IRRIGATION PLAN

DSA SUBMITTAL

CLIENT PROJ NO: 3186-070-000 DATE: 01/04/2024

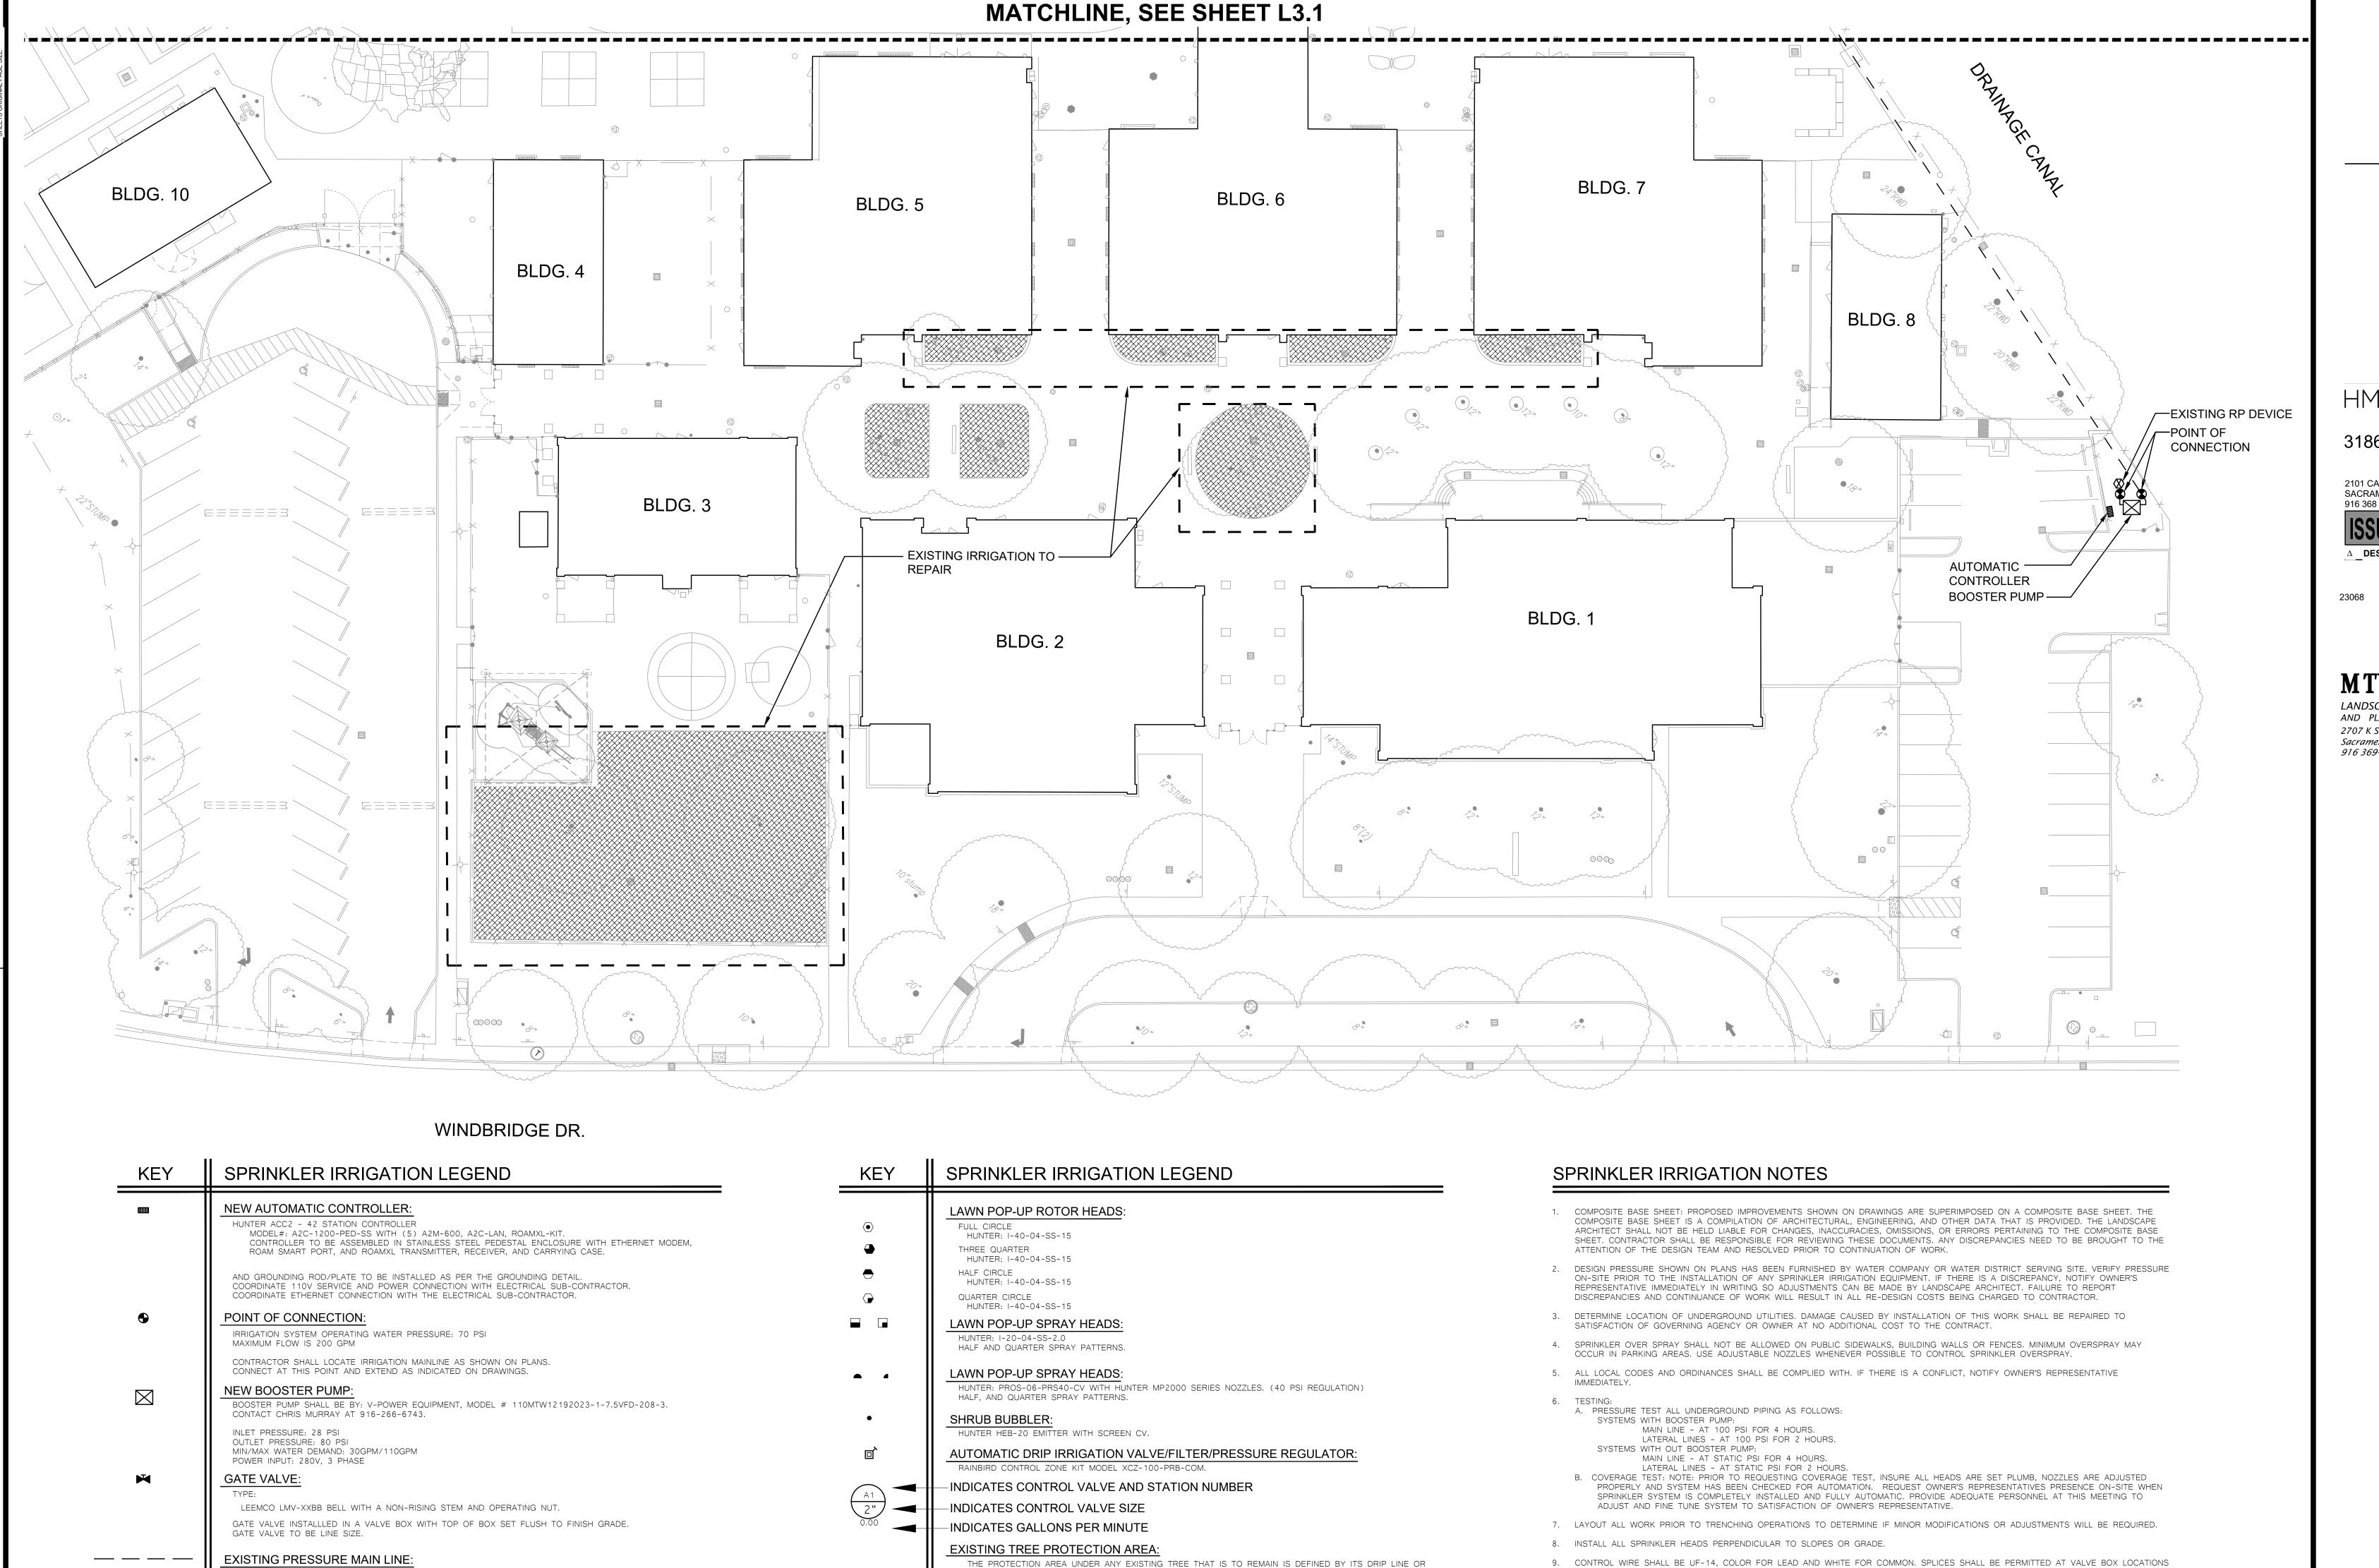

CANOPY COVER. WITHIN THIS AREA NO STORAGE OR PARKING WILL BE PERMITTED. ALL TRENCHING WILL BE PERFORMED BY HAND. DO NOT CUT ROOTS 1" IN DIAMETER OR LARGER. USE BORING PROCEDURES WHEN

ENCOUNTERING ROOTS 1" SIZE AND LARGER. NO ROOTS ARE TO BE EXPOSED LONGER THAN 48 HOURS.

__ · · · __ · · __

ASTM D1785, PVC SCHEDULE 40.

LATERAL LINE:

TRENCH DEPTH: IN PLANTED AREAS:

QUICK COUPLER VALVE:

IRRIGATION WIRE SPLICE BOX:

IN PLANTED AREAS: 24" MINIMUM COVER. UNDER PAVED AREAS: 24" MINIMUM COVER.

POP-UP SPRAY HEADS - 12" MINIMUM COVER. ROTOR HEADS: - 18" MINIMUM COVER.

BUBBLER HEADS: - 12" MINIMUM COVER. UNDER PAVED AREAS: 24" MINIMUM COVER.

PVC SCHEDULE 40 SLEEVES ARE REQUIRED FOR ALL PIPING UNDER PAVEMENT.

PVC SCHEDULE 40 SLEEVES ARE REQUIRED FOR ALL PIPING UNDER PAVEMENT.

RAINBIRD 44NP, TORO 100-2SLLVC, HUNTER HQ-44-LRC-R OR APPROVED EQUAL. VALVES SHALL HAVE LOCKING RUBBER COVERS, INSTALLED IN VALVE BOXES. TOP OF

VALVE BOX SHALL HAVE BOLT DOWN LID AND TOP SET LEVEL TO FINISH GRADE.

RAINBIRD PEB-PRS-D SERIES, TORO P220-27 SERIES, HUNTER ICV-AS OR

APPROVED EQUAL. VALVE SHALL HAVE PRESSURE REGULATION OPTION.

ASTM D1785, PVC SCHEDULE 40, SOLVENT WELD ALL UNSIZED PIPE SHALL BE 3/4" SIZE.

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HMC Architects 3186-070-000 2101 CAPITOL AVENUE, SUITE 100, SACRAMENTO, CA, 95816 916 368 7990 / www.hmcarchitects.com DATE △ **DESCRIPTION**

MTWgroup LANDSCAPE ARCHITECTURE AND PLANNING

2707 K Street, Suite 201 Sacramento, CA 95816 Peter D. Larimer

MATSUYAMA ELEMENTARY SCHOOL 7680 WINDBRIDGE DR. SACRMANETO, CA 95831

MATSUYAMA ELEMENTARY SCHOOL MODERNIZATION

SHEET NAME: LANDSCAPE IRRIGATION PLAN

DSA SUBMITTAL

CLIENT PROJ NO: 3186-070-000 DATE: 01/04/2024

SCALE: 1"= 20'-0"


10. PROVIDE AND INSTALL AUTOMATIC CONTROLLER AND UF-14 CONTROL WIRE. ELECTRICAL SUBCONTRACTOR SHALL PROVIDE 110V

12. NO PLANTING SHALL BE STARTED UNTIL ALL SPRINKLER WORK HAS BEEN TESTED AND APPROVED IN PRESENCE OF OWNER'S

11. COORDINATE ALL WORK WITH OTHER TRADES SO PROGRESS OF WORK IS NOT INTERRUPTED AND CAN BE COMPLETED IN A TIMELY

SERVICE AND SERVICE HOOKUP FROM POWER SOURCE TO AUTOMATIC CONTROLLER.

13. FOR SPRINKLER IRRIGATION INSTALLATION DETAILS, SEE SHEET NO. L4.2 AND L4.3.

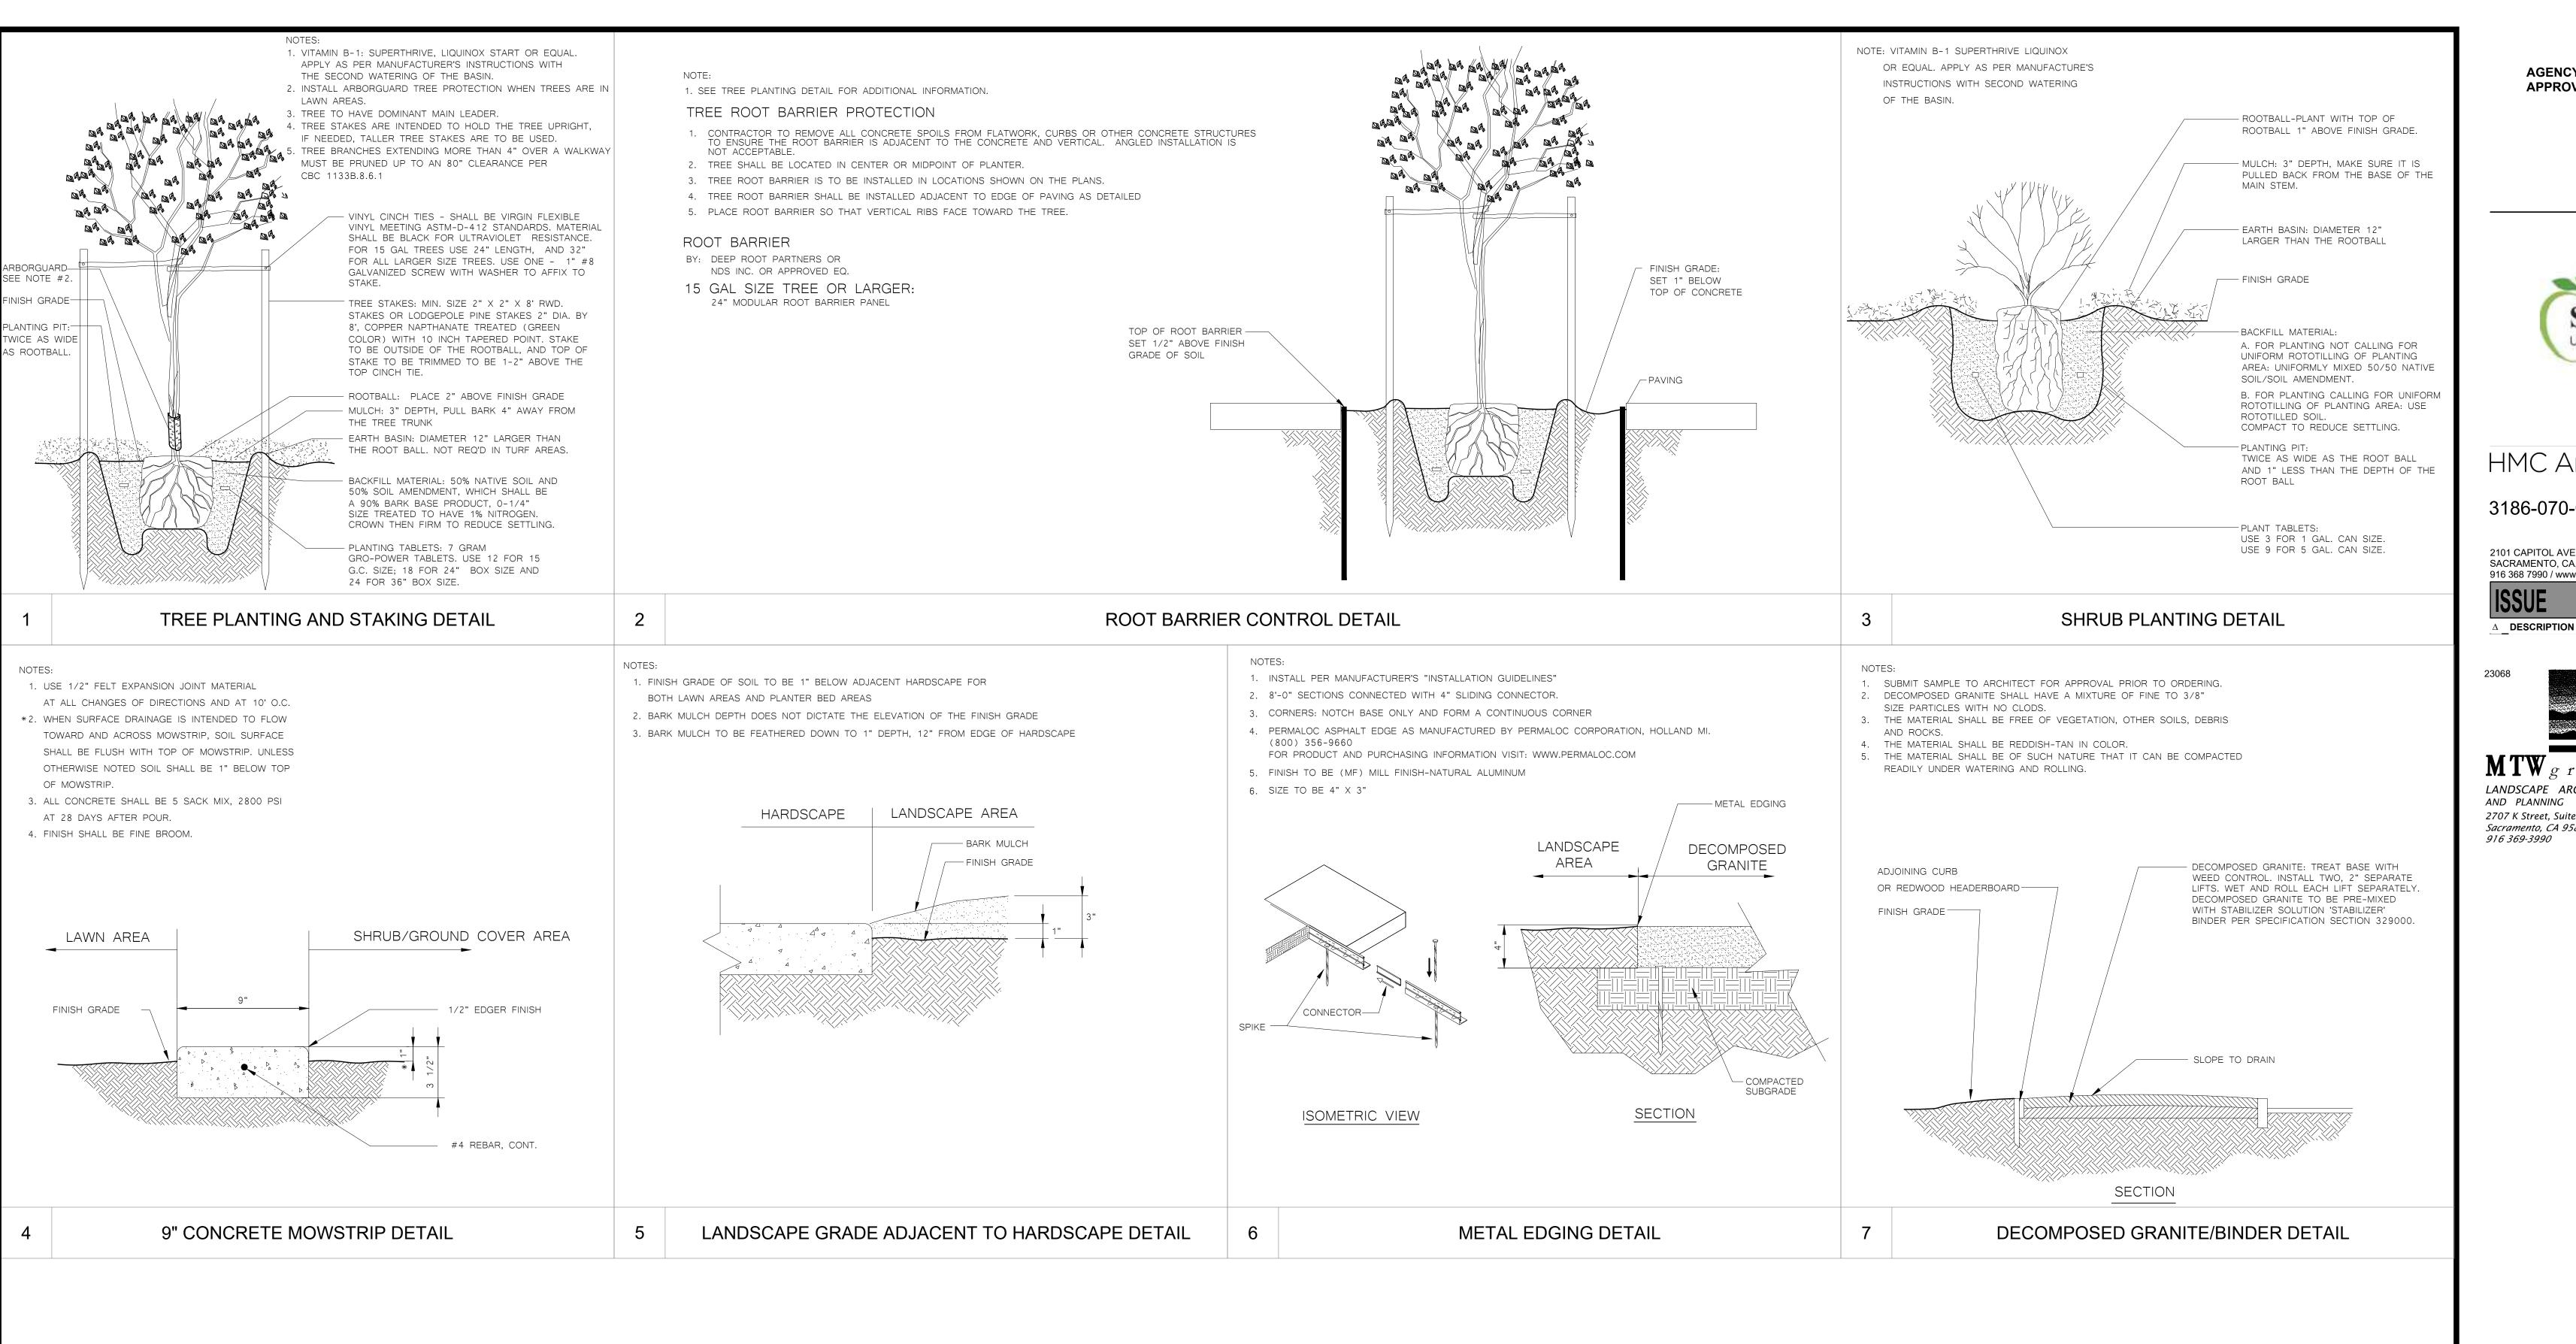

AGENCY APPROVAL:

UNIFIED SCHOOL DISTRICT

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LANDSCAPE ARCHITECTURE AND PLANNING 2707 K Street, Suite 201 Sacramento, CA 95816 916 369-3990


Peter D. Larimer

MATSUYAMA ELEMENTARY SCHOOL **7680 WINDBRIDGE DR.** SACRMANETO, CA 95831


MATSUYAMA ELEMENTARY SCHOOL MODERNIZATION


LANDSCAPE PLANTING DETAIL

DSA SUBMITTAL CLIENT PROJ NO: 3186-070-000 DATE: **01/04/2024**

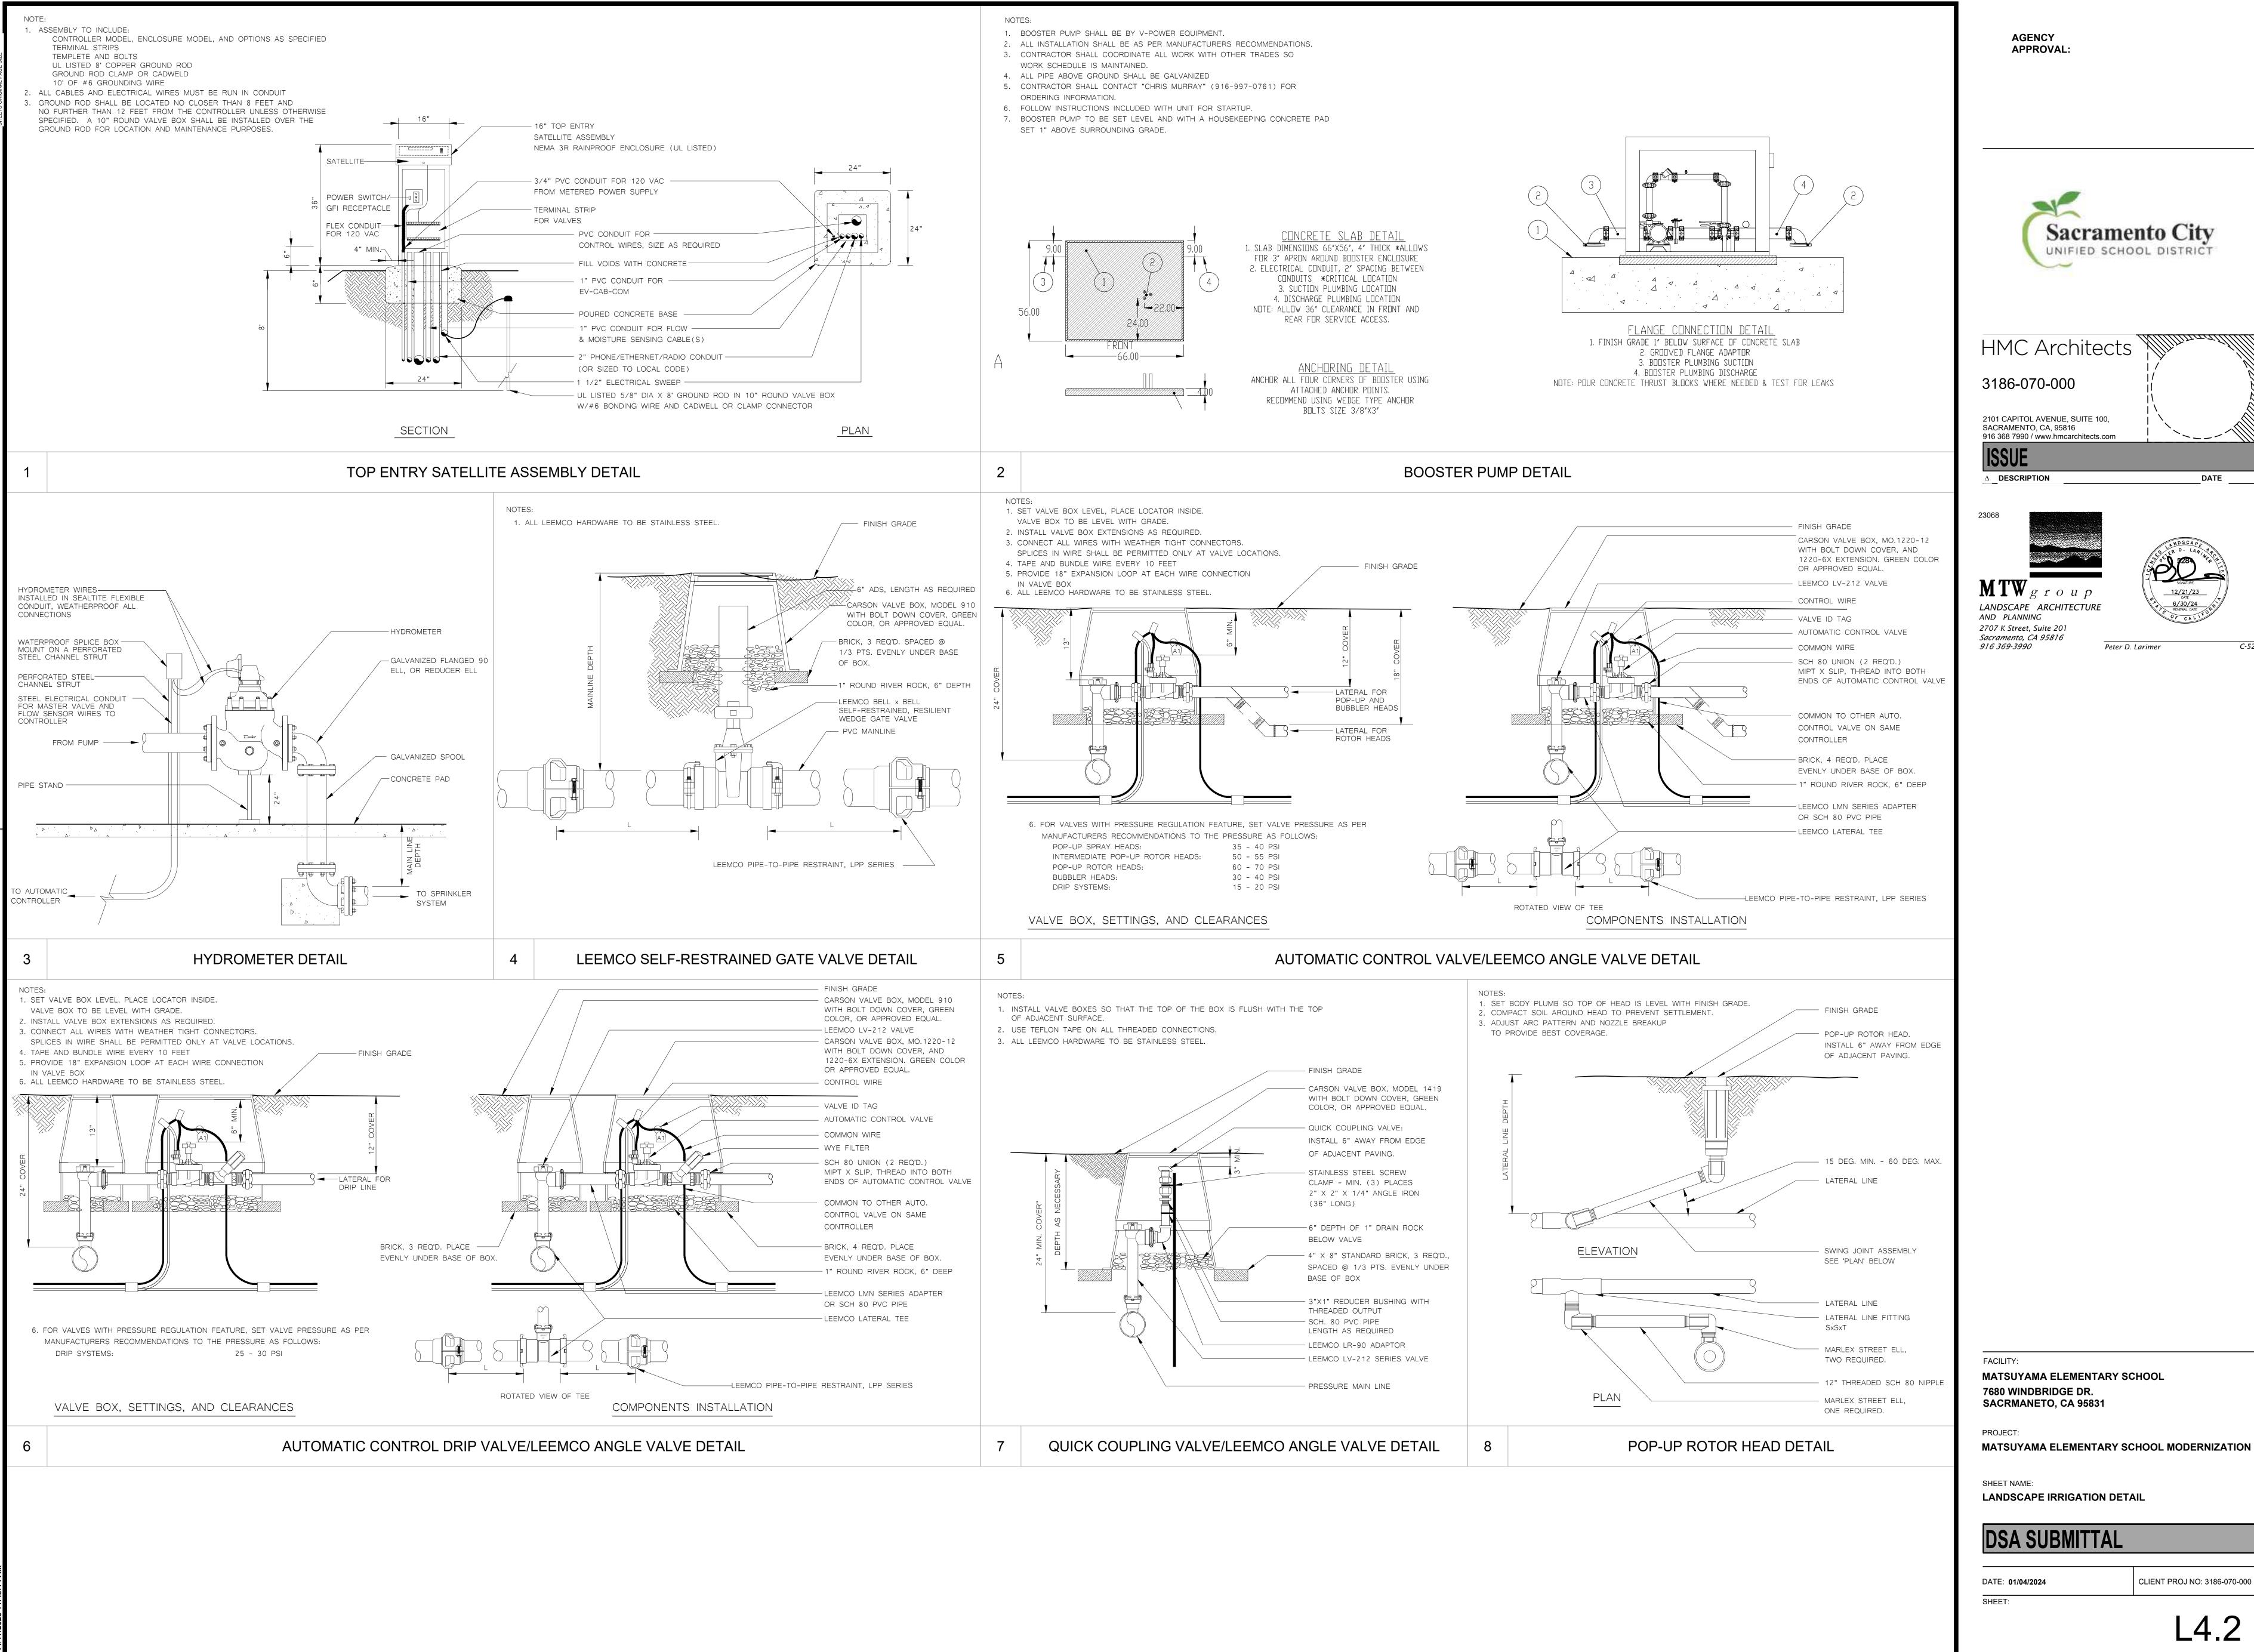




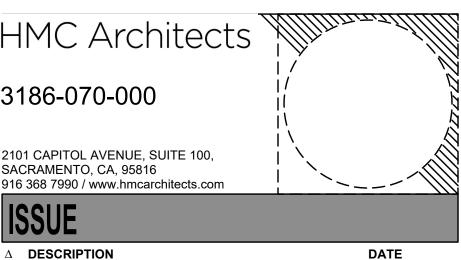


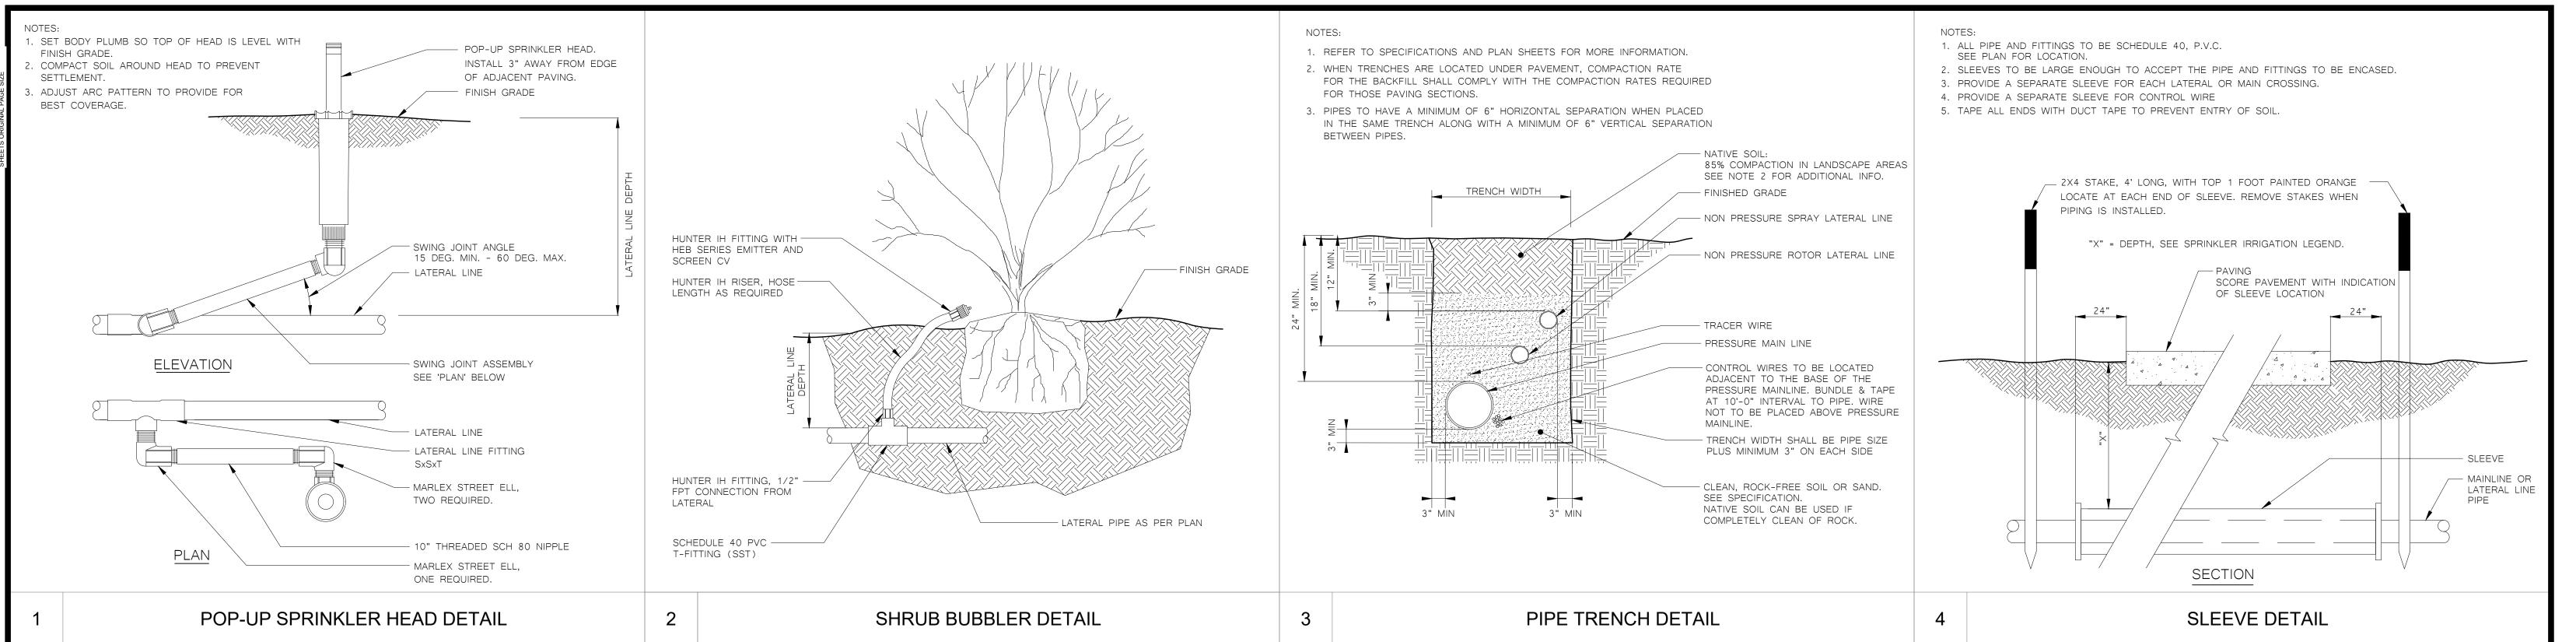

AGENCY APPROVAL:

Sacramento City

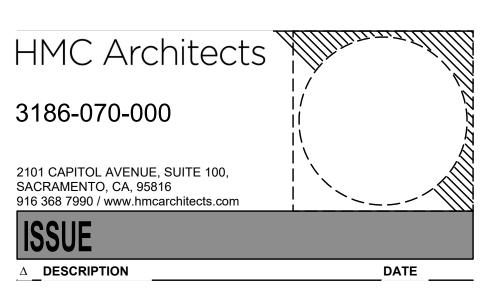

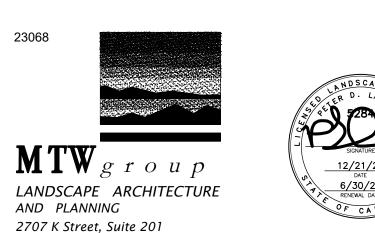

Sacramento, CA 95816

916 369-3990

Peter D. Larimer

Peter D. Larimer

FACILITY

MATSUYAMA ELEMENTARY SCHOOL 7680 WINDBRIDGE DR. SACRMANETO, CA 95831

OJECT:

MATSUYAMA ELEMENTARY SCHOOL MODERNIZATION

SHEET NAME:

LANDSCAPE IRRIGATION DETAIL

DSA SUBMITTAL

DATE: 01/04/2024 CLIENT PROJ NO: 3186-070-000

143


IRRIGATION HYDROZONE INFORMATION TABLE

STATION #/HYDROZONE	PLANT WATER USE TYPE	PLANT FACTOR (PF)	HYDROZONE AREA (HA) (SQ.FT.)	PF x HA (SQ.FT.)	IRRIGATION EFFICIENCY (IE)	ETWU (GALLONS)
1-9	LAWN - HIGH-SLA	0.8	55,226	44180.8	0.75	1,895,533
10	SHRUB - LOW	0.2	4,368	873.6	0.81	34,705
		TOTAL AREA	59,594		ETWU TOTAL	1,930,238
		TOTAL AREA (SLA)	55,226			
Eto (Sacramento)	51.9					
		ESTIMATED TOTAL WATE	ER USAGE (ETWU) = (ETo)(0.62)((PF)(I	HA)/IE+SLA) = GAL/YEAR		
		MAXIMUM APPLIED WATER ALL	OWANCE (MAWA) = (ETo)(0.62)[(0.45	x LA)+(0.55 x SLA)] = GAL/YEAR		
					MAWA TOTAL	1,840,311

Plant Water Use Type	Plant Factor
Very Low	0 - 0.1
Low	0.2 - 0.3
Medium	0.4 - 0.6
High	0.7 - 1.0
SLA	1.0
Irrigation Efficiency	IE
Overhead	0.75
Drip	0.81

AGENCY APPROVAL:



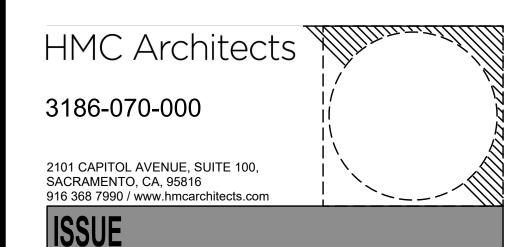

Δ DESCRIPTION

LANDSCAPE ARCHITECTURE
AND PLANNING
2707 K Street, Suite 201
Sacramento, CA 95816
916 369-3990
Pe

Peter D. Larimer

DATE

MATSUYAMA ELEMENTARY SCHOOL 7680 WINDBRIDGE DR. SACRMANETO, CA 95831

MATSUYAMA ELEMENTARY SCHOOL MODERNIZATION

DATE: 01/04/2024

IRRIGATION CHARTS AND SHADING CALCULATION

DSA SUBMITTAL CLIENT PROJ NO: 3186-070-000

LEGEND APPROXIMATE LIMIT OF WORK.
REFER TO ADDITIONAL DRAWINGS
FOR WORK WHICH MAY EXTEND
BEYOND THIS APPROXIMATE LIMIT OF WORK LINE. PROPERTY LINE **EXISTING BUILDINGS** 02.05 (E) BLDG. 8 (E) BLDG. 7 02.18 02.72 (E) BLDG. 6 (E) BLDG. 1 (E) BLDG. 5 (E) BLDG. 4 (E) BLDG. 2 (E) BLDG. 3 √(E) BLDG. 10 ARCHITECTURAL DEMOLITION SITE PLAN PLEASE RECYCLE

AGENCY APPROVAL:

Sacramento City

HMC Architects

3186-070-000

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ISSUE

Δ **DESCRIPTION**

KEYNOTES

(E) ASPHALTIC CONCRETE PAVING TO REMAIN; PROTECT IN PLACE REMOVE (E) CONCRETE CURB

(E) BALL WALL TO REMAIN; PROTECT IN PLACE REMOVE (E) PLANTERS

REMOVE PORTION OF (E) ASPHALTIC CONCRETE PAVEMENT

DATE

REMOVE AND REINSTALL (E) RAMP PER CODE AFTER HARD COURT COMPLETION. APPLY NEW COATING ON

REMOVE (E) SOCCER GOAL POST REMOVE (E) CHAIN LINK BACKSTOP

REMOVE (E) PLAYGROUND APPARATUS REMOVE (E) TREE

REMOVE PORTION OF (E) CONCRETE PAVEMENT | SEE

REMOVE (E) ASPHALT HARDCOURT

REMOVE (E) ASPHALT PAVEMENT REMOVE (E) BASKETBALL HOOP & FOOTING

REMOVE (E) PLAYGROUND POST & FOOTING

(E) FIRE HYDRANT

MATSUYAMA ELEMENTARY SCHOOL 7680 WINDBRIDGE DRIVE SACRAMENTO, CA 95831

MATSUYAMA ELEMENTARY SCHOOL MODERNIZATION

SHEET NAME: SITE DEMOLITION PLAN

DSA SUBMITTAL

DATE: 01/04/2024

LEGEND APPROXIMATE LIMIT OF WORK. REFER TO ADDITIONAL DRAWINGS FOR WORK WHICH MAY EXTEND BEYOND THIS APPROXIMATE LIMIT OF WORK LINE. — - — - — MATCH LINE EXISTING BUILDING CONCRETE PAVEMENT ASPHALT BARK AND PLANTING, SEE LANDSCAPE DWGS GRASS, SEE LANDSCAPE DWGS DECOMPOSED GRANITE, SEE LANDSCAPE DWGS SYNTHETIC RUBBERIZED RUNNING TRACK, SEE CIVIL BARD UNIT TO BE REPLACED, SEE MECHANICAL AND ELECTRICAL DWGS FOR FULL SCOPE -× × CHAIN LINK FENCE ___ DECORATIVE METAL FENCE (E) BLDG. 9 (E) BLDG. 11 (E) BLDG. 8 (E) BLDG. 6 (E) BLDG. 1 (E) BLDG. 5 (E) BLDG. 4 (E) BLDG. 2 (E) BLDG. 3 DATE: 01/04/2024 ARCHITECTURAL SITE PLAN PLEASE RECYCLE

AGENCY APPROVAL:

UNIFIED SCHOOL DISTRICT

C-25193 REN. 07/31/25

DATE

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△ **DESCRIPTION**

KEYNOTES

21.01 (E) FIRE HYDRANT

NOTES

- 1. REFER TO SHEET G0.11 FOR TYPICAL SYMBOLS AND
- **ABBREVIATIONS** REFER TO LANDSCAPE DRAWINGS FOR PAVING AND
- PLANTING INFORMATION
 REFER TO MECHANICAL, ELECTRICAL, AND PLUMBING
 DRAWINGS FOR UTILITY INFORMATION
 CONTRACTOR IS RESPONSIBLE FOR REPAIR/
- REPLACEMENT OF ALL HARDSCAPE/PLANTING OUTSIDE OF LIMIT OF WORK LINE FOR CONNECTION OF
- UNDERGROUND UTILITIES REFER TO PARTIAL PLANS FOR MORE INFORMATION. OVERALL PLANS ARE INTENDED TO PROVIDE CONTEXT
- FOR PARTIAL PLANS. PAINT ALL (E) DECORATIVE METAL FENCE
- REFER TO SITE DETAIL SHEETS FOR PLAYGROUND STRIPING DIMENSIONS ARCHITECT TO PROVIDE GRAPHICS FOR ALL THE
- PLAYGROUND STRIPINGS RESTRIPE ALL (E) EXTERIOR DOOR OPENINGS THROUGHOUT CAMPUS

MATSUYAMA ELEMENTARY SCHOOL 7680 WINDBRIDGE DRIVE SACRAMENTO, CA 95831

MATSUYAMA ELEMENTARY SCHOOL MODERNIZATION

SHEET NAME: PROJECT SITE PLAN

DSA SUBMITTAL

LEGEND APPROXIMATE LIMIT OF WORK. REFER TO ADDITIONAL DRAWINGS FOR WORK WHICH MAY EXTEND BEYOND THIS APPROXIMATE LIMIT OF WORK LINE. —— - — - — MATCH LINE EXISTING BUILDING CONCRETE PAVEMENT ASPHALT BARK AND PLANTING, SEE LANDSCAPE DWGS GRASS, SEE LANDSCAPE DWGS DECOMPOSED GRANITE, SEE LANDSCAPE DWGS SYNTHETIC RUBBERIZED RUNNING TRACK, SEE CIVIL BARD UNIT TO BE REPLACED, SEE MECHANICAL AND ELECTRICAL DWGS FOR FULL SCOPE 32.24 -× × CHAIN LINK FENCE ___ DECORATIVE METAL FENCE 21.01 32.01 32.02 32.03 (E) BLDG. 9 (E) BLDG. 11 32.14 32.16 ||204'-10"| 32.46 32.47 13'-0" (E) BLDG. 10 (E) BLDG. 5 (E) BLDG. 6 (E) BLDG. 7 1 A1.23 (E) BLDG. 4 (E) BLDG. 8

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△ **DESCRIPTION**

KEYNOTES

02.05 (E) BALL WALL TO REMAIN; PROTECT IN PLACE (E) DRAINAGE INLET, SEE CIVIL DWGS; PROTECT IN REMOVE AND REINSTALL (E) RAMP PER CODE AFTER HARD COURT COMPLETION. APPLY NEW COATING ON

> CONCRETE CURB | SEE CIVIL DWGS CONCRETE MOWSTRIP | SEE LANDSCAPE DWGS 40'X40'X15' SHADE STRUCTURE, PC 04-121917 (E) FIRE HYDRANT PLAYGROUND GAME LINES - USA MAP PLAYGROUND GAME LINES - TETHERBALL PLAYGROUND GAME LINES - FRACTION BALL

PLAYGROUND GAME LINES - TRACK STRIPING PLAYGROUND GAME LINES - PICKLEBALL PLAYGROUND GAME LINES - VOLLEYBALL PLAYGROUND GAME LINES - BUTTERFLY HOPSCOTCH 32.09 PLAYGROUND GAME LINES - CATERPILLAR PLAYGROUND GAME LINES - HOPSCOTCH

PLAYGROUND GAME LINES - FOUR SQUARE PLAYGROUND GAME LINES - SENSORY PATH PRECAST CONCRETE SEAT WALL POURED-IN-PLACE RUBBER, COLOR 1 POURED-IN-PLACE RUBBER, COLOR 2 DECOMPOSED GRANITE, SEE LANDSCAPE DWGS

CHAIN LINK BACKSTOP CONCRETE CONTROL JOINT, TYP ADD HANDRAIL EXTENSION PLAYGROUND GAME LINES - FLOWER PLAYGROUND GAME LINES - MATH TABLE PLAYGROUND GAME LINES - DODGEBALL PLAYGROUND GAME LINES - FUNBALL PLAYGROUND GAME LINES - BALL WALL

PLAYGROUND GAME LINES - MIRROR ME PLAYGROUND GAME LINES - SUNCLOCK GAGA BALL WALLS REPAINT (E) DOOR SWING STRIPING FIX OR REPLACE (E) HOSE BIB

NOTES

REFER TO SHEET G0.11 FOR TYPICAL SYMBOLS AND

REFER TO LANDSCAPE DRAWINGS FOR PAVING AND PLANTING INFORMATION

REFER TO MECHANICAL, ELECTRICAL, AND PLUMBING DRAWINGS FOR UTILITY INFORMATION CONTRACTOR IS RESPONSIBLE FOR REPAIR/

REPLACEMENT OF ALL HARDSCAPE/PLANTING OUTSIDE OF LIMIT OF WORK LINE FOR CONNECTION OF UNDERGROUND UTILITIES

OVERALL PLANS ARE INTENDED TO PROVIDE CONTEXT FOR PARTIAL PLANS. PAINT ALL (E) DECORATIVE METAL FENCE

REFER TO SITE DETAIL SHEETS FOR PLAYGROUND

STRIPING DIMENSIONS ARCHITECT TO PROVIDE GRAPHICS FOR ALL THE

REFER TO PARTIAL PLANS FOR MORE INFORMATION.

PLAYGROUND STRIPINGS RESTRIPE ALL (E) EXTERIOR DOOR OPENINGS

THROUGHOUT CAMPUS

MATSUYAMA ELEMENTARY SCHOOL **7680 WINDBRIDGE DRIVE SACRAMENTO, CA 95831**

MATSUYAMA ELEMENTARY SCHOOL MODERNIZATION


PARTIAL SITE PLAN SEGMENT - 1

DSA SUBMITTAL

DATE: 01/04/2024

CLIENT PROJ NO: 3186-070-000

PARTIAL SITE PLAN SEGMENT - 1

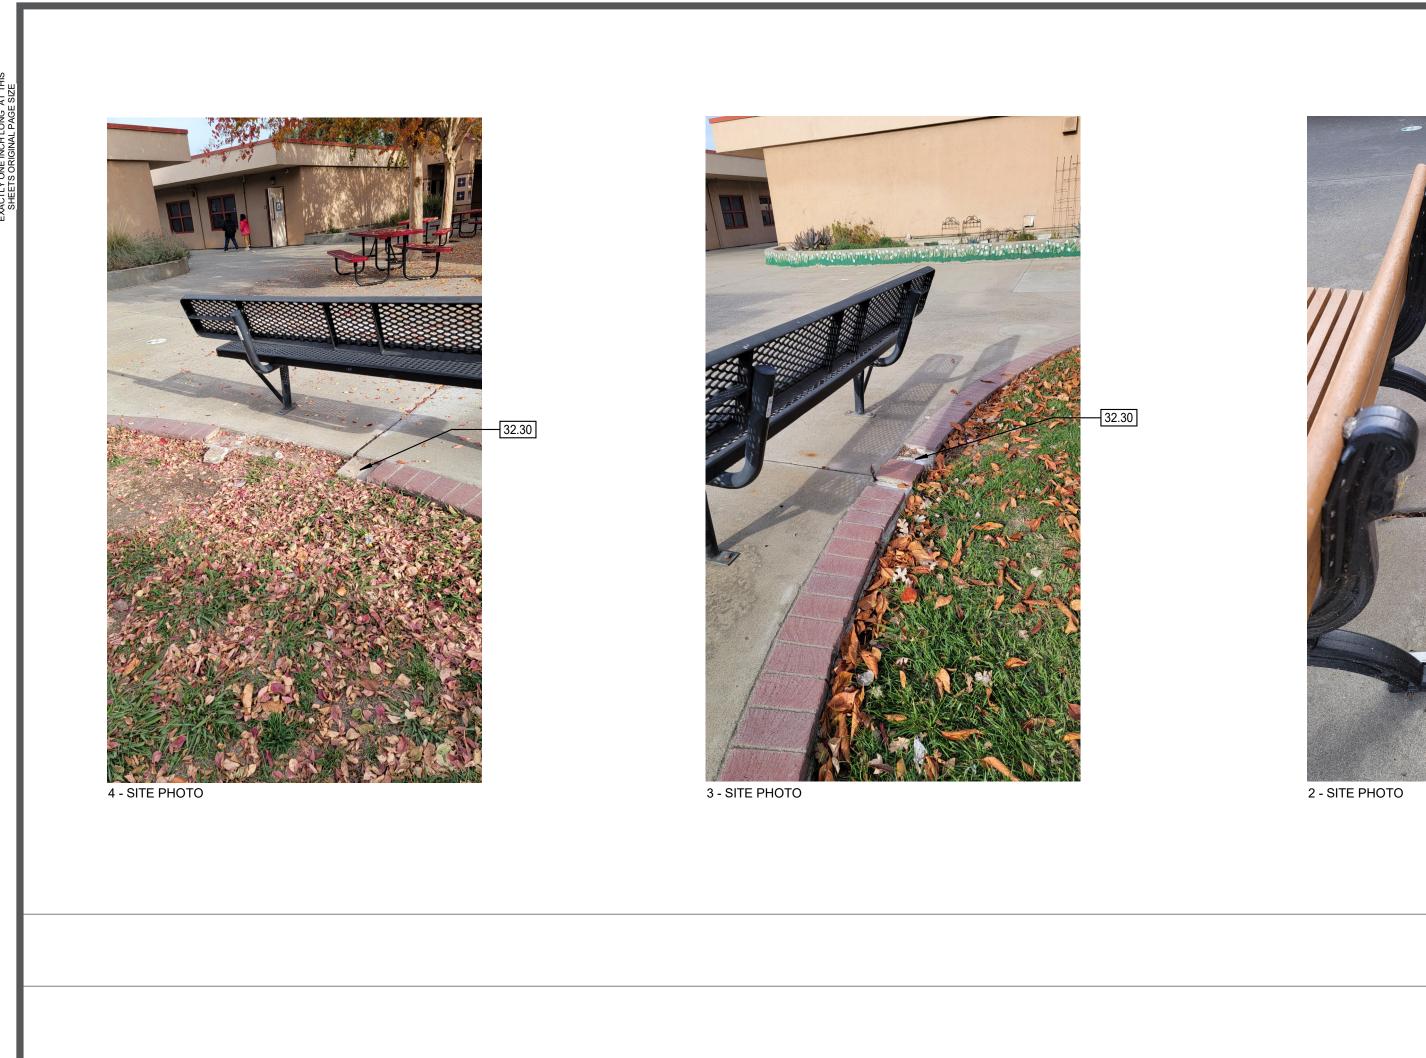


(E) BLDG. 10



32.30 1 - SITE PHOTO

SITE PHOTO 2
3/16" = 1'-0"

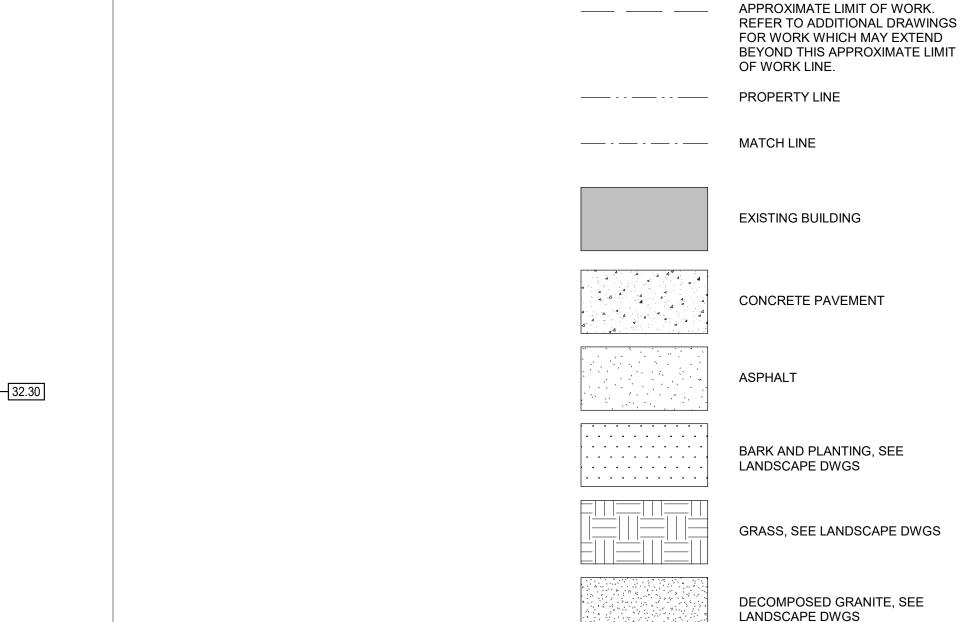

DECOMPOSED GRANITE, SEE
LANDSCAPE DWGS

SYNTHETIC RUBBERIZED
RUNNING TRACK, SEE CIVIL
DWGS

BARD UNIT TO BE REPLACED, SEE
MECHANICAL AND ELECTRICAL DWGS
FOR FULL SCOPE

CHAIN LINK FENCE

DECORATIVE METAL FENCE

LEGEND

AGENCY APPROVAL:



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DATE

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ISSUE

△ DESCRIPTION

02.06 CONCRETE CURB, SEE CIVIL DWGS 02.11 REMOVE AND REINSTALL (E) RAMP PER CODE AFTER HARD COURT COMPLETION. APPLY NEW COATING ON RAMP. 13.12 30'X30'X15' SHADE STRUCTURE, PC 04-121917 21.01 (E) FIRE HYDRANT

KEYNOTES

(E) FIRE HYDRANT
(E) ASPHALTIC CONCRETE PAVING TO BE SEAL COATED AND RE-STRIPED TO MATCH (E) STRIPING
POURED-IN-PLACE RUBBER, COLOR 1
POURED-IN-PLACE RUBBER, COLOR 2
(E) ACCESSIBLE PARKING SIGN

GRASS | SEE LANDSCAPE DWGS
PAINT PLANTER CONCRETE CURB PX OVER THE (E)
PAINT
REPLANT (E) PLANTERS | SEE LANDSCAPE DWGS
CURB RAMP

CONCRETE CONTROL JOINT, TYP
ASPHALTIC CONCRETE | SEE CIVIL DWGS
PATCH, REPAIR AND REPLACE (E) BRICK CURB. MATCH IN
KIND | SEE PHOTOS IN 2/A1.23
(E) PARKING LOT ENTRANCE SIGN
PAINT (E) DECORATIVE METAL FENCE

(E) VAN ACCESSIBLE PARKING SIGN
PLAYGROUND GAME LINES - HALF BASKETBALL
REPAINT (E) DOOR SWING STRIPING
PRUNE (E) TREE, SEE LANDSCAPE DRAWINGS

NOTES

REFER TO SHEET G0.11 FOR TYPICAL SYMBOLS AND ABBREVIATIONS

ABBREVIATIONS
REFER TO LANDSCAPE DRAWINGS FOR PAVING AND
PLANTING INFORMATION

REFER TO MECHANICAL, ELECTRICAL, AND PLUMBING DRAWINGS FOR UTILITY INFORMATION

CONTRACTOR IS RESPONSIBLE FOR REPAIR/ REPLACEMENT OF ALL HARDSCAPE/PLANTING OUTSIDE OF LIMIT OF WORK LINE FOR CONNECTION OF

OVERALL PLANS ARE INTENDED TO PROVIDE CONTEXT FOR PARTIAL PLANS.

REFER TO PARTIAL PLANS FOR MORE INFORMATION.

PAINT ALL (E) DECORATIVE METAL FENCE REFER TO SITE DETAIL SHEETS FOR PLAYGROUND STRIPING DIMENSIONS

UNDERGROUND UTILITIES

ARCHITECT TO PROVIDE GRAPHICS FOR ALL THE PLAYGROUND STRIPINGS

RESTRIPE ALL (E) EXTERIOR DOOR OPENINGS THROUGHOUT CAMPUS

MATSUYAMA ELEMENTARY SCHOOL 7680 WINDBRIDGE DRIVE SACRAMENTO, CA 95831

ROJECT:

MATSUYAMA ELEMENTARY SCHOOL MODERNIZATION


SHEET NAME:
PARTIAL SITE PLAN SEGMENT - 2

TANTAL OTTE I LAN OLOMENT


DSA SUBMITTAL

DATE: 01/04/2024 CLIENT PROJ NO: 3186-070-000

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PARTIAL SITE PLAN SEGMENT - 2

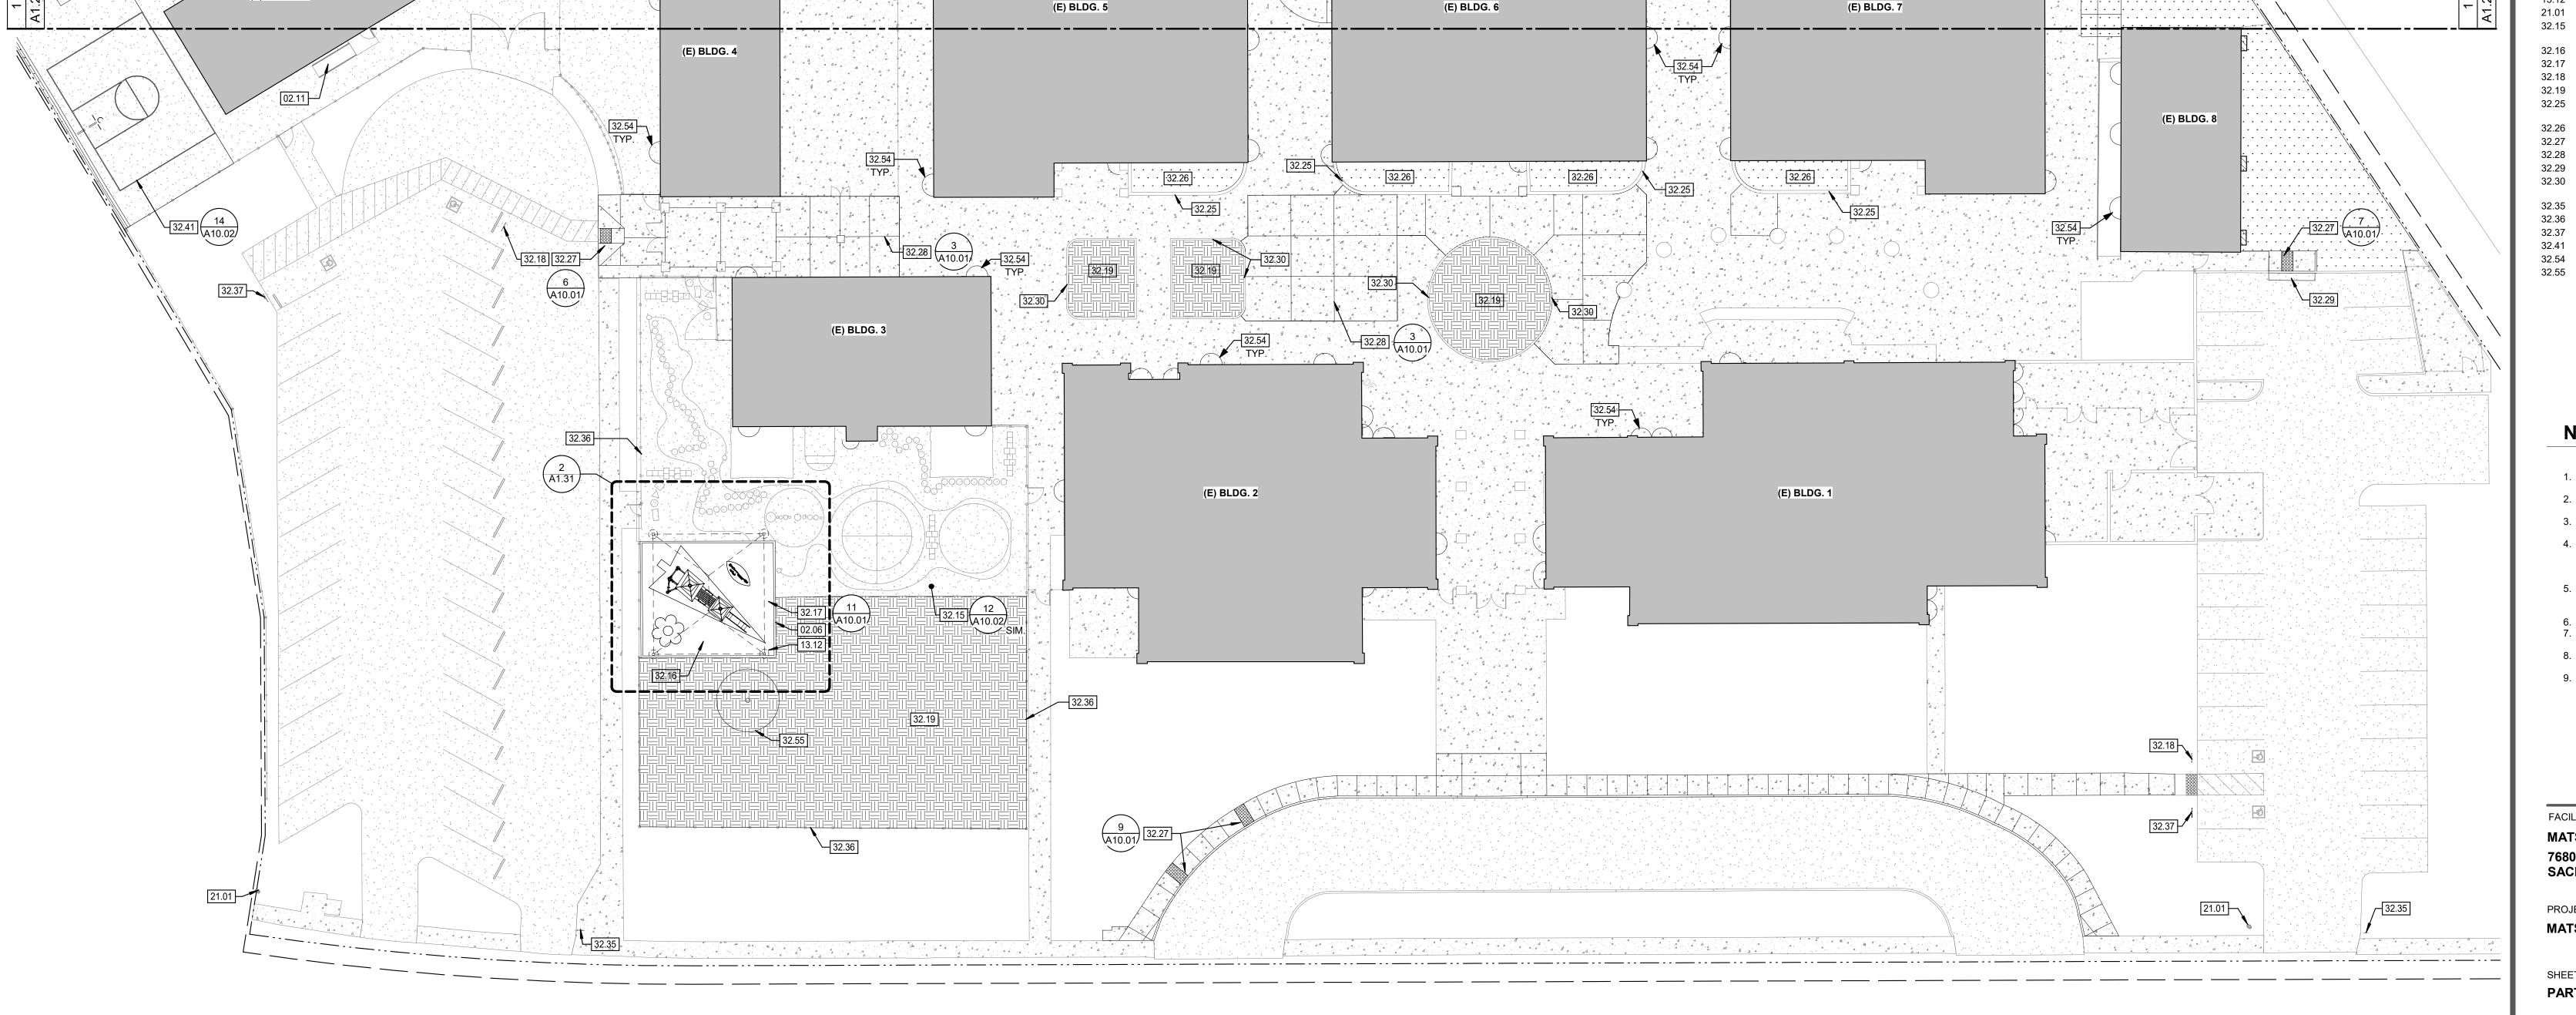


NOTE: PLAY EQUIPMENT IS NOT PART OF THE DSA STRUCTURAL SAFETY APPROVAL (DSA IR A-22)

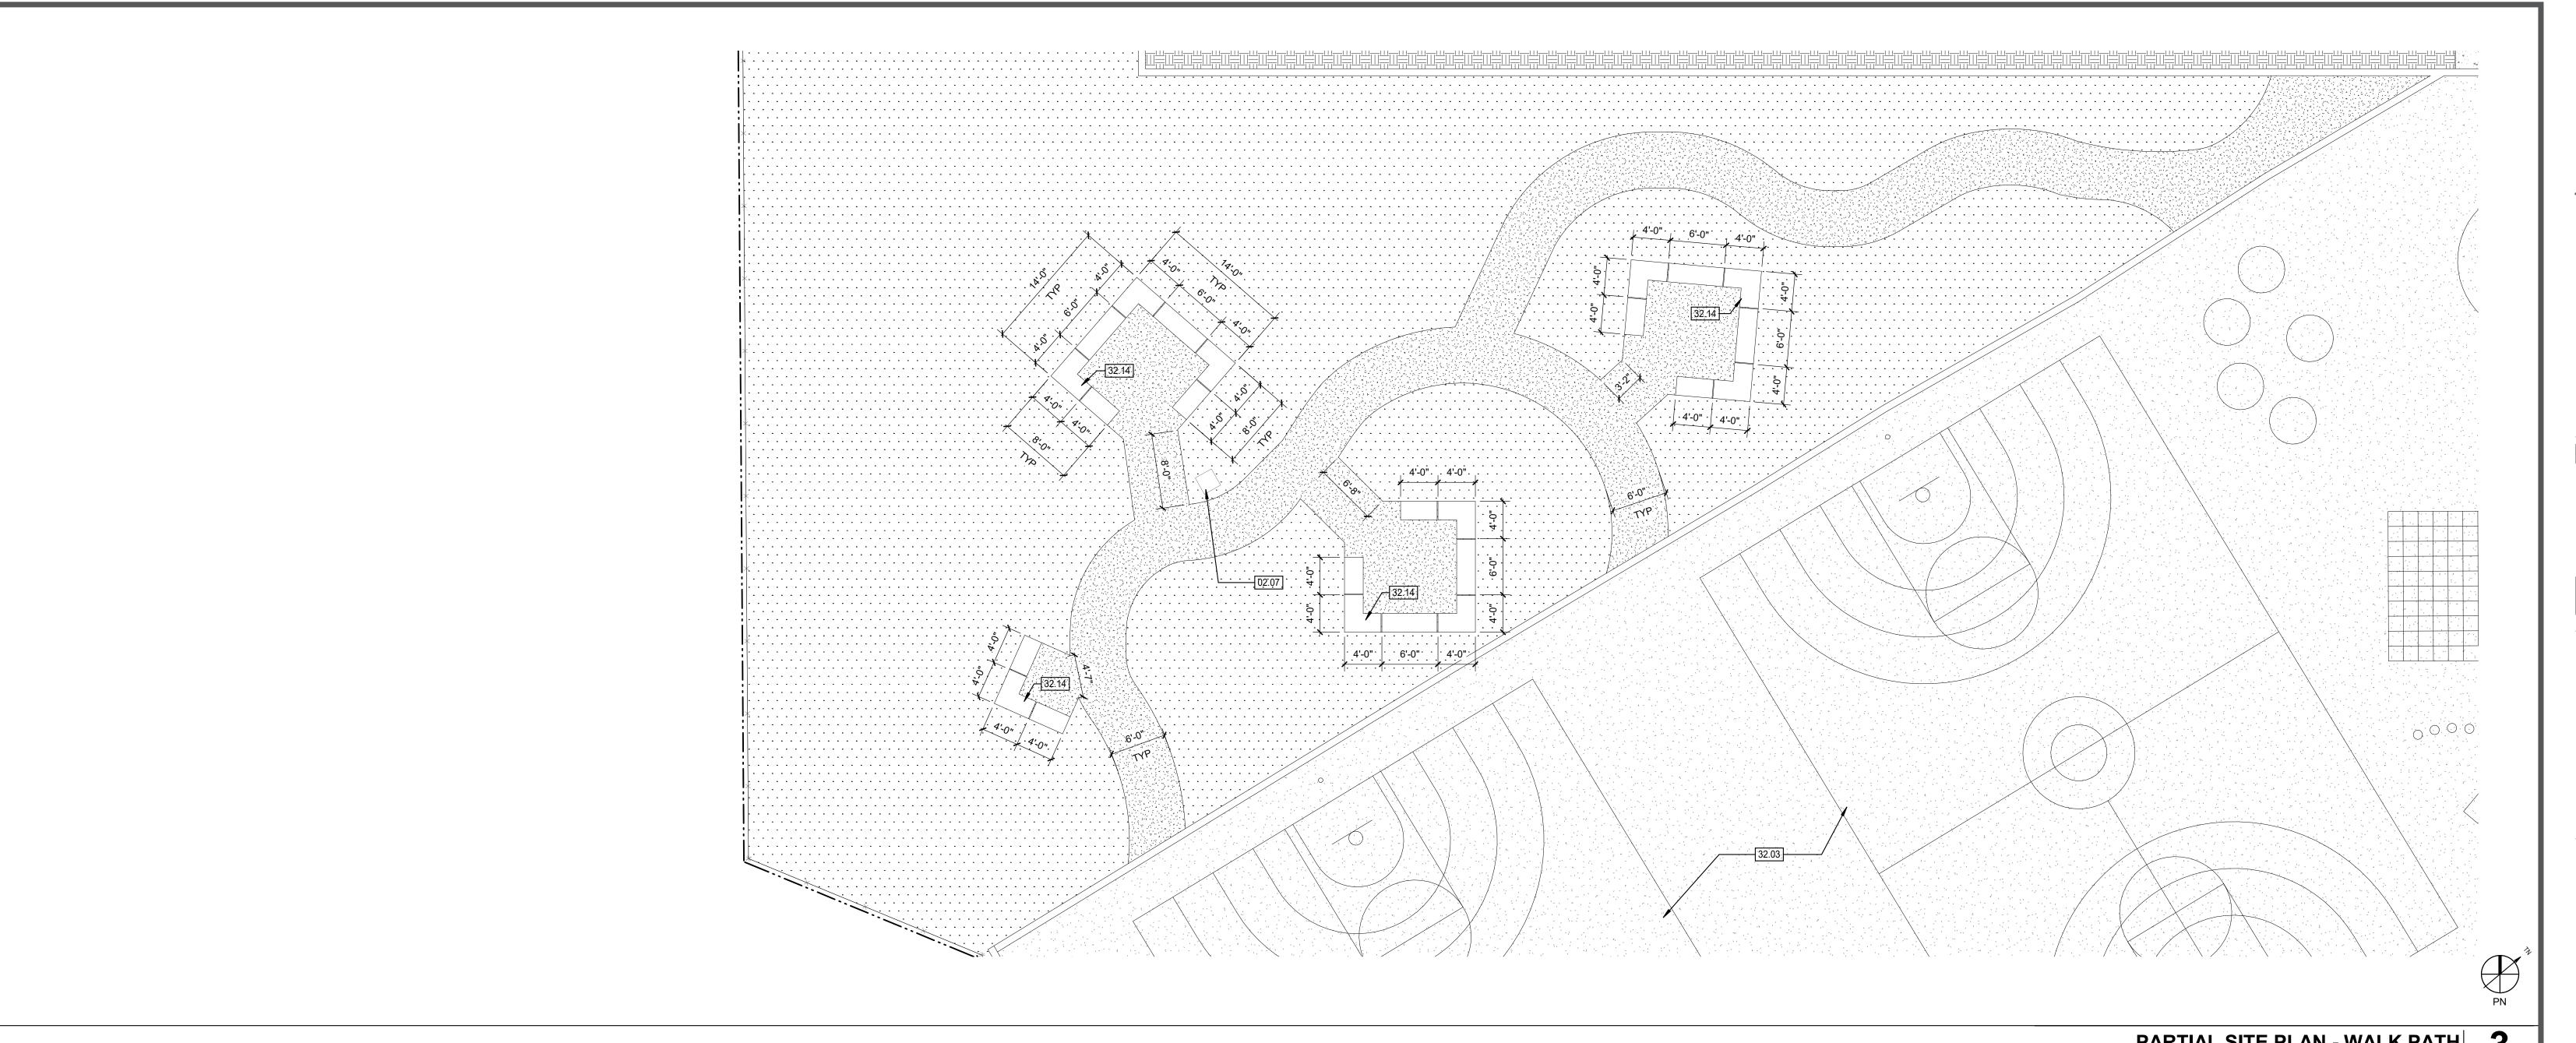PARTIAL SITE PLAN - KINDER PLAY YARD 2

1/8" = 1'-0"

PARTIAL SITE PLAN - WALK PATH 3

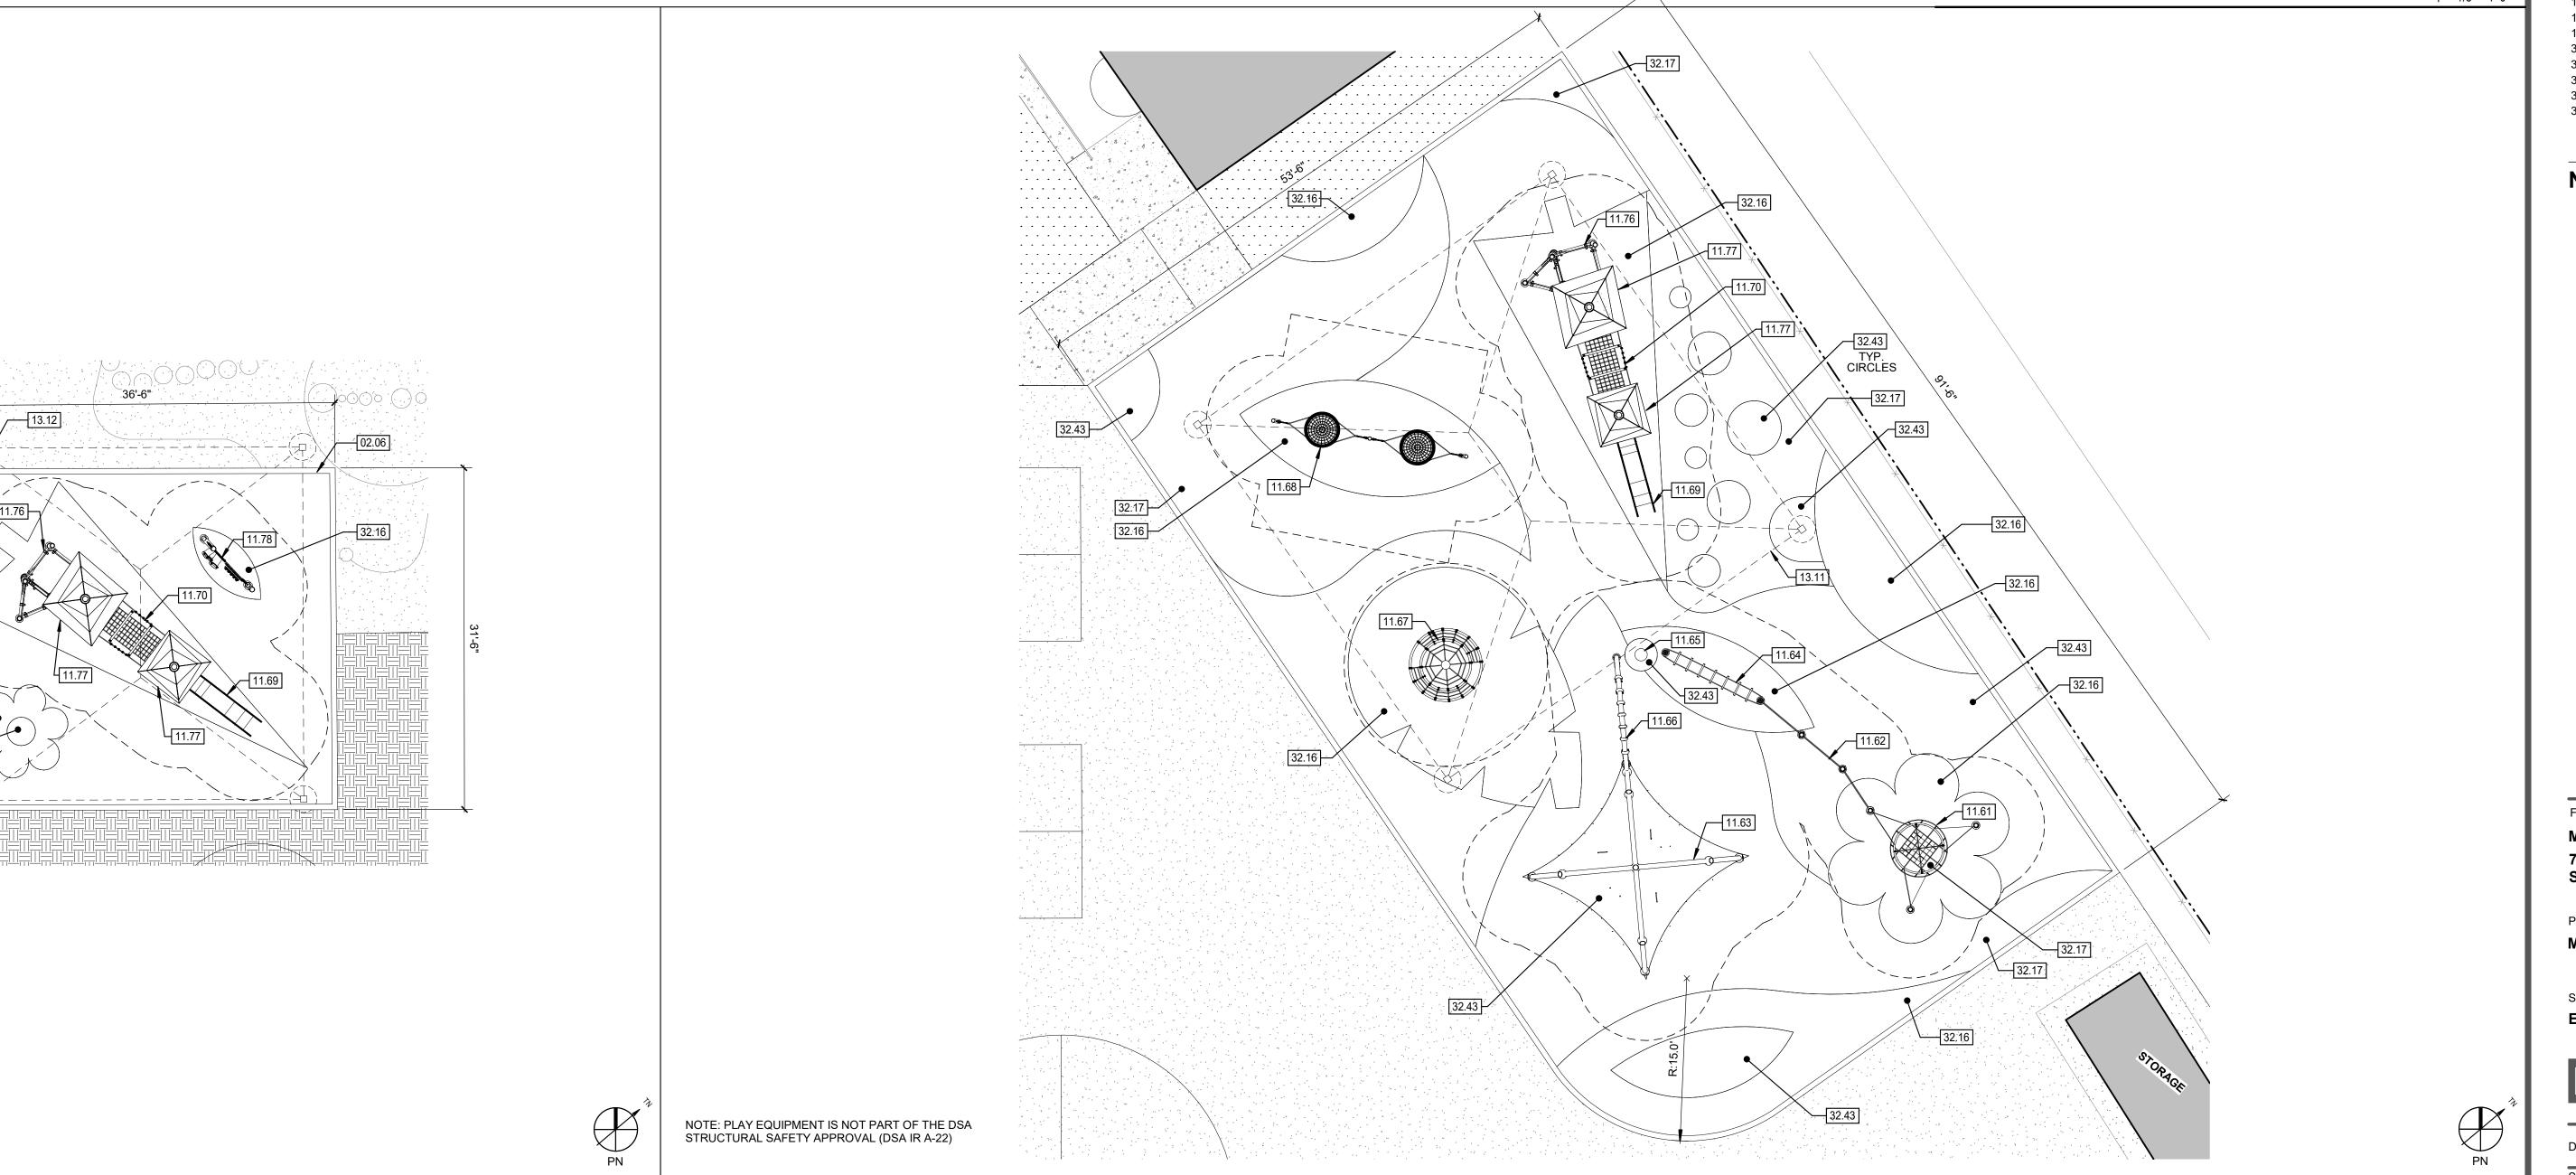

AGENCY APPROVAL:



DATE

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Δ **DESCRIPTION**

KEYNOTES

CONCRETE CURB, SEE CIVIL DWGS (E) DRAINAGE INLET, SEE CIVIL DWGS; PROTECT IN PLAY EQUIPMENT - WESPENNEST PLAY EQUIPMENT - CHIN-UP BAR PLAY EQUIPMENT - CLIMBING WEB PLAY EQUIPMENT - HOH LADDER PLAY EQUIPMENT - HDPE POD PLAY EQUIPMENT - DANGLE ARC WITH JUNGLE ROPE PLAY EQUIPMENT - CLIMBING TREE PLAY EQUIPMENT - NEST SWINGS PLAY EQUIPMENT - FASTLANE SLIDE PLAY EQUIPMENT - SUSPENSION BRIDGE PLAY EQUIPMENT - TRANSFER STATION PLAY EQUIPMENT - SHACK PLAY EQUIPMENT - PLAY PANEL 40'X40'X15' SHADE STRUCTURE, PC 04-121917 30'X30'X15' SHADE STRUCTURE, PC 04-121917 PLAYGROUND GAME LINES - FRACTION BALL

> PRECAST CONCRETE SEAT WALL POURED-IN-PLACE RUBBER, COLOR 1 POURED-IN-PLACE RUBBER, COLOR 2 POURED-IN-PLACE RUBBER, COLOR 3

NOTES

MATSUYAMA ELEMENTARY SCHOOL **7680 WINDBRIDGE DRIVE** SACRAMENTO, CA 95831


MATSUYAMA ELEMENTARY SCHOOL MODERNIZATION

SHEET NAME: **ENLARGED SITE PLAN**

DSA SUBMITTAL

DATE: 01/04/2024 CLIENT PROJ NO: 3186-070-000

PARTIAL SITE PLAN SEGMENT - 1

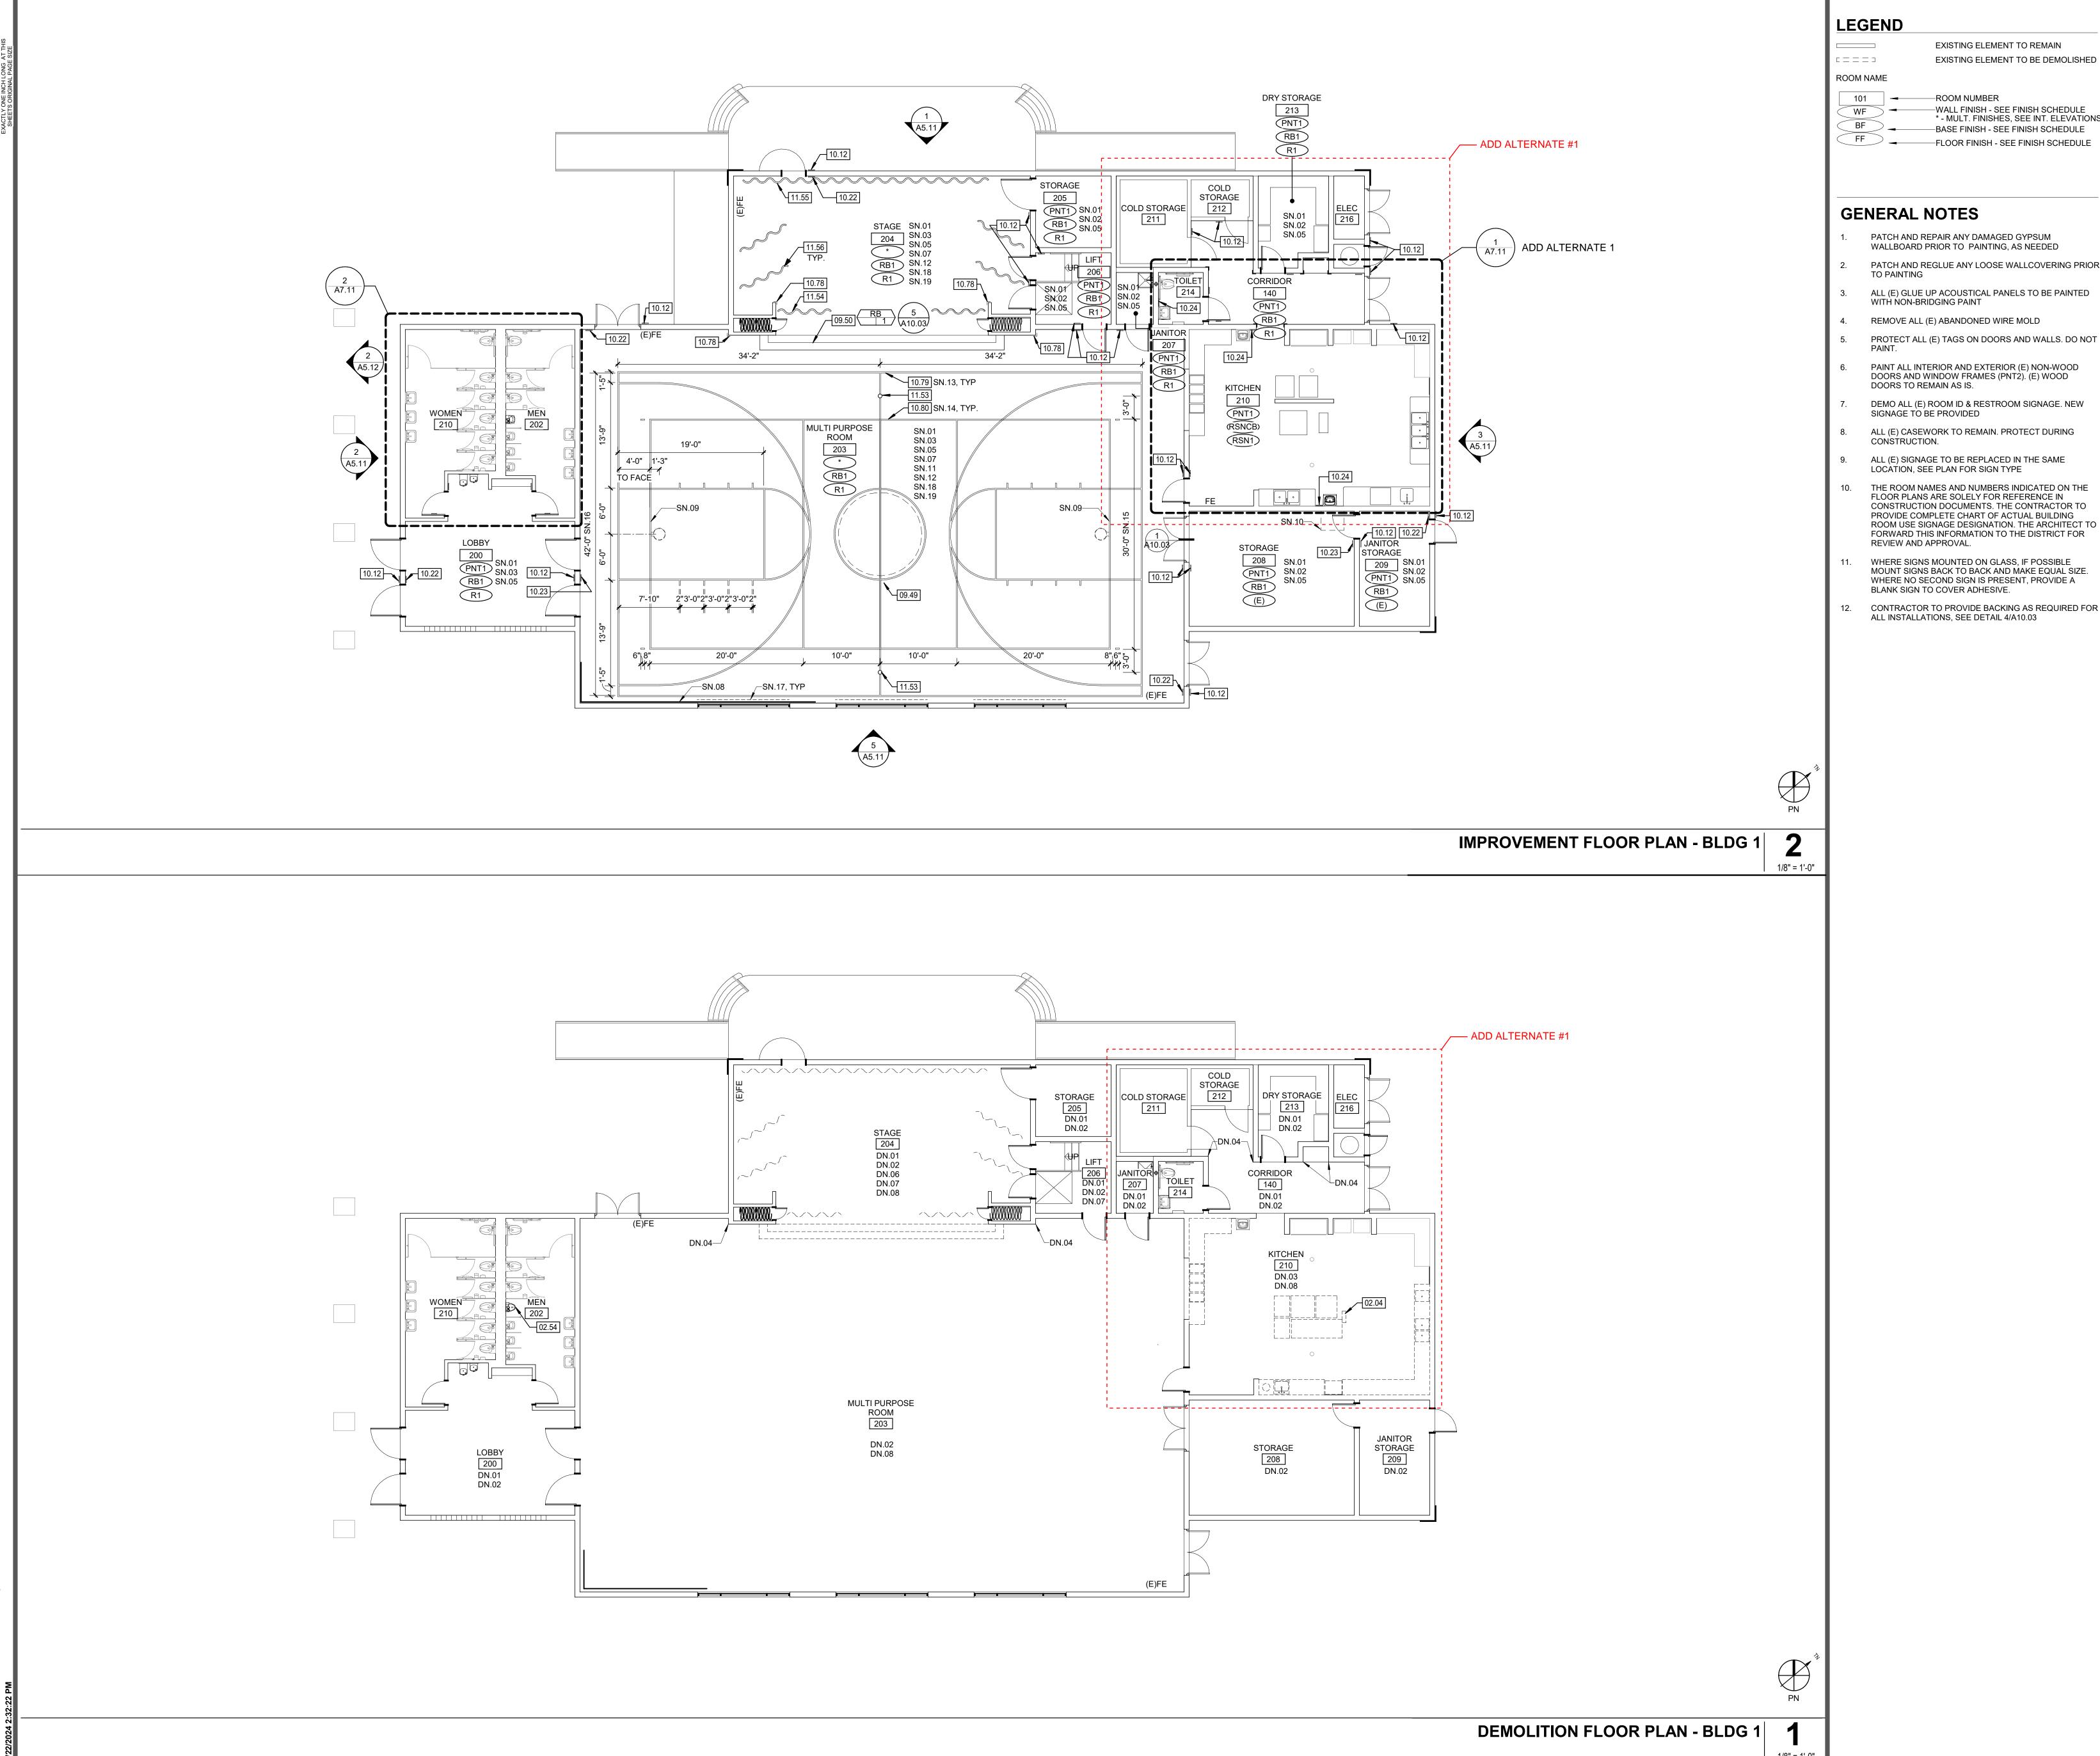

EXISTING ELEMENT TO BE DEMOLISHED

* - MULT. FINISHES, SEE INT. ELEVATIONS —BASE FINISH - SEE FINISH SCHEDULE

- PATCH AND REPAIR ANY DAMAGED GYPSUM WALLBOARD PRIOR TO PAINTING, AS NEEDED
- PATCH AND REGLUE ANY LOOSE WALLCOVERING PRIOR
- ALL (E) GLUE UP ACOUSTICAL PANELS TO BE PAINTED WITH NON-BRIDGING PAINT
- REMOVE ALL (E) ABANDONED WIRE MOLD
- DOORS AND WINDOW FRAMES (PNT2). (E) WOOD
- DEMO ALL (E) ROOM ID & RESTROOM SIGNAGE. NEW
- ALL (E) CASEWORK TO REMAIN. PROTECT DURING
- THE ROOM NAMES AND NUMBERS INDICATED ON THE FLOOR PLANS ARE SOLELY FOR REFERENCE IN CONSTRUCTION DOCUMENTS. THE CONTRACTOR TO PROVIDE COMPLETE CHART OF ACTUAL BUILDING ROOM USE SIGNAGE DESIGNATION. THE ARCHITECT TO FORWARD THIS INFORMATION TO THE DISTRICT FOR
- MOUNT SIGNS BACK TO BACK AND MAKE EQUAL SIZE. WHERE NO SECOND SIGN IS PRESENT, PROVIDE A
- CONTRACTOR TO PROVIDE BACKING AS REQUIRED FOR ALL INSTALLATIONS, SEE DETAIL 4/A10.03

AGENCY APPROVAL:



C-25193

DATE

REN. 07/31/25

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△ DESCRIPTION

KEYNOTES

REMOVE (E) WALL. CAP (E) GAS LINE AND UTILITIES ABOVE CÈILING | SEE PLUMBING DWGS

REMOVE (E) MISC ACCESSORIES, EQUIPMENT & FURNITURE. RETURN TO OWNER FOR SALVAGE/REUSE PER CONTRACTOR/OWNER AGREEMENT

SCHOOL LOGO TO BE INLAID IN RUBBER FLOORING LOGO TO BE PROVIDED BY ARCHITECT

RUBBER STAIR TREADS 10.12 ROOM ID SIGN | 5/A10.04

10.22 TACTILE "EXIT" SIGN | 6/A10.04 10.23 TACTILE "EXIT ROUTE" SIGN | 6/A10.04

10.24 HAND WASH SIGN 10.78 CORNER GUARD - PLASTIC CG1

10.79 BASKETBALL STRIPING 10.80 VOLLEYBALL STRIPING

11.53 ATHLETIC EQUIPMENT : FLOOR SLEEVE THEATRICAL DRAPERIES : TRAVELER CURTAIN

THEATRICAL DRAPERIES : REAR CURTAIN

THEATRICAL DRAPERIES : LEG CURTAINS

DEMOLITION NOTES

DN.01 (E) VCT TO BE REMOVED IN ITS ENTIRETY DN.02 (E) RUBBER BASE TO BE REMOVED IN ITS ENTIRETY

DN.03 (E) TILE FLOORING & BASE TO BE REMOVED IN THEIR ENTIRETY DN.04 (E) CORNER GUARD TO BE REMOVED. PATCH AND REPAIR

DN.05 (E) MOTORIZED DRAPERY TO BE REMOVED IN ITS ENTIRETY DN.06 (E) THEATRICAL DRAPERY TO BE REMOVED IN THEIR ENTIRETY

DN.07 (E) STAIR TREADS TO BE REMOVED IN THEIR ENTIRETY DN.08 (E) CLOCKS AND WALL MOUNTED HAND SANITIZER DISPENSER TO BE REMOVED AND STORED

SHEET NOTES

SN.01 (E) GYPSUM WALLBOARD AND WALLCOVERING TO BE

SN.02 (E) GYPSUM WALLBOARD CEILING TO BE PAINTED (PNT1)

SN.03 (E) GLUE UP TILES ON WALLS AND CEILINGS TO BE PAINTED (PNT1, U.N.O.) SN.04 PAINT (E) GRID AND DIFFUSERS (PNT1, U.N.O.) AND INSTALL LAY-

IN CEILING PANEL (ACP1) SN.05 INSTALL RUBBER BASE SN.06 INSTALL 8'-0" CORNER GUARDS

SN.07 (E) WALL PANELING TO BE PAINTED SN.08 PROTECT (E) ROCK CLIMBING WALL DURING CONSTRUCTION SN.09 (E) BASKETBALL SUPPORTS TO BE DEEP CLEANED

SN.10 (E) IDF BOX. PROTECT DURING CONSTRUCTION. SN.11 (E) WOOD TRIM TO BE PAINTED SN.12 ALL (E) CEILING MOUNTED DEVICES TO BE REMOVED, STORED,

NEW CEILING TILES SN.13 2" WIDE (U.N.O.) COURT MARKING: COLOR 1

SN.14 2" WIDE (U.N.O.) COURT MARKING: COLOR 2 SN.15 TO OUTSIDE OF STRIPE

SN.16 TO INSIDE OF STRIPE SN.17 REPLACE (E) DRAPERY WITH NEW ROLLER WINDOW SHADES SN.18 (E) CLOCKS AND WALL MOUNTED HAND SANITIZER DISPENSERS

AND REINSTALLED IN SAME LOCATION AFTER INSTALLATION OF

TO BE REINSTALLED IN SAME LOCATION SN.19 REFER TO INTERIOR ELEVATIONS FOR ADDITIONAL


MATSUYAMA ELEMENTARY SCHOOL **7680 WINDBRIDGE DRIVE** SACRAMENTO, CA 95831

MATSUYAMA ELEMENTARY SCHOOL MODERNIZATION

DEMOLITION AND IMPROVEMENT FLOOR PLANS -

DSA SUBMITTAL

DATE: 01/04/2024

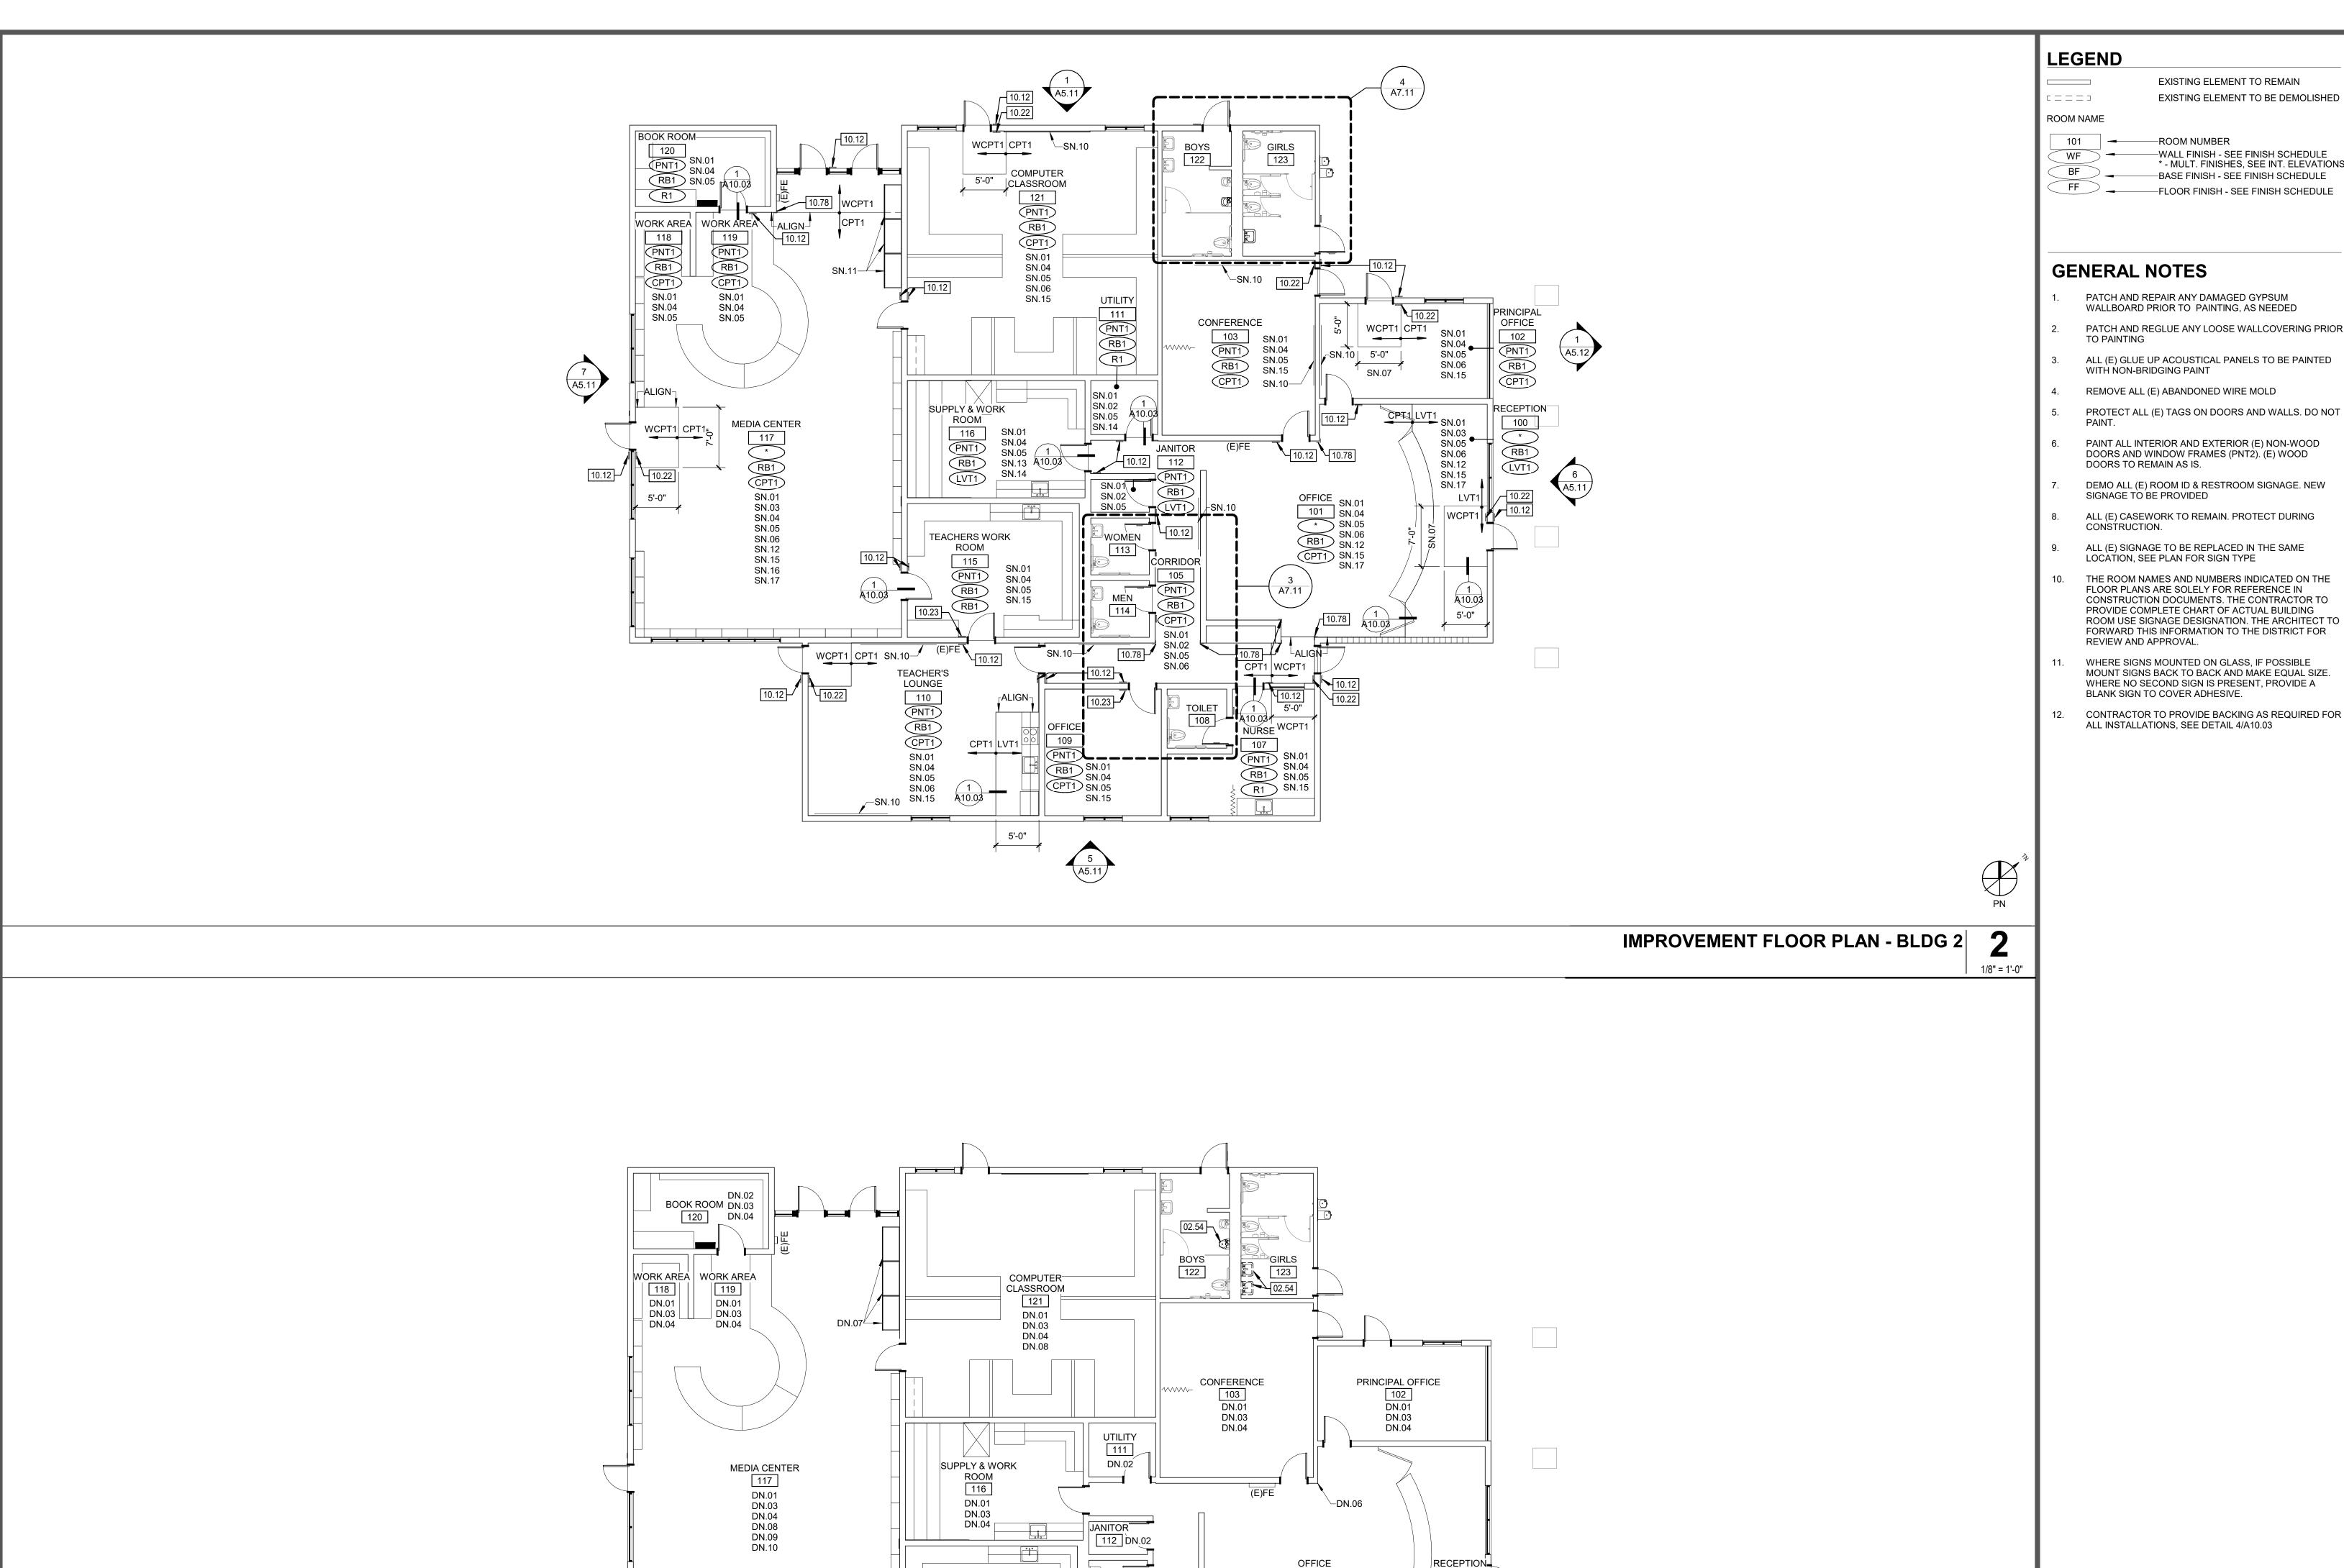

TEACHERS WORK

ROOM

115_

DN.02 DN.03 DN.04 DN.08_

TEACHER'S LOUNGE

110 DN.01 DN.03 DN.04

100

DN.05

DEMOLITION FLOOR PLAN - BLDG 2

1/8" = 1'-0"

101

DN.01

DN.03

DN.06-

DN.02 DN.03 DN.04

DN.01 DN.03

114

OFFICE 109 DN.01 DN.03 DN.04

EXISTING ELEMENT TO REMAIN EXISTING ELEMENT TO BE DEMOLISHED

-ROOM NUMBER

-WALL FINISH - SEE FINISH SCHEDULE * - MULT. FINISHES, SEE INT. ELEVATIONS BASE FINISH - SEE FINISH SCHEDULE FLOOR FINISH - SEE FINISH SCHEDULE

GENERAL NOTES

- PATCH AND REPAIR ANY DAMAGED GYPSUM WALLBOARD PRIOR TO PAINTING, AS NEEDED
- PATCH AND REGLUE ANY LOOSE WALLCOVERING PRIOR
- ALL (E) GLUE UP ACOUSTICAL PANELS TO BE PAINTED WITH NON-BRIDGING PAINT
- REMOVE ALL (E) ABANDONED WIRE MOLD
- PAINT ALL INTERIOR AND EXTERIOR (E) NON-WOOD
- DOORS AND WINDOW FRAMES (PNT2). (E) WOOD DOORS TO REMAIN AS IS.
- DEMO ALL (E) ROOM ID & RESTROOM SIGNAGE. NEW SIGNAGE TO BE PROVIDED
- ALL (E) CASEWORK TO REMAIN. PROTECT DURING CONSTRUCTION.
- LOCATION, SEE PLAN FOR SIGN TYPE THE ROOM NAMES AND NUMBERS INDICATED ON THE
- FLOOR PLANS ARE SOLELY FOR REFERENCE IN CONSTRUCTION DOCUMENTS. THE CONTRACTOR TO PROVIDE COMPLETE CHART OF ACTUAL BUILDING ROOM USE SIGNAGE DESIGNATION. THE ARCHITECT TO FORWARD THIS INFORMATION TO THE DISTRICT FOR REVIEW AND APPROVAL.
- WHERE SIGNS MOUNTED ON GLASS, IF POSSIBLE MOUNT SIGNS BACK TO BACK AND MAKE EQUAL SIZE. WHERE NO SECOND SIGN IS PRESENT, PROVIDE A BLANK SIGN TO COVER ADHESIVE.
- CONTRACTOR TO PROVIDE BACKING AS REQUIRED FOR ALL INSTALLATIONS, SEE DETAIL 4/A10.03

AGENCY APPROVAL:



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DATE

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KEYNOTES

REMOVE (E) MISC ACCESSORIES, EQUIPMENT & PER CONTRACTOR/OWNER AGREEMENT

ROOM ID SIGN | 5/A10.04 TACTILE "EXIT" SIGN | 6/A10.04 10.22 10.23

TACTILE "EXIT ROUTE" SIGN | 6/A10.04 CORNER GUARD - PLASTIC CG1

DEMOLITION NOTES

DN.01 (E) CARPET TO BE REMOVED IN ITS ENTIRETY

DN.02 (E) VCT TO BE REMOVED IN ITS ENTIRETY DN.03 (E) RUBBER BASE TO BE REMOVED IN ITS ENTIRETY DN.04 (E) LAY-IN CEILING PANELS TO BE REMOVED IN THEIR ENTIRETY.

(E) GRID TO REMAIN DN.05 (E) TILE FLOORING TO BE REMOVED IN ITS ENTIRETY DN.06 (E) CORNER GUARDS TO BE REMOVED. PATCH AND REPAIR

DN.07 (E) DISPLAY CASES TO BE REMOVED, STORED & REINSTALLED IN THE SAME LOCATION

DN.08 (E) CLOCKS AND WALL MOUNTED HAND SANITIZER DISPENSERS TO BE REMOVED AND STORED

DN.09 (E) DRAPERY TO BE REMOVED IN ITS ENTIRETY DN.10 (E) PROJECTION SCREEN TO BE REMOVED AND STORED

SHEET NOTES

SN.01 (E) GYPSUM WALLBOARD AND WALLCOVERING TO BE

SN.02 (E) GYPSUM WALLBOARD CEILING TO BE PAINTED (PNT1) SN.03 (E) GLUE UP TILES ON WALLS AND CEILINGS TO BE PAINTED

(PNT1 U.N.O.) SN.04 PAINT (E) GRID AND DIFFUSERS (PNT1, U.N.O.) AND INSTALL LAY-IN CEILING PANEL (ACP1)

SN.05 INSTALL RUBBER BASE SN.06 INSTALL WALK-OFF CARPET AT EXTERIOR DOORS

DURING CONSTRUCTION

SN.07 CENTER ON DOOR SN.08 INSTALL 8'-0" CORNER GUARDS

SN.09 DEEP CLEAN FRP. DO NOT PAINT. SN.10 (E) MARKERBOARDS AND TACKBOARDS TO REMAIN. PROTECT

SN.11 (E) DISPLAY CASES TO BE REMOVED, STORED & REINSTALLED IN THE SAME LOCATION AND TO MEET ADA CLEARANCE TO RM

121 DOOR SN.12 (E) WOOD TRIM TO BE PAINTED SN.13 (E) IDF BOX. PROTECT DURING CONSTRUCTION.

SN.14 (E) ELECTRICAL PANELS. PROTECT DURING CONSTRUCTION SN.15 (E) CLOCKS AND WALL MOUNTED HAND SANITIZER DISPENSERS

TÓ BE REINSTALLED IN SAME LOCATION SN.16 (E) PROJECTION SCREEN TO BE REINSTALLED IN SAME

LOCATION SN.17 REFER TO INTERIOR ELEVATIONS FOR ADDITIONAL

INFORMATION


MATSUYAMA ELEMENTARY SCHOOL **7680 WINDBRIDGE DRIVE** SACRAMENTO, CA 95831

MATSUYAMA ELEMENTARY SCHOOL MODERNIZATION

DATE: 01/04/2024

DEMOLITION AND IMPROVEMENT FLOOR PLANS -

DSA SUBMITTAL

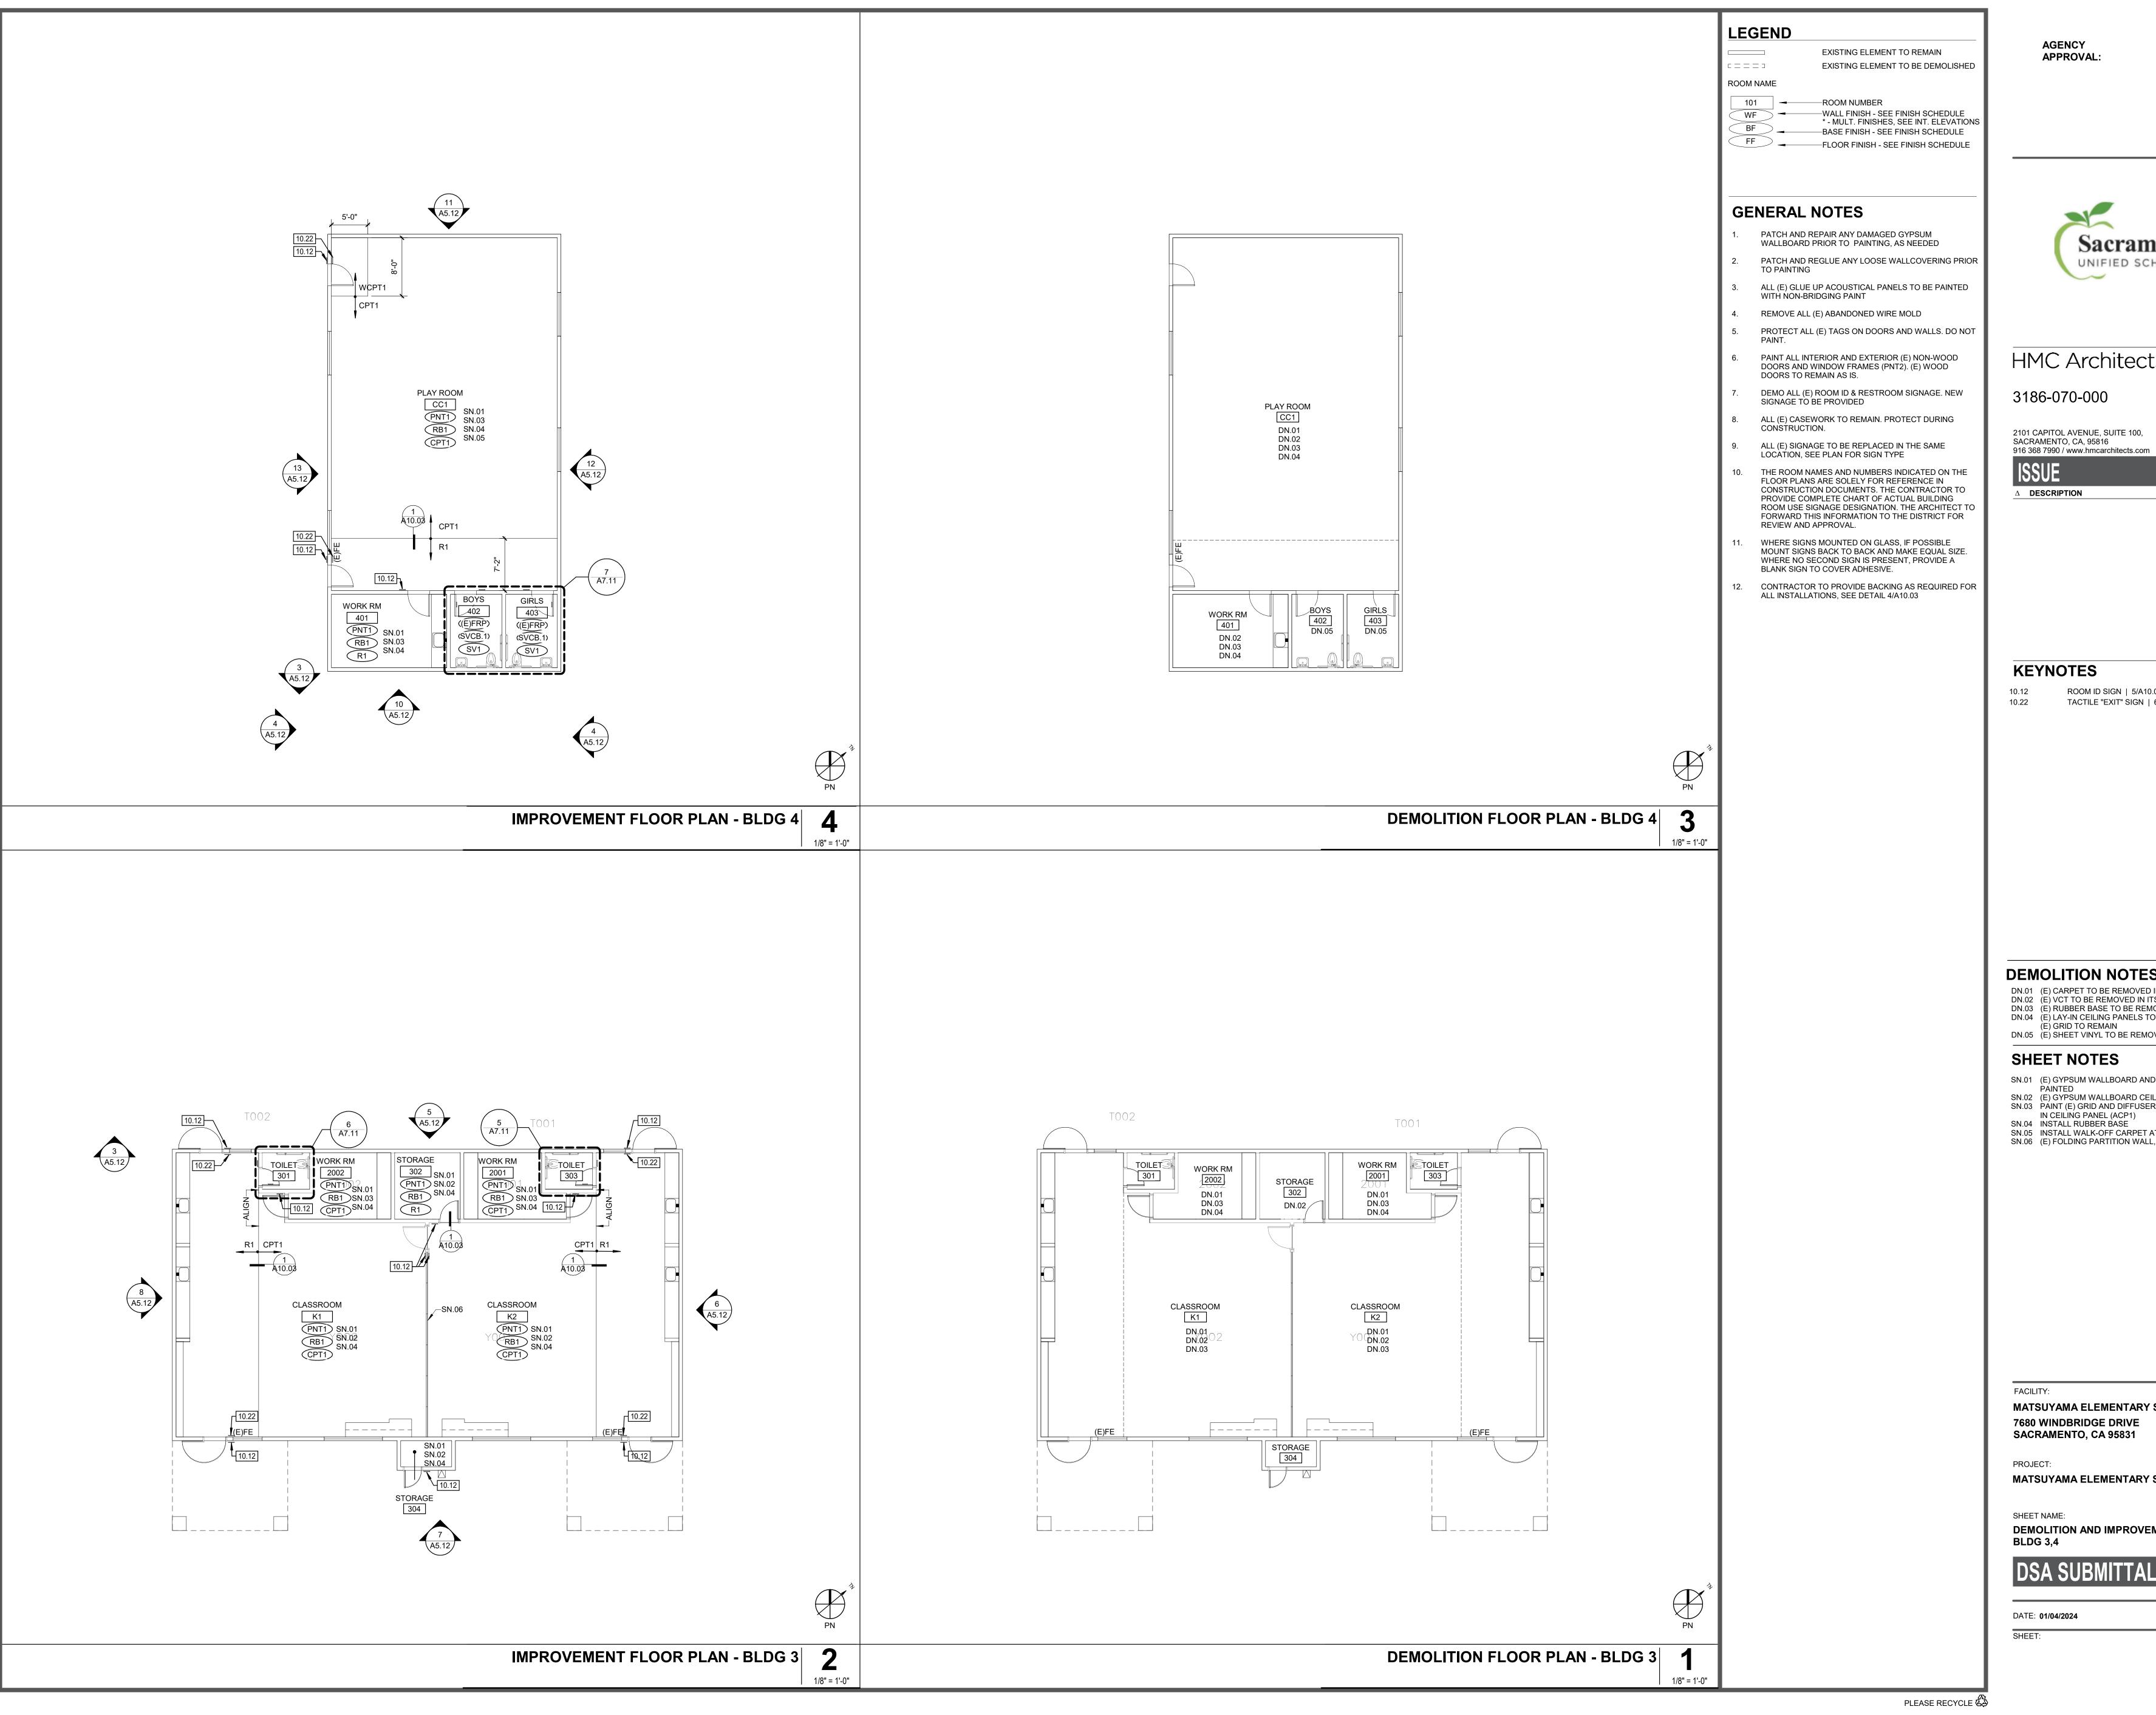

AGENCY APPROVAL:

UNIFIED SCHOOL DISTRICT

C-25193

DATE

HMC Architects

3186-070-000

△ **DESCRIPTION**

KEYNOTES

ROOM ID SIGN | 5/A10.04 TACTILE "EXIT" SIGN | 6/A10.04

DEMOLITION NOTES

DN.01 (E) CARPET TO BE REMOVED IN ITS ENTIRETY DN.02 (E) VCT TO BE REMOVED IN ITS ENTIRETY

DN.03 (E) RUBBER BASE TO BE REMOVED IN ITS ENTIRETY DN.04 (E) LAY-IN CEILING PANELS TO BE REMOVED IN THEIR ENTIRETY.

(E) GRID TO REMAIN DN.05 (E) SHEET VINYL TO BE REMOVED IN ITS ENTIRETY

SHEET NOTES

SN.01 (E) GYPSUM WALLBOARD AND WALLCOVERING TO BE

SN.02 (E) GYPSUM WALLBOARD CEILING TO BE PAINTED (PNT1) SN.03 PÁINT (E) GRID AND DIFFUSERS (PNT1, U.N.O.) AND INSTÁLL LAY-

IN CEILING PANEL (ACP1) SN.04 INSTALL RUBBER BASE SN.05 INSTALL WALK-OFF CARPET AT EXTERIOR DOORS


SN.06 (E) FOLDING PARTITION WALL, CLEAN (E) FINISH

MATSUYAMA ELEMENTARY SCHOOL **7680 WINDBRIDGE DRIVE**

MATSUYAMA ELEMENTARY SCHOOL MODERNIZATION

DEMOLITION AND IMPROVEMENTN FLOOR PLANS -**BLDG 3,4**

DSA SUBMITTAL

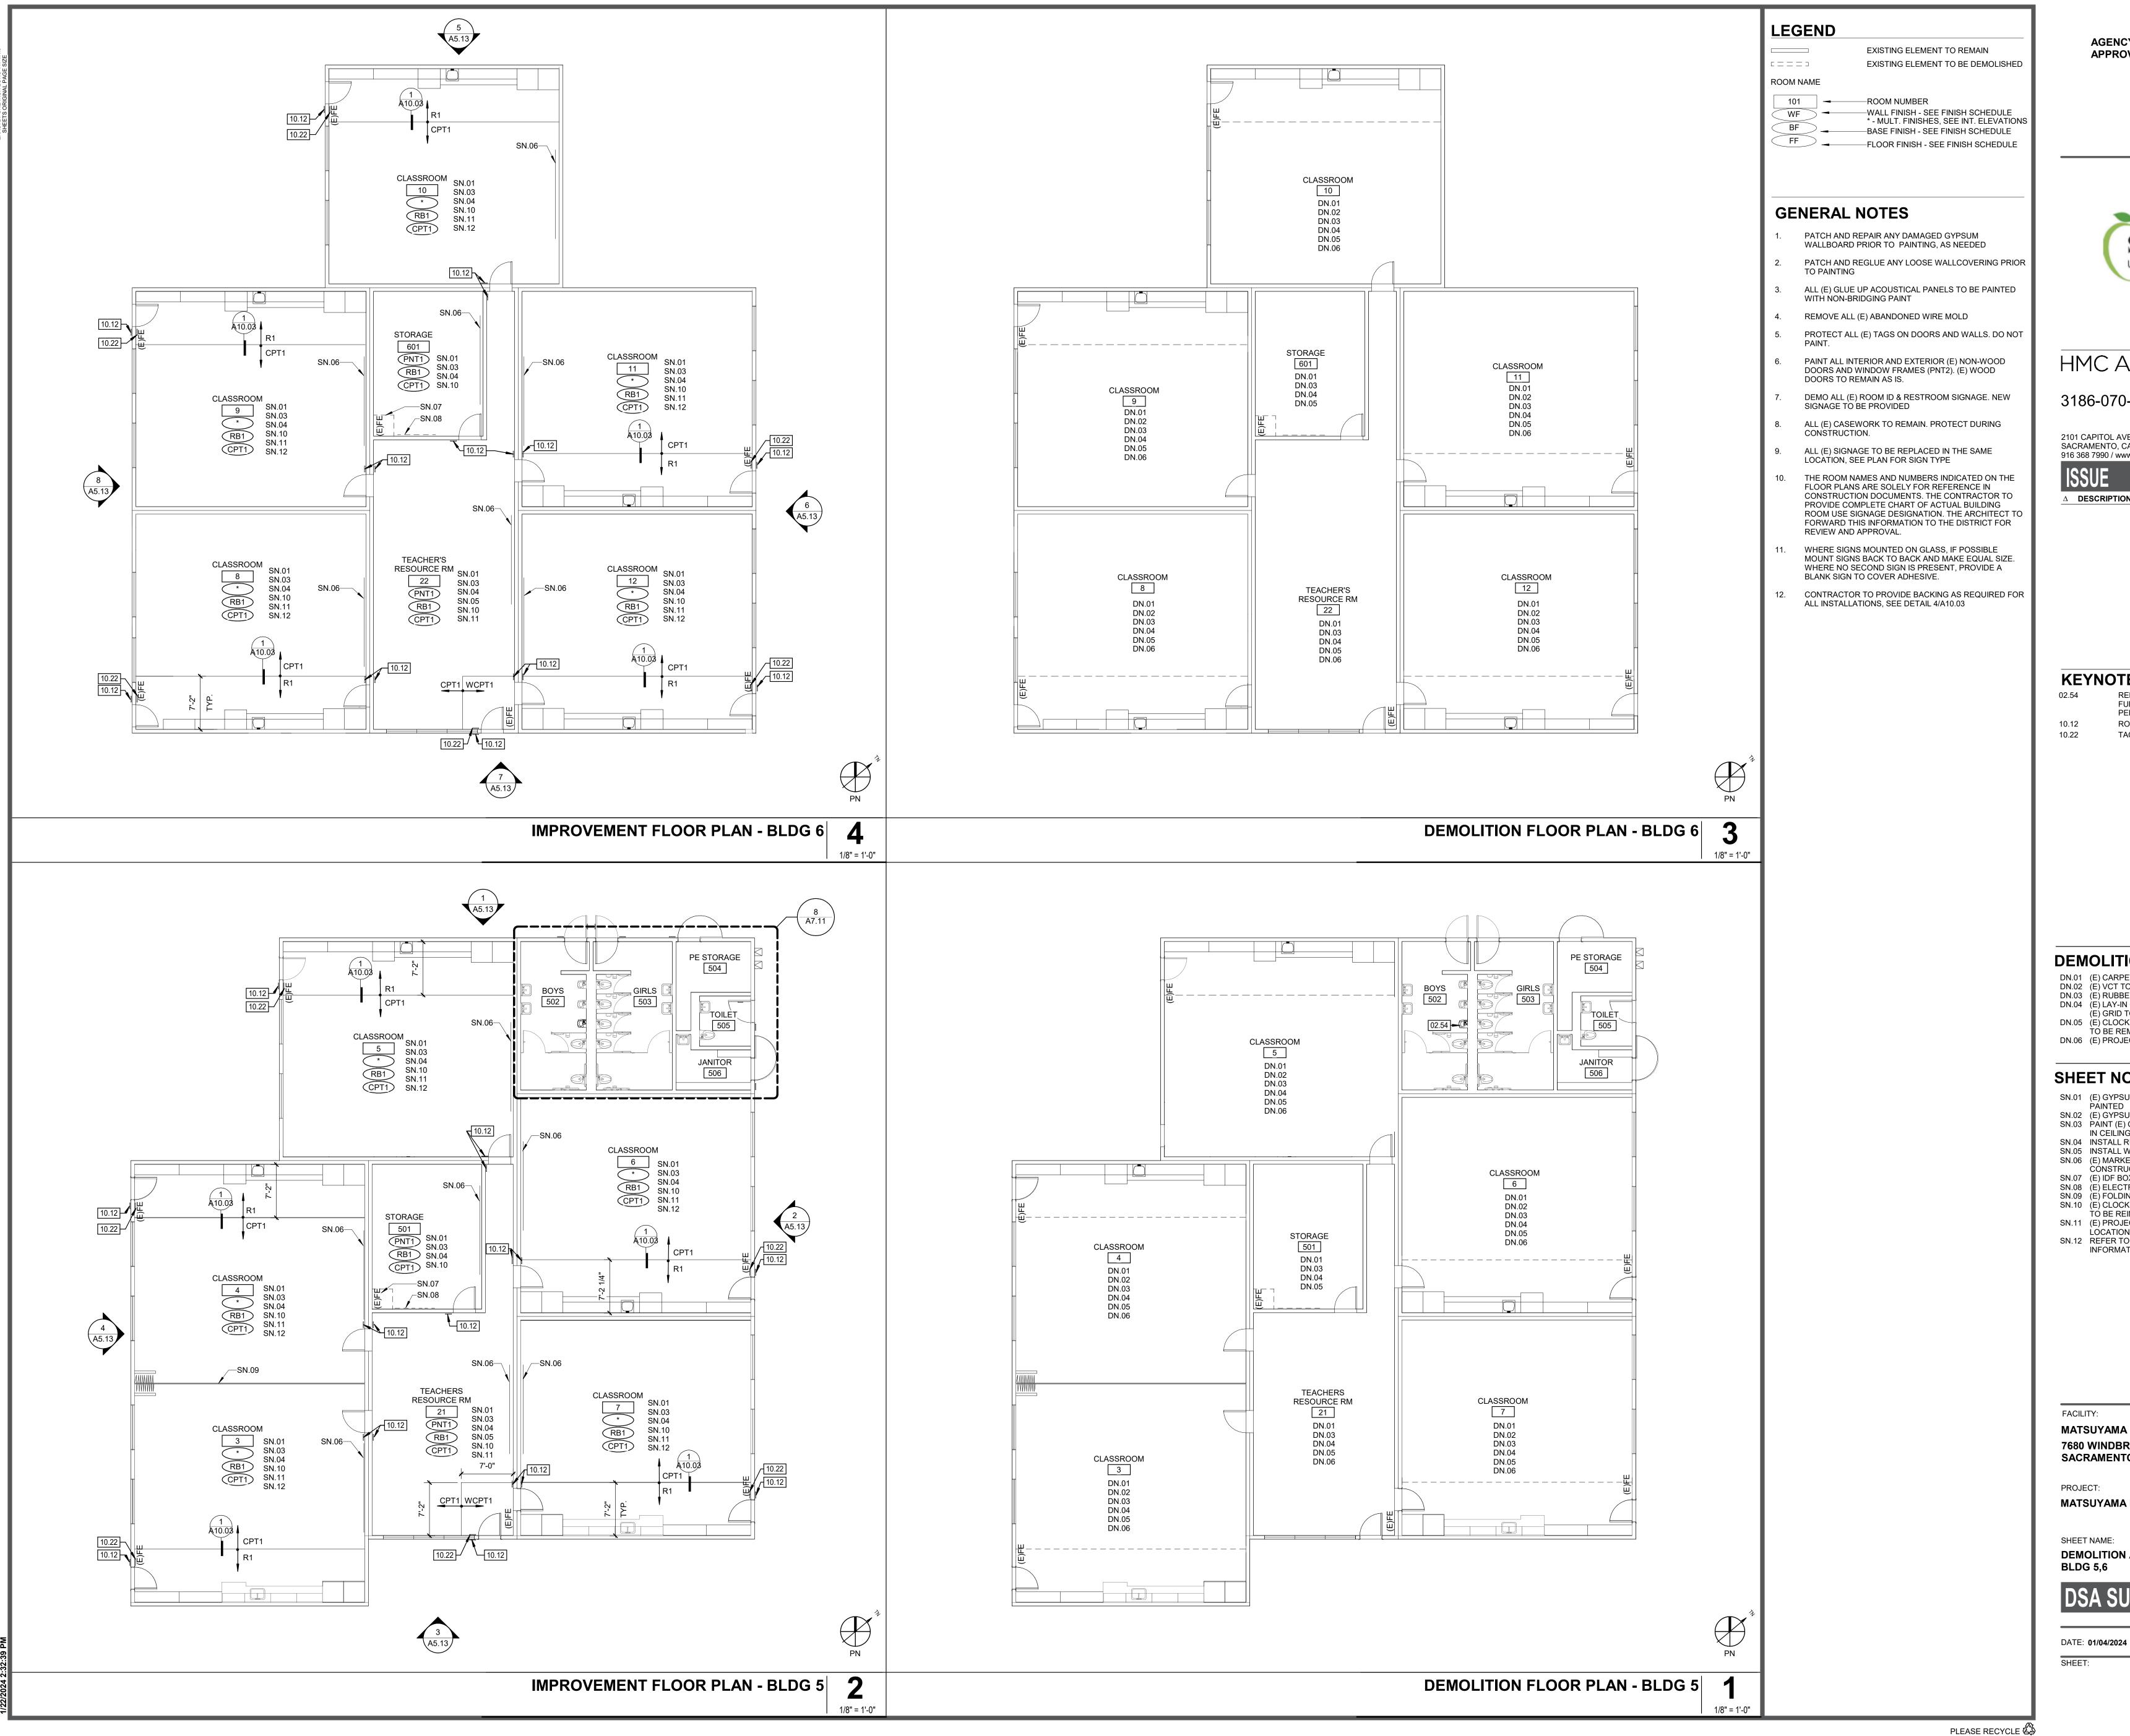



C-25193

DATE

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3186-070-000

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△ **DESCRIPTION**

KEYNOTES

REMOVE (E) MISC ACCESSORIES, EQUIPMENT & FURNITURE. RETURN TO OWNER FOR SALVAGE/REUSE PER CONTRACTOR/OWNER AGREEMENT

ROOM ID SIGN | 5/A10.04

TACTILE "EXIT" SIGN | 6/A10.04

DEMOLITION NOTES

DN.01 (E) CARPET TO BE REMOVED IN ITS ENTIRETY DN.02 (E) VCT TO BE REMOVED IN ITS ENTIRETY DN.03 (E) RUBBER BASE TO BE REMOVED IN ITS ENTIRETY

DN.04 (E) LAY-IN CEILING PANELS TO BE REMOVED IN THEIR ENTIRETY.

DN.05 (E) CLOCKS AND WALL MOUNTED HAND SANITIZER DISPENSERS TO BE REMOVED AND STORED

DN.06 (E) PROJECTION SCREEN TO BE REMOVED AND STORED

SHEET NOTES

SN.01 (E) GYPSUM WALLBOARD AND WALLCOVERING TO BE

SN.02 (E) GYPSUM WALLBOARD CEILING TO BE PAINTED (PNT1) SN.03 PAINT (E) GRID AND DIFFUSERS (PNT1, U.N.O.) AND INSTALL LAY-IN CEILING PANEL (ACP1)

SN.04 INSTALL RUBBER BASE SN.05 INSTALL WALK-OFF CARPET AT EXTERIOR DOORS

SN.06 (E) MARKERBOARDS TO REMAIN. PROTECT DURING CONSTRUCTION SN.07 (E) IDF BOX. PROTECT DURING CONSTRUCTION.

SN.08 (E) ELECTRICAL PANELS. PROTECT DURING CONSTRUCTION SN.09 (E) FOLDING PARTITION WALL, CLEAN (E) FINISH

SN.10 (E) CLOCKS AND WALL MOUNTED HAND SANITIZER DISPENSERS TO BE REINSTALLED IN SAME LOCATION SN.11 (E) PROJECTION SCREEN TO BE REINSTALLED IN SAME


SN.12 REFER TO INTERIOR ELEVATIONS FOR ADDITIONAL INFORMATION

MATSUYAMA ELEMENTARY SCHOOL **7680 WINDBRIDGE DRIVE** SACRAMENTO, CA 95831

MATSUYAMA ELEMENTARY SCHOOL MODERNIZATION

DEMOLITION AND IMPROVEMENT FLOOR PLANS -

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△ **DESCRIPTION**

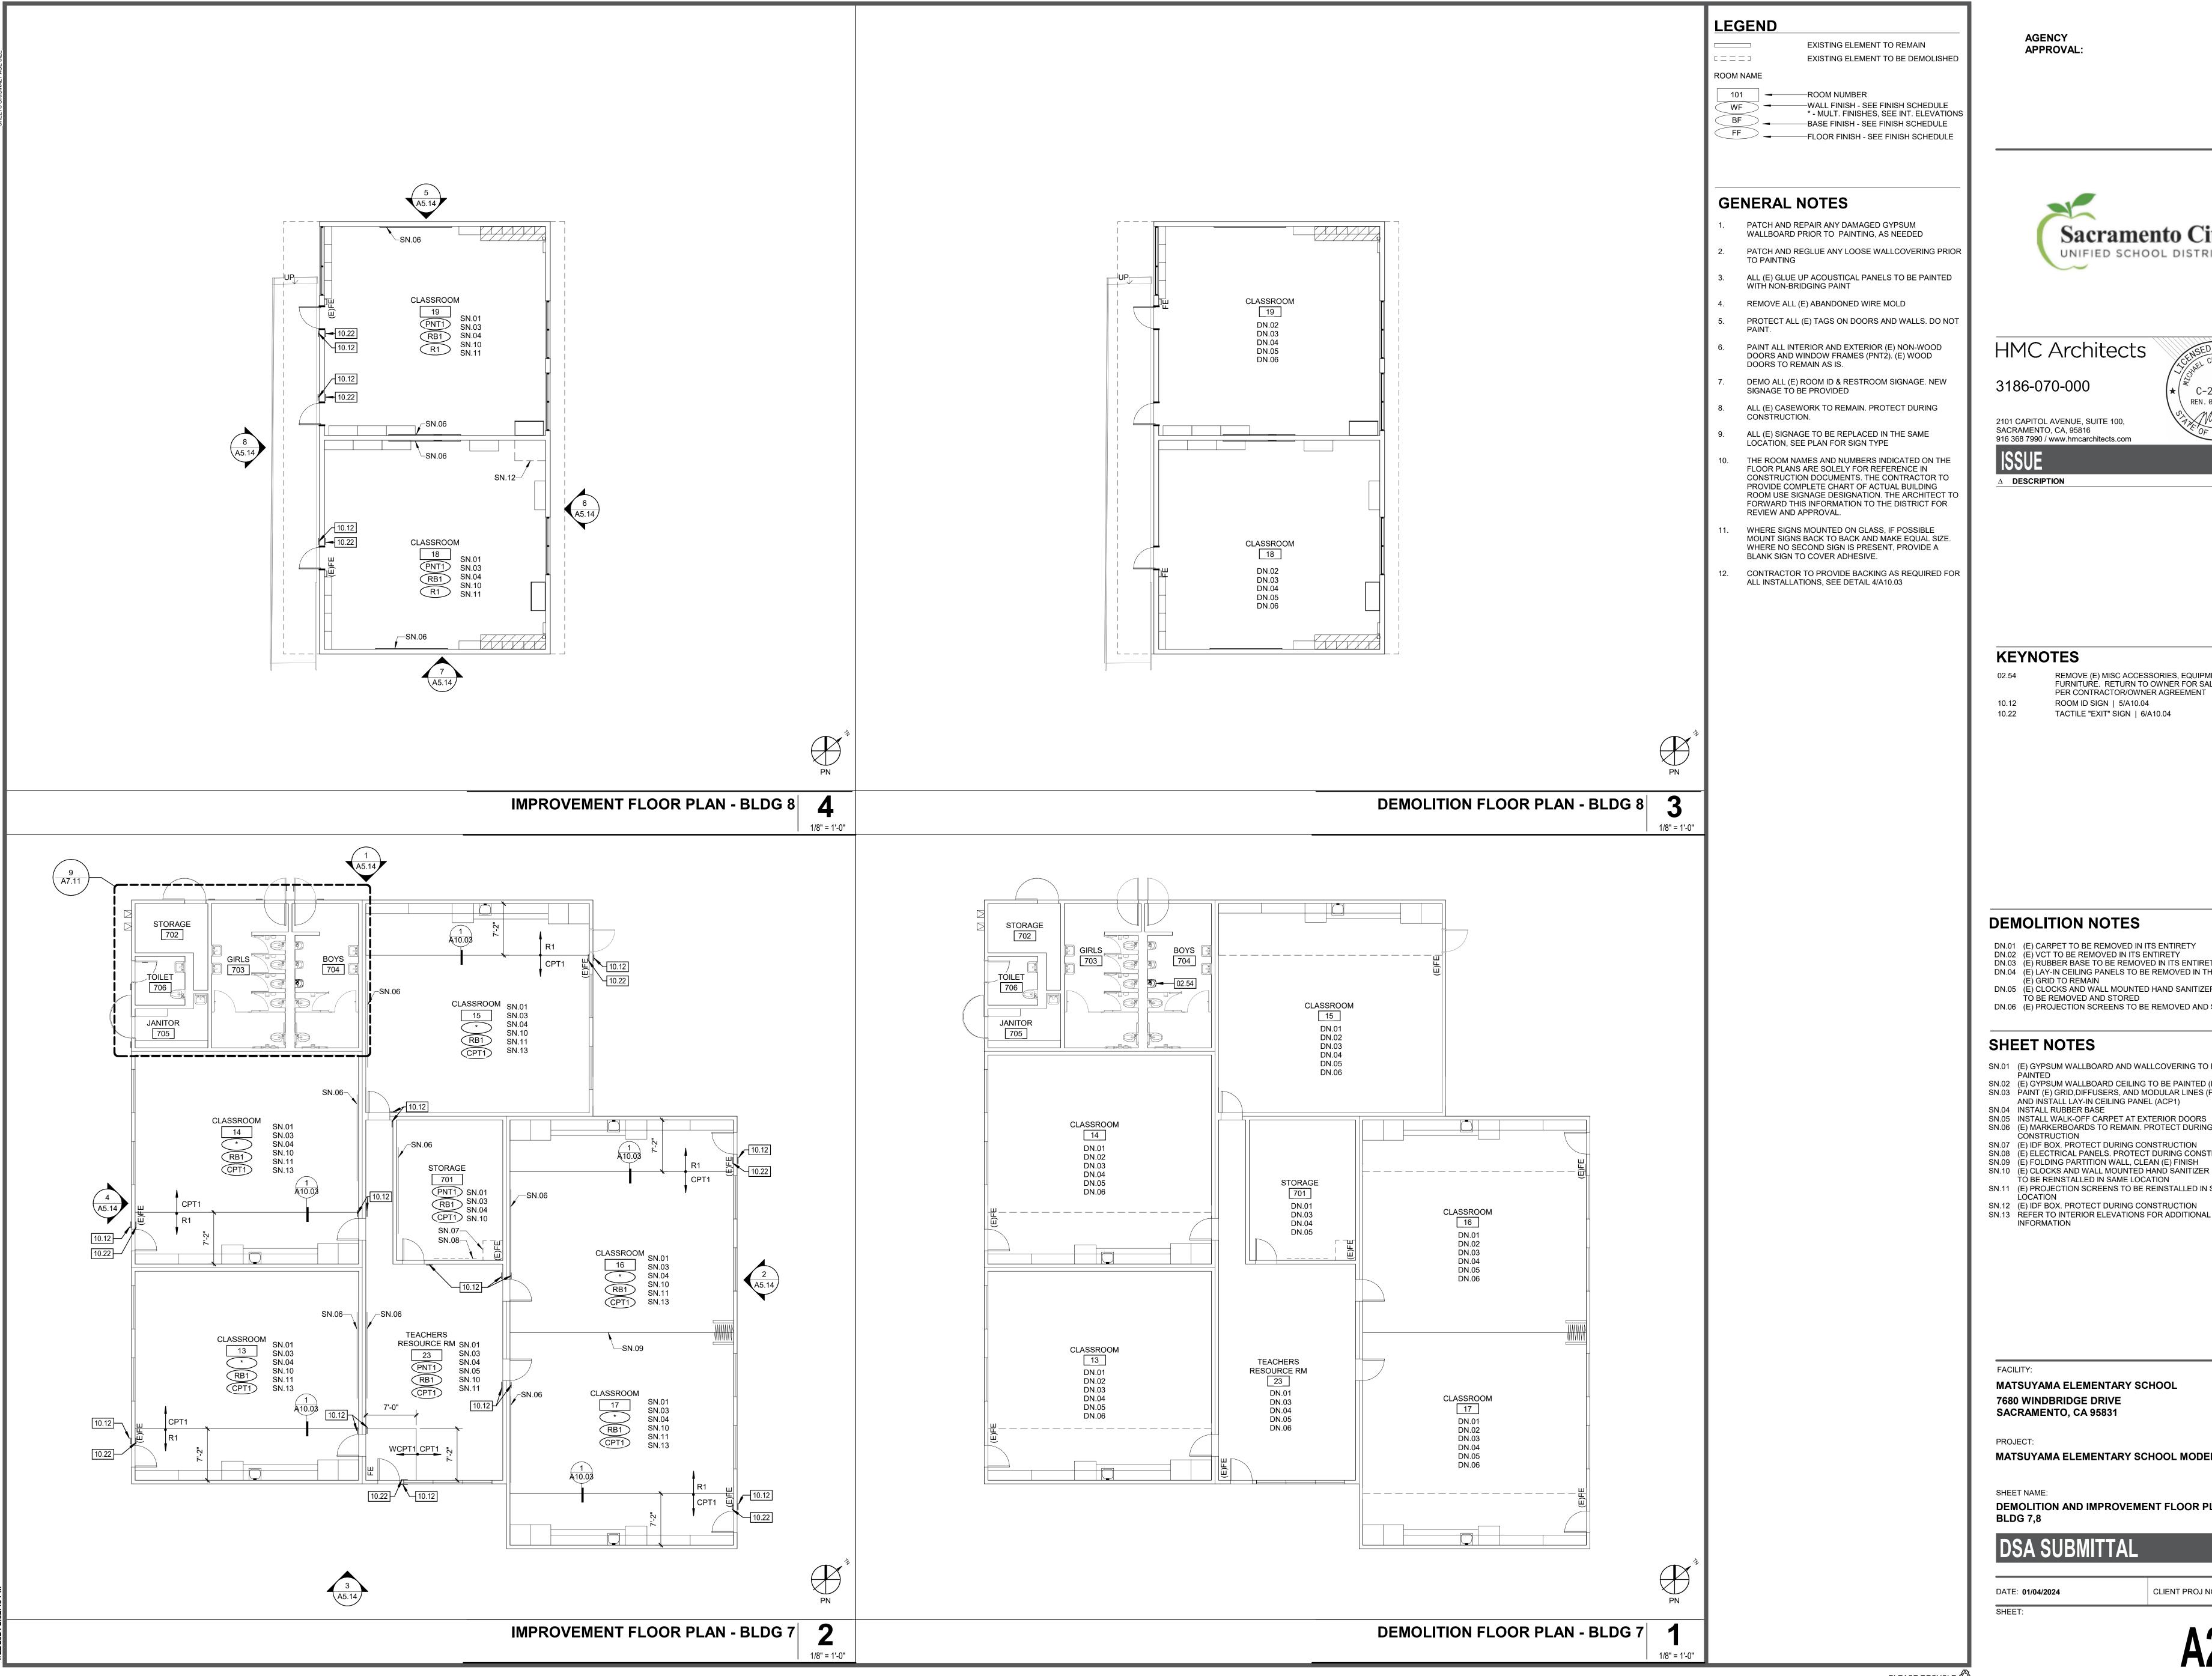KEYNOTES

REMOVE (E) MISC ACCESSORIES, EQUIPMENT & FURNITURE. RETURN TO OWNER FOR SALVAGE/REUSE PER CONTRACTOR/OWNER AGREEMENT

ROOM ID SIGN | 5/A10.04 TACTILE "EXIT" SIGN | 6/A10.04

DEMOLITION NOTES

DN.01 (E) CARPET TO BE REMOVED IN ITS ENTIRETY DN.02 (E) VCT TO BE REMOVED IN ITS ENTIRETY

DN.03 (E) RUBBER BASE TO BE REMOVED IN ITS ENTIRETY DN.04 (E) LAY-IN CEILING PANELS TO BE REMOVED IN THEIR ENTIRETY.

(E) GRID TO REMAIN DN.05 (E) CLOCKS AND WALL MOUNTED HAND SANITIZER DISPENSERS

TO BE REMOVED AND STORED DN.06 (E) PROJECTION SCREENS TO BE REMOVED AND STORED

SHEET NOTES

INFORMATION

SN.01 (E) GYPSUM WALLBOARD AND WALLCOVERING TO BE

SN.02 (E) GYPSUM WALLBOARD CEILING TO BE PAINTED (PNT1) SN.03 PÁINT (E) GRID, DIFFUSERS, AND MODULAR LINES (PNT1, U.N.O.) AND INSTALL LAY-IN CEILING PANEL (ACP1)

SN.04 INSTALL RUBBER BASE SN.05 INSTALL WALK-OFF CARPET AT EXTERIOR DOORS SN.06 (E) MARKERBOARDS TO REMAIN. PROTECT DURING

CONSTRUCTION

SN.07 (E) IDF BOX. PROTECT DURING CONSTRUCTION SN.08 (E) ELECTRICAL PANELS. PROTECT DURING CONSTRUCTION SN.09 (E) FOLDING PARTITION WALL, CLEAN (E) FINISH

SN.10 (E) CLOCKS AND WALL MOUNTED HAND SANITIZER DISPENSERS TÓ BE REINSTALLED IN SAME LOCATION


SN.11 (E) PROJECTION SCREENS TO BE REINSTALLED IN SAME SN.12 (E) IDF BOX. PROTECT DURING CONSTRUCTION

MATSUYAMA ELEMENTARY SCHOOL **7680 WINDBRIDGE DRIVE** SACRAMENTO, CA 95831

MATSUYAMA ELEMENTARY SCHOOL MODERNIZATION

DEMOLITION AND IMPROVEMENT FLOOR PLANS -

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UNIFIED SCHOOL DISTRICT
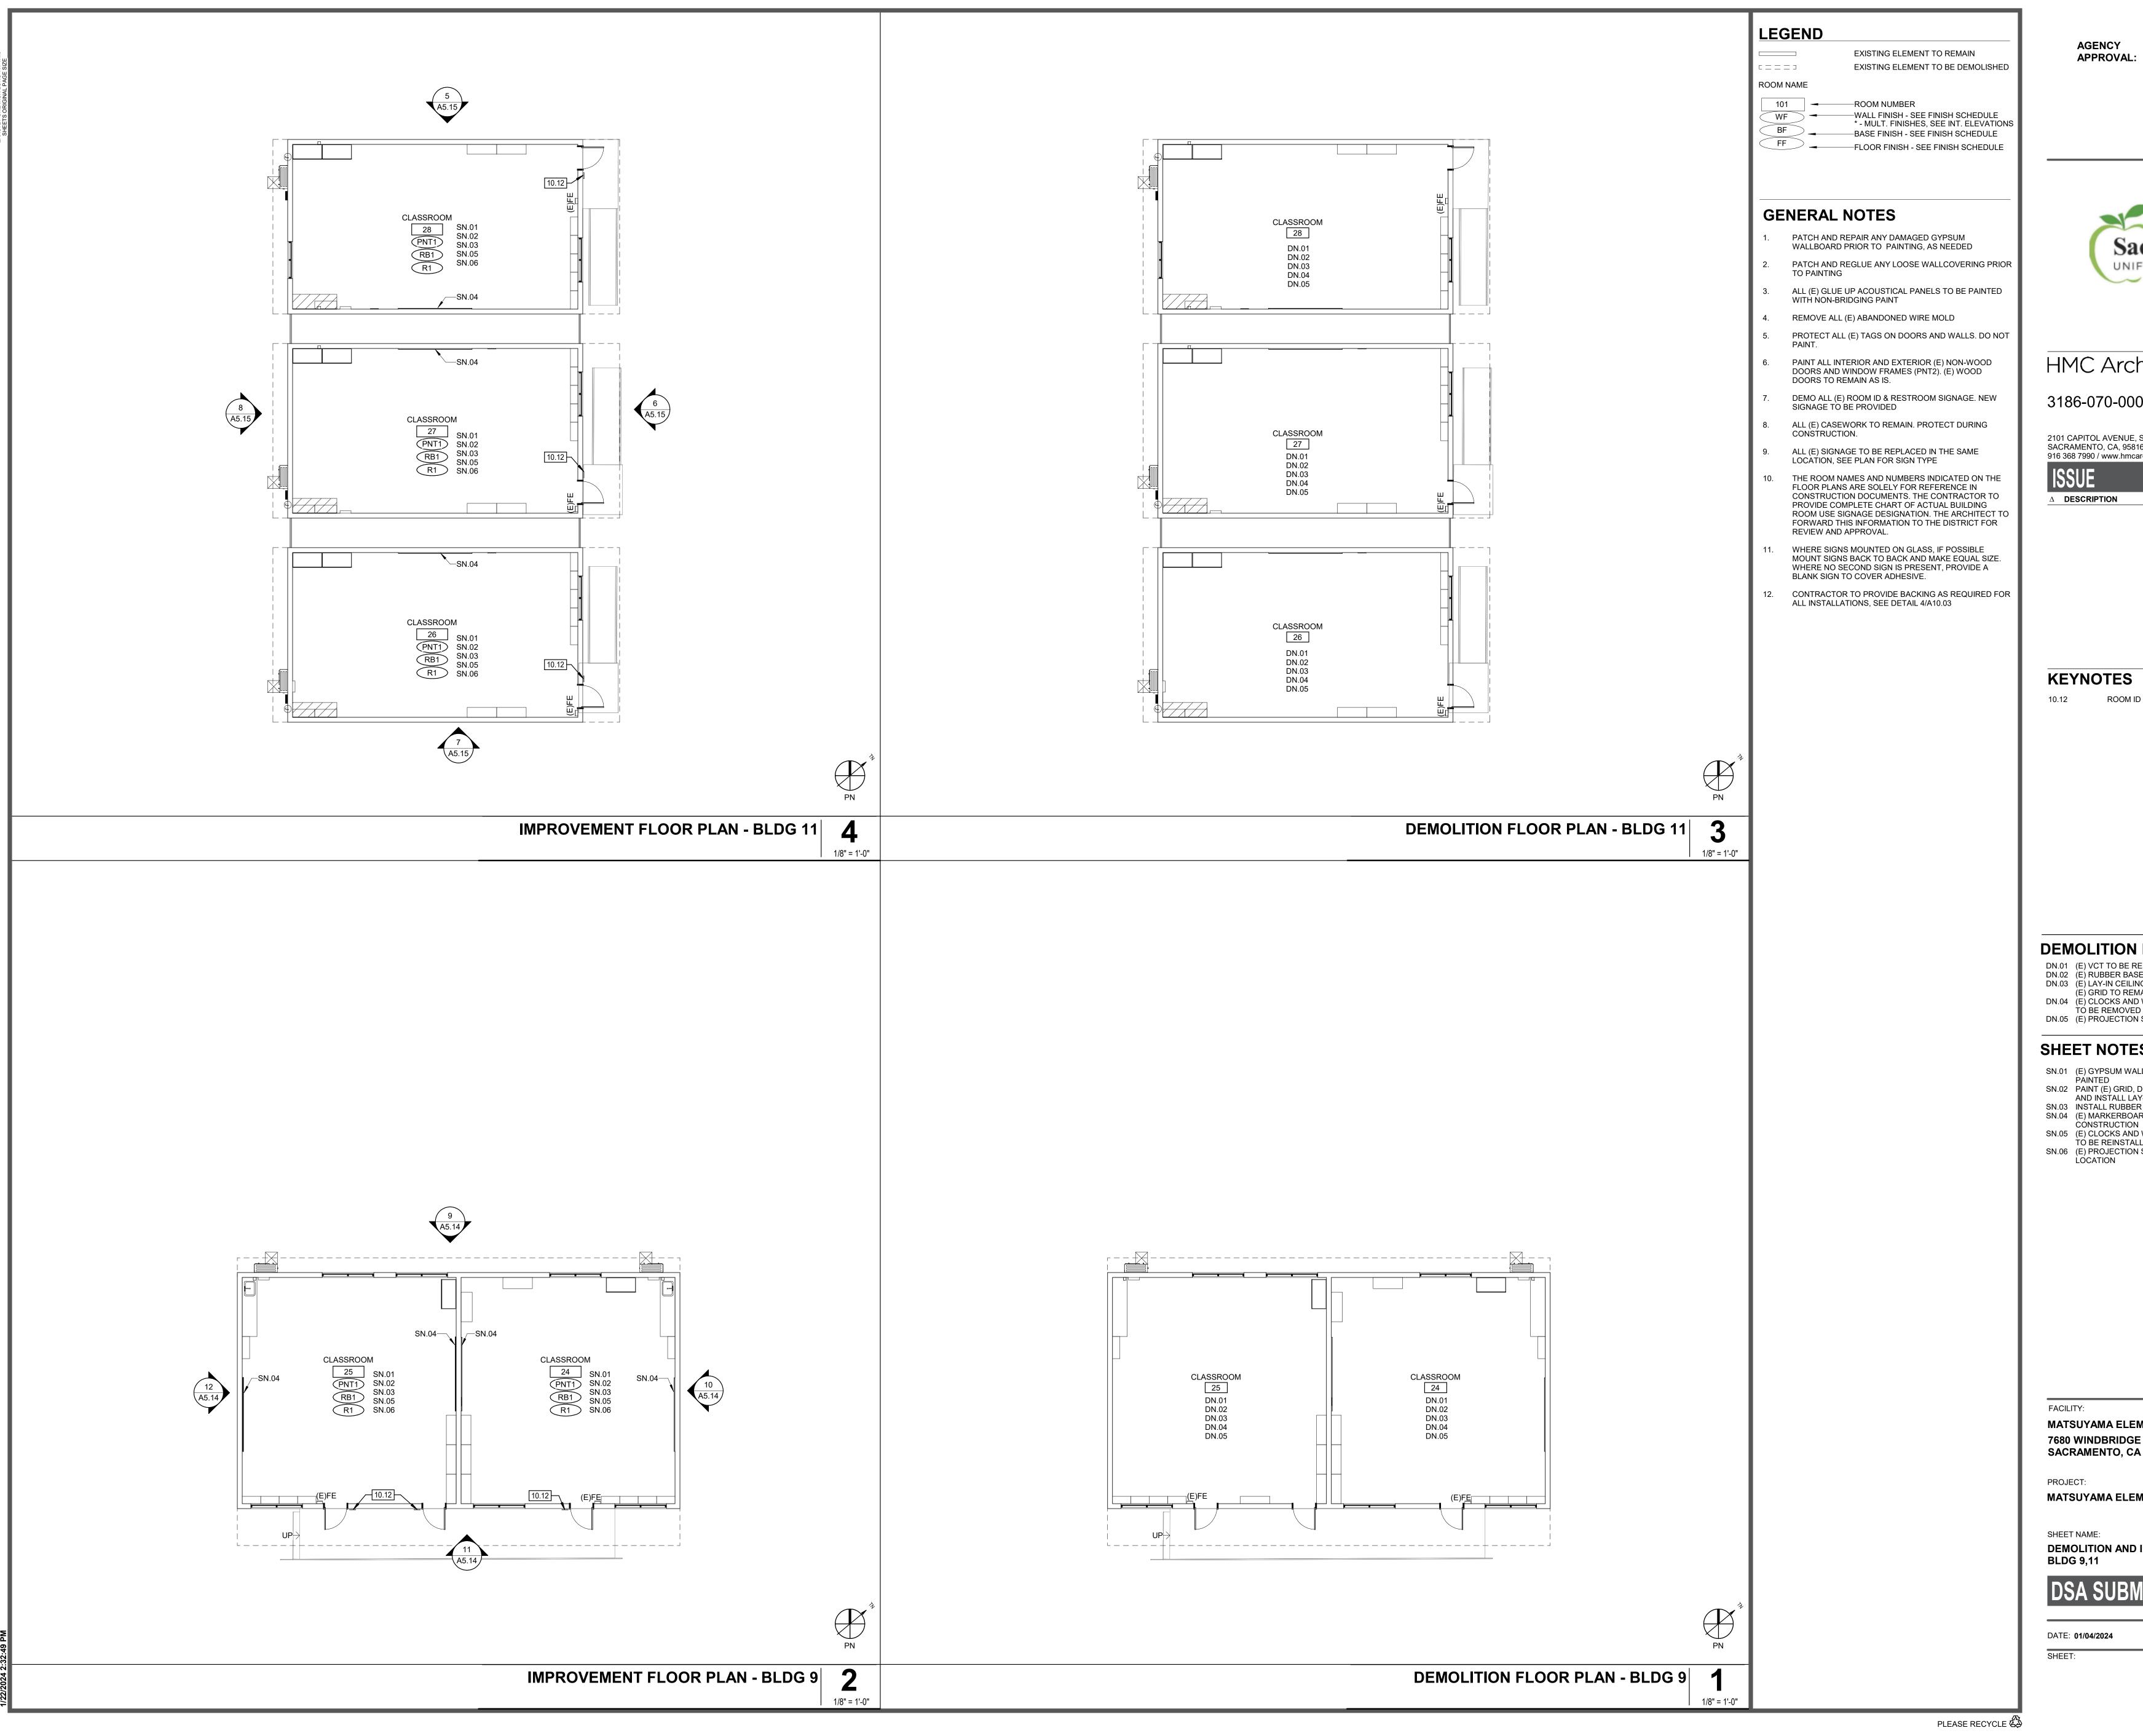
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DATE

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△ **DESCRIPTION**

KEYNOTES

10.12 ROOM ID SIGN | 5/A10.04

DEMOLITION NOTES

DN.01 (E) VCT TO BE REMOVED IN ITS ENTIRETY DN.02 (E) RUBBER BASE TO BE REMOVED IN ITS ENTIRETY DN.03 (E) LAY-IN CEILING PANELS TO BE REMOVED IN THEIR ENTIRETY. (E) GRID TO REMAIN

DN.04 (E) CLOCKS AND WALL MOUNTED HAND SANITIZER DISPENSERS TO BE REMOVED AND STORED DN.05 (E) PROJECTION SCREENS TO BE REMOVED AND STORED

SHEET NOTES

- SN.01 (E) GYPSUM WALLBOARD AND WALLCOVERING TO BE
- SN.02 PAINT (E) GRID, DIFFUSERS, AND MODULAR LINES (PNT1, U.N.O.)
 AND INSTALL LAY-IN CEILING PANEL (ACP1) SN.03 INSTALL RUBBER BASE
- SN.04 (E) MARKERBOARDS TO REMAIN. PROTECT DURING CÓNSTRUCTION
- SN.05 (E) CLOCKS AND WALL MOUNTED HAND SANITIZER DISPENSERS TÓ BE REINSTALLED IN SAME LOCATION

SN.06 (E) PROJECTION SCREENS TO BE REINSTALLED IN SAME LÓCATION

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MATSUYAMA ELEMENTARY SCHOOL MODERNIZATION

DEMOLITION AND IMPROVEMENT FLOOR PLANS -

DSA SUBMITTAL



UNIFIED SCHOOL DISTRICT

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DATE

KEYNOTES

(E) LIGHT FIXTURES TO REMAIN; PROTECT IN PLACE DEMOLISH PORTION OF (E) CEILING AS REQUIRED FOR IMPROVEMENT | REMODEL PLAN

REMOVE (E) LIGHT FIXTURE | ELEC REMOVE (E) KITCHEN HOOD


SEE FLOOR PLANS FOR CEILING REPAIR INFORMATION SEE MECHANICAL DRAWINGS FOR MECHANICAL SCOPE 3. SEE ELECTRICAL DRAWINGS FOR ELECTRICAL SCOPE

MATSUYAMA ELEMENTARY SCHOOL 7680 WINDBRIDGE DRIVE SACRAMENTO, CA 95831

MATSUYAMA ELEMENTARY SCHOOL MODERNIZATION

DEMOLITION REFLECTED CEILING PLAN - BLDG A,B

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Sacramento City
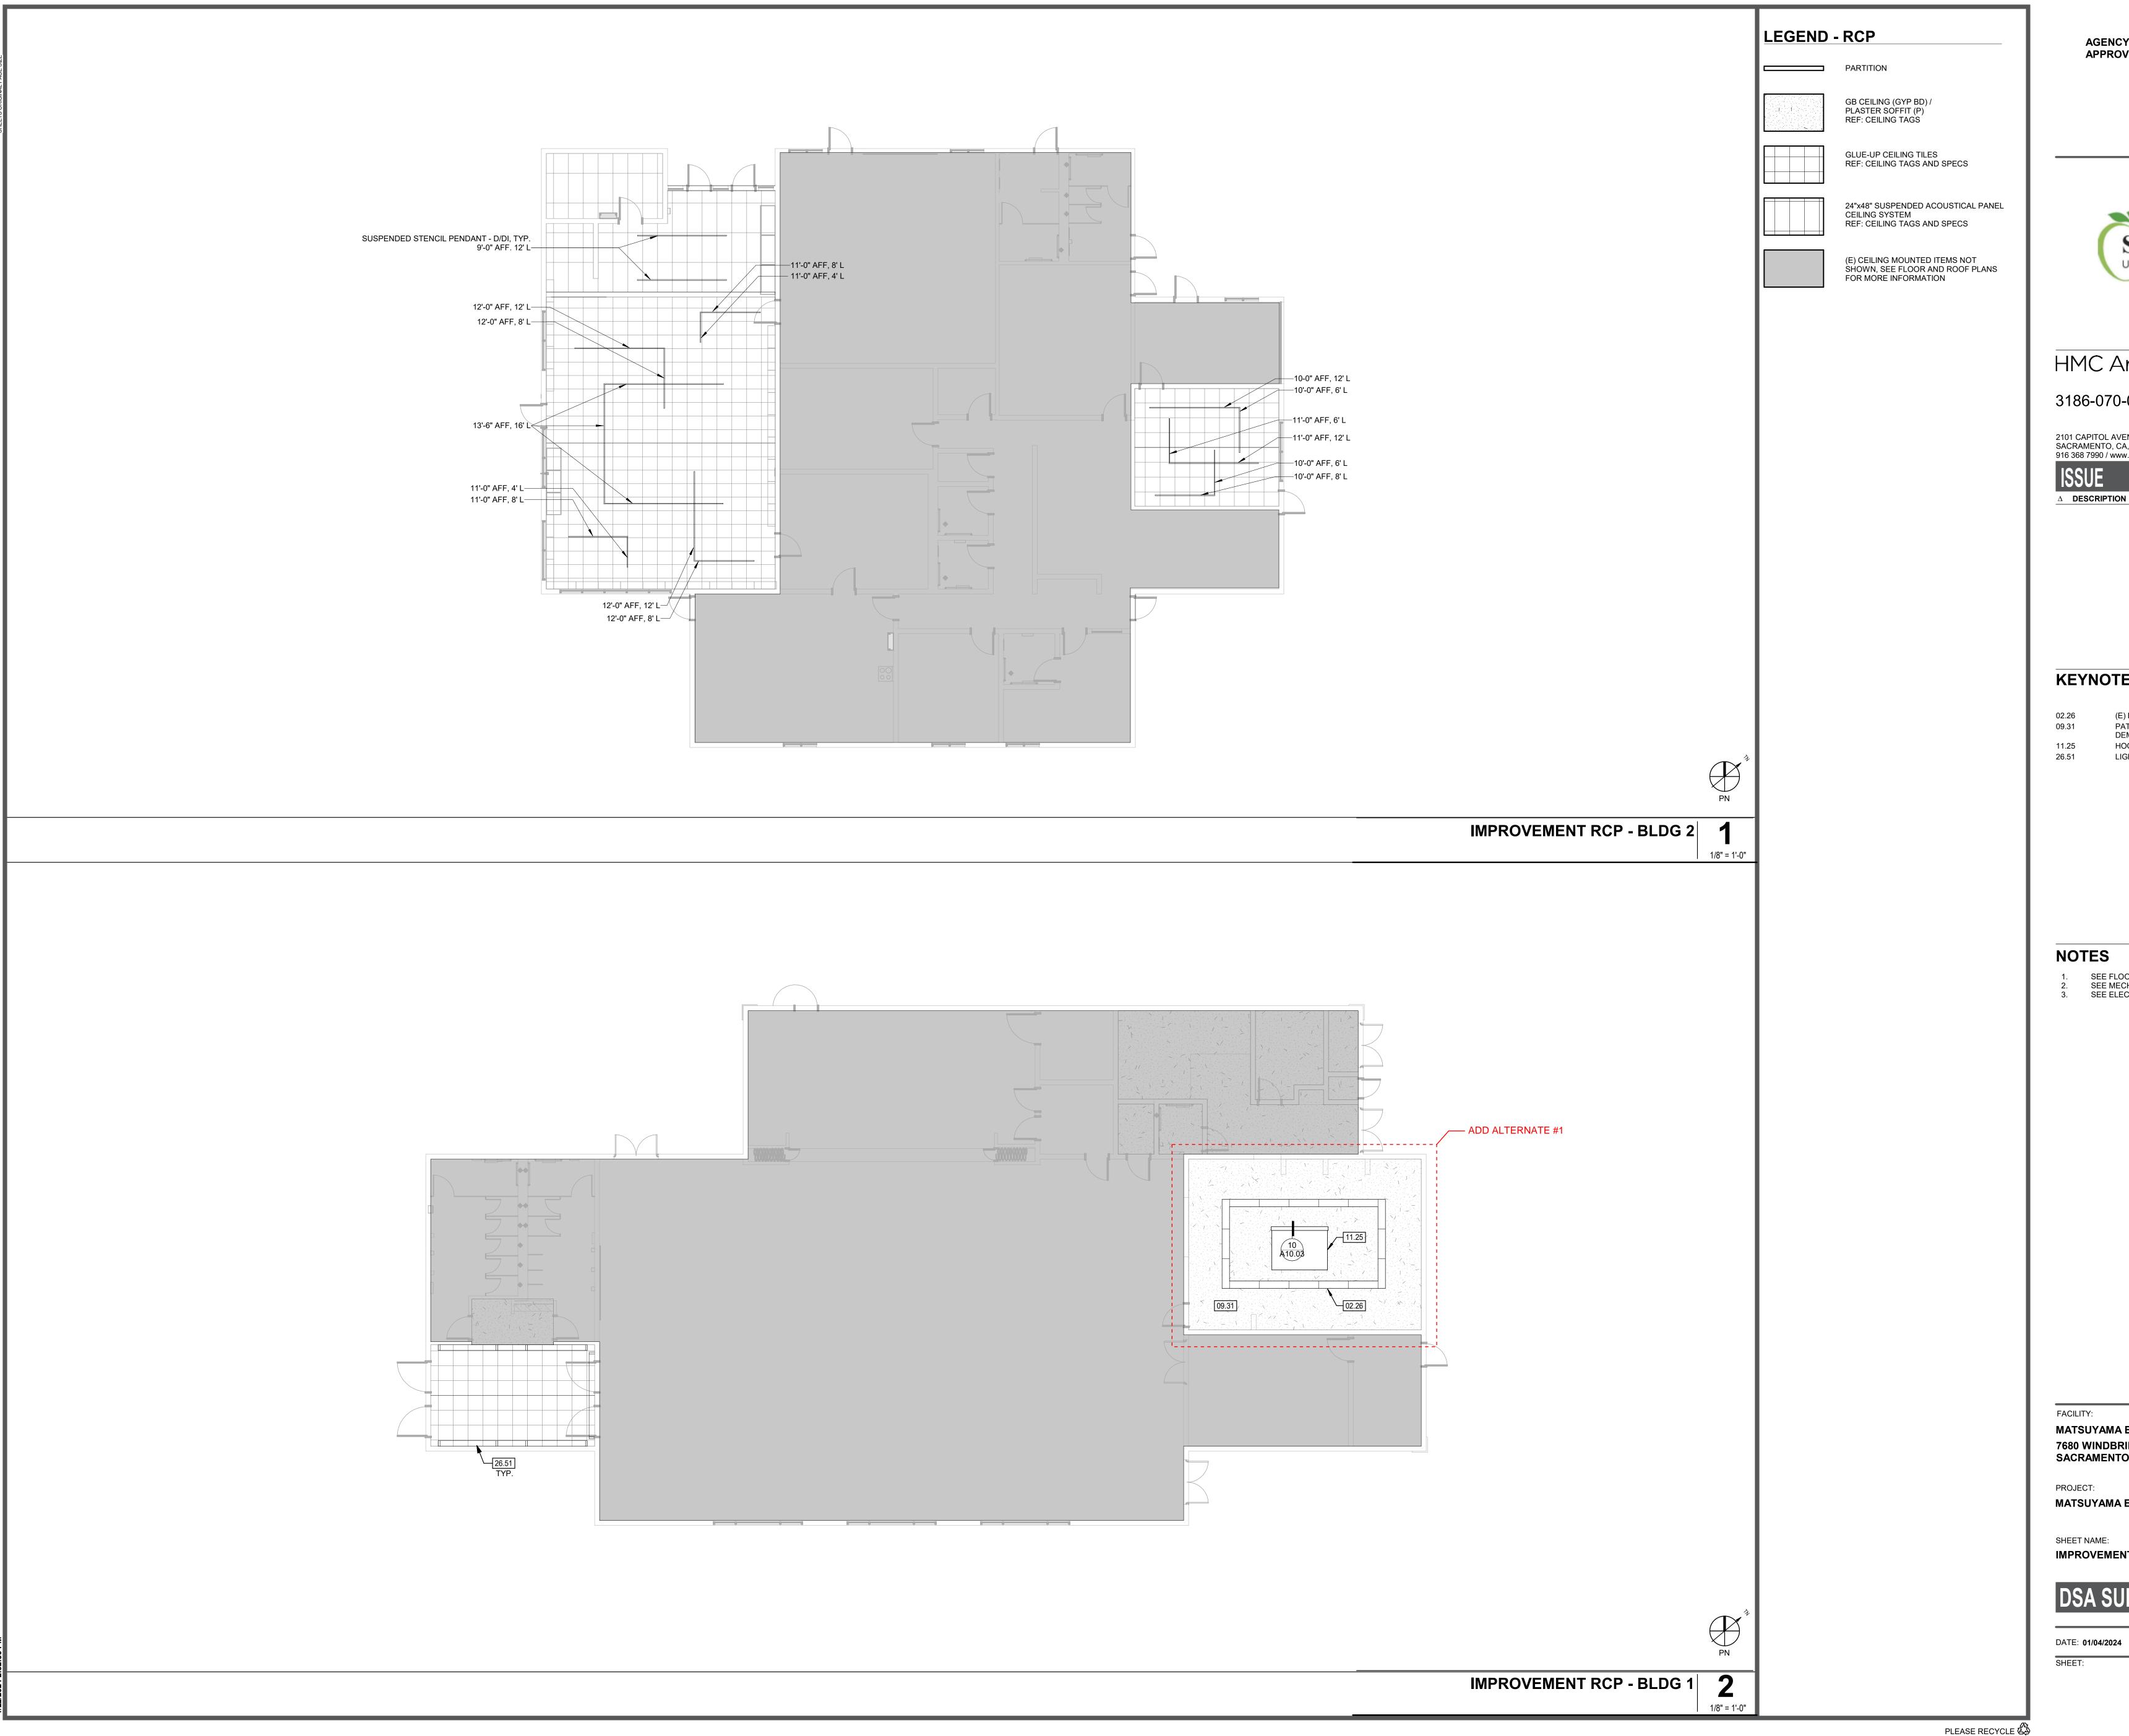
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KEYNOTES

(E) LIGHT FIXTURES TO REMAIN; PROTECT IN PLACE PATCH AND REPAIR (E) GYP CEILING AFTER PARTIAL DEMOLITION

HOOD, SEE FOODSERVICE DRAWINGS LIGHT FIXTURE | ELEC


SEE FLOOR PLANS FOR CEILING REPAIR INFORMATION SEE MECHANICAL DRAWINGS FOR MECHANICAL SCOPE 3. SEE ELECTRICAL DRAWINGS FOR ELECTRICAL SCOPE

MATSUYAMA ELEMENTARY SCHOOL 7680 WINDBRIDGE DRIVE SACRAMENTO, CA 95831

MATSUYAMA ELEMENTARY SCHOOL MODERNIZATION

IMPROVEMENT REFLECTED CEILING PLAN - BLDG A,B


DSA SUBMITTAL

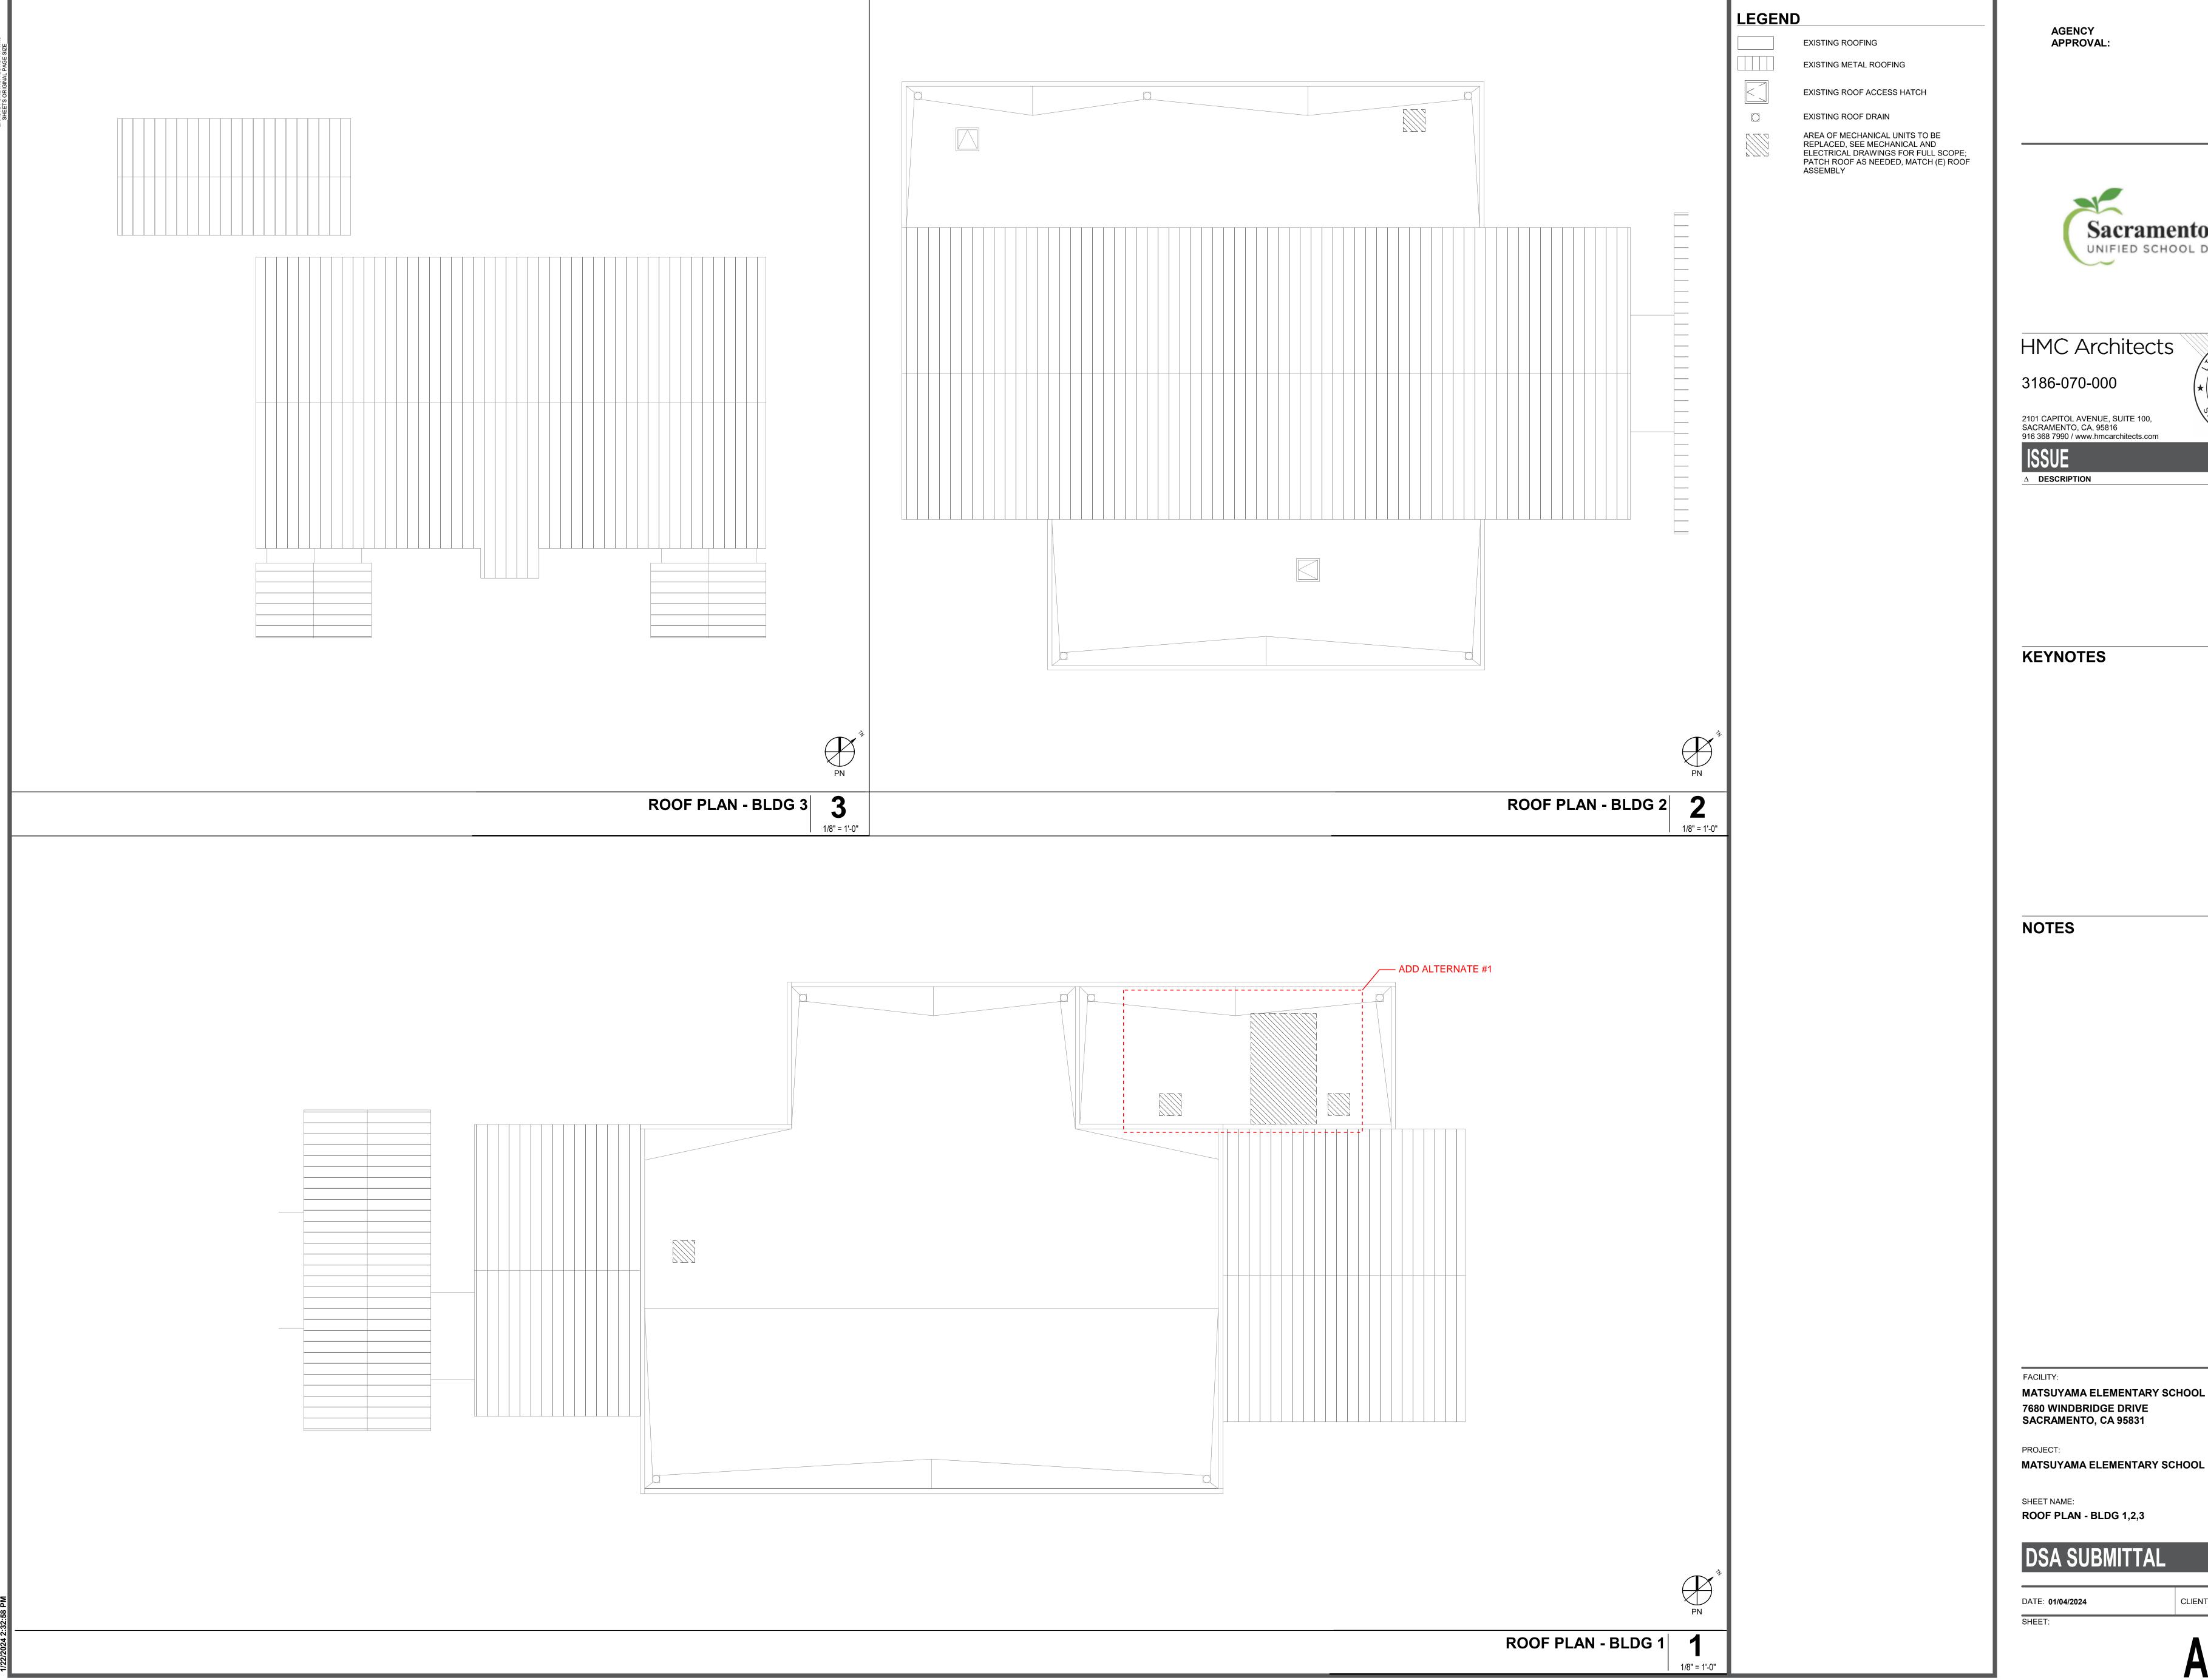

PLEASE RECYCLE 😂

DATE

MATSUYAMA ELEMENTARY SCHOOL MODERNIZATION

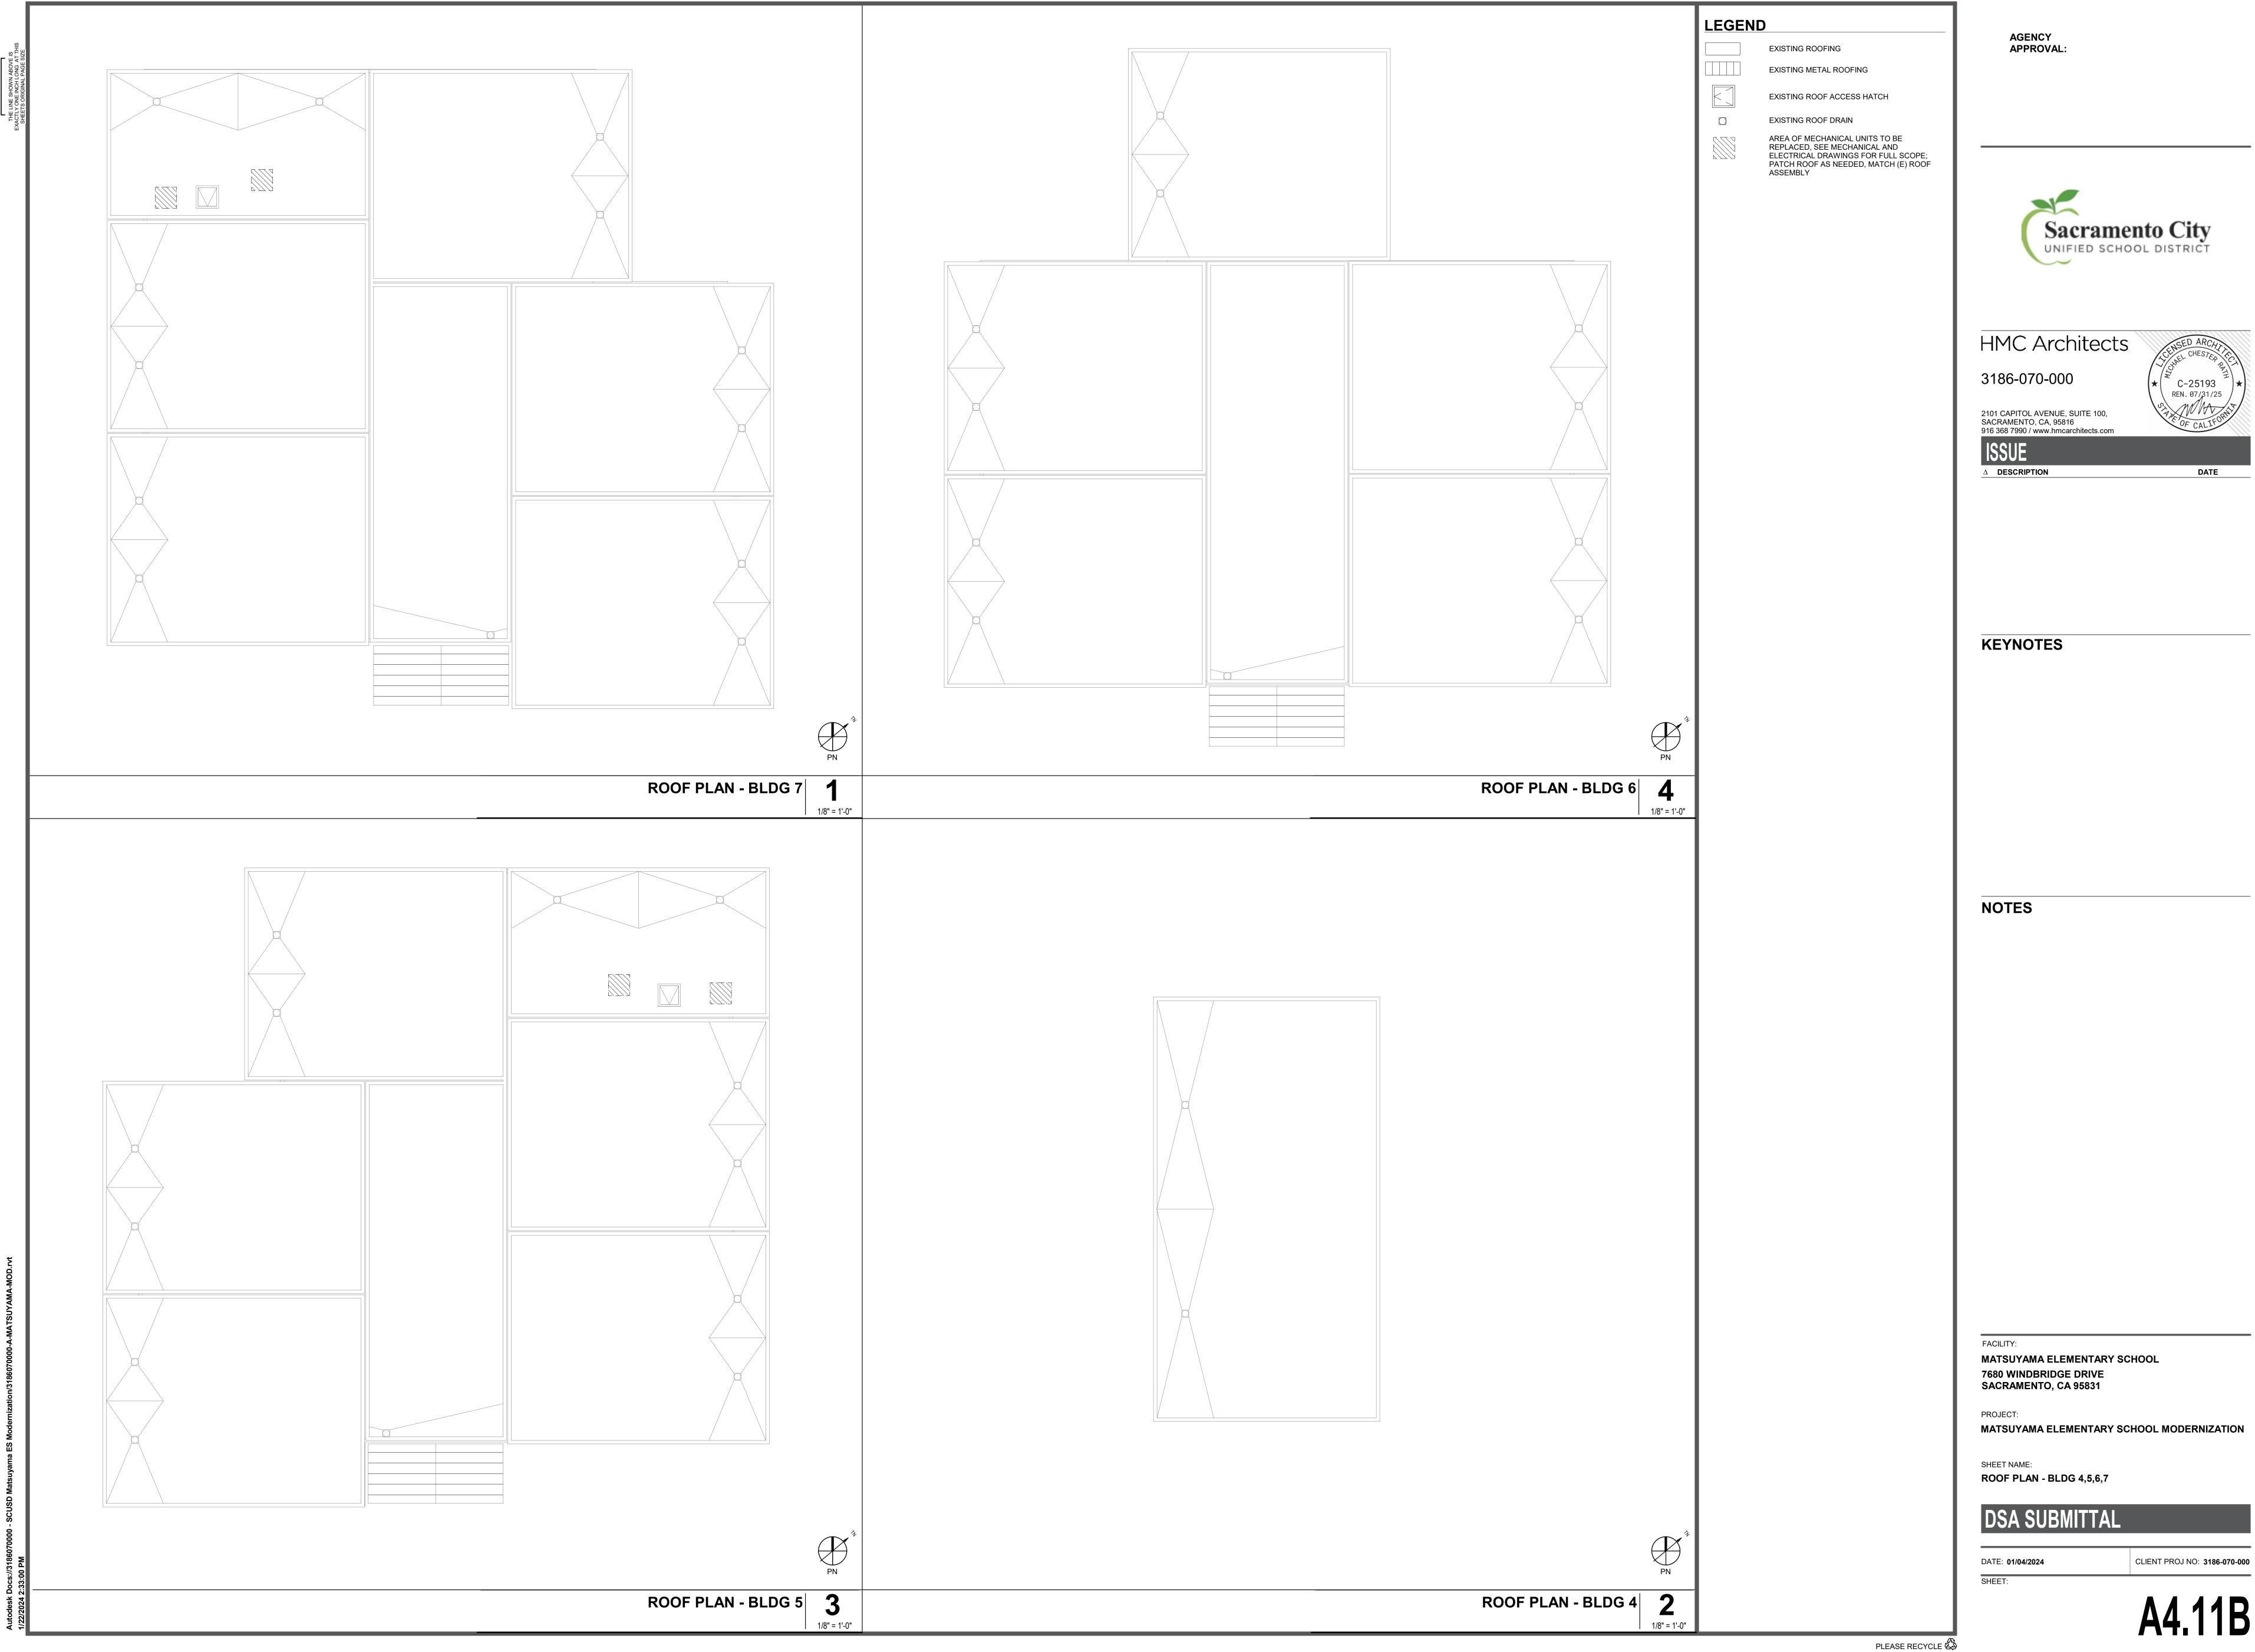





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△ **DESCRIPTION**

GENERAL NOTES

1. POWER WASH ALL (E) METAL ROOFING

SHEET NOTES

SN.01 DEEP CLEAN GROUT & TILE, AND PATCH GROUT AS NEEDED

LEGEND

M - METAL PL - PLASTER EPNT 1

EPNT 2

EPNT 3 EPNT 4

EPNT 6

PLEASE RECYCLE


MATSUYAMA ELEMENTARY SCHOOL 7680 WINDBRIDGE DRIVE SACRAMENTO, CA 95831

MATSUYAMA ELEMENTARY SCHOOL MODERNIZATION

EXTERIOR ELEVATIONS

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EXTERIOR ELEVATION - BUILDING 4 10

EPNT 4

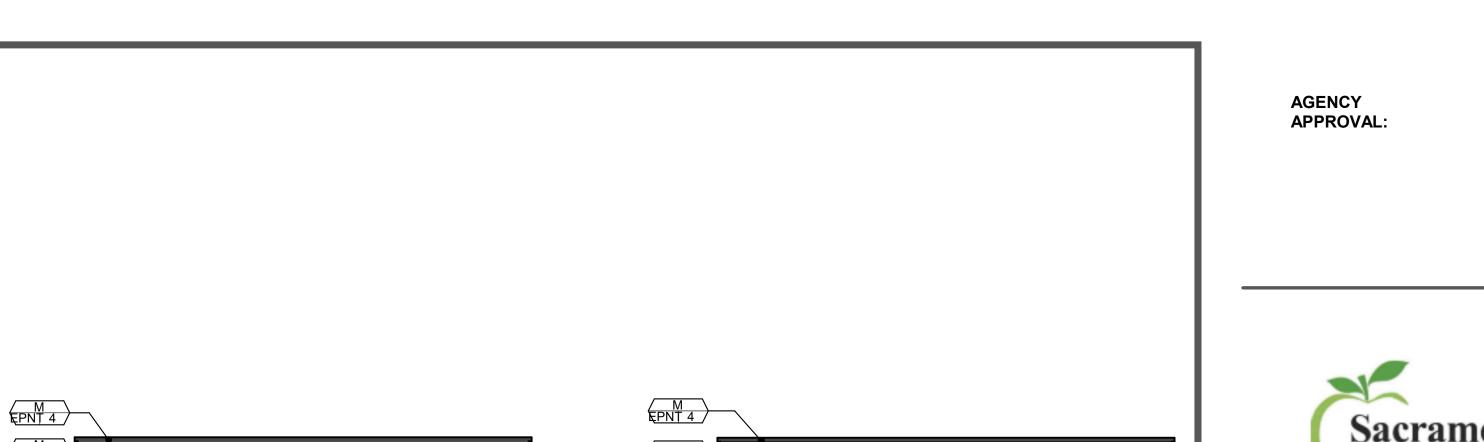EXTERIOR ELEVATION - BUILDING 3



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ISSUE

△ **DESCRIPTION**

GENERAL NOTES

1. POWER WASH ALL (E) METAL ROOFING

KEYNOTES

REMOVE THE (E) METAL LETTERS AND REPLACE IN KIND

SHEET NOTES

SN.01 DEEP CLEAN GROUT & TILE, AND PATCH GROUT AS NEEDED (EGR1)

LEGEND

M - METAL PL - PLASTER

EPNT 1

EPNT 2 EPNT 3

EPNT 4 EPNT 5

EPNT 6

EPNT 4

EPNT 5

PL EPNT 1 PL EPNT 1 PL EPNT 1 **EXTERIOR ELEVATION - BUILDING 3**

EXTERIOR ELEVATION - BUILDING 4 13

CANOPY 14

EPNT 4

EPNT 1

EPNT 3 EPNT 4 PL EPNT 2 KINDERGARTEN

EXTERIOR ELEVATION - BUILDING 3

EXTERIOR ELEVATION - BUILDING 3

EXTERIOR ELEVATION - BUILDING 4 12

02.51 (16) (A10.04)

6

1/8" = 1'-0"

EXTERIOR ELEVATION - BUILDING 4 11

SIM. SIM. PL EPNT 1

EXTERIOR ELEVATION - BUILDING 3

PL EPNT 2

SN.01, TYP.


EXTERIOR ELEVATION - CANOPY 4


CANOPY 15

12" = 1'-0"

EPNT 4 PL EPNT 2 EPNT 3
TYP

EXTERIOR ELEVATION - CANOPY 3

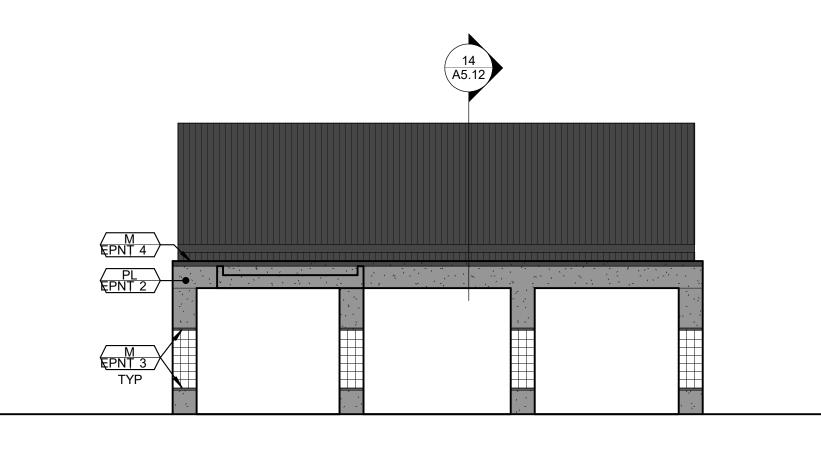

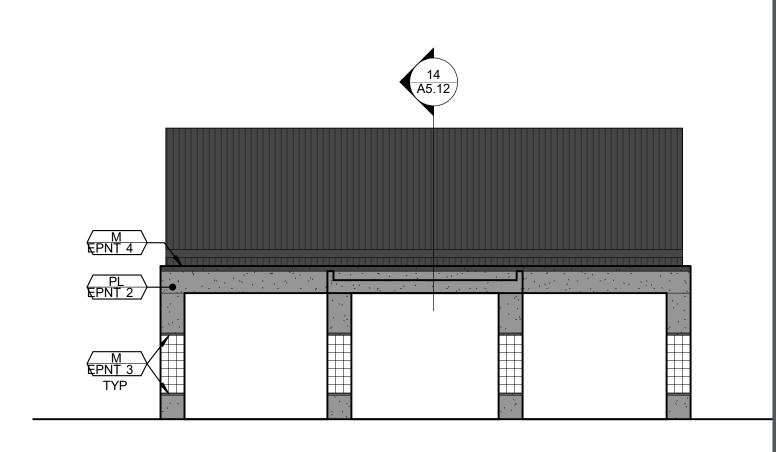

EXTERIOR ELEVATION - CANOPY 2 **EXTERIOR ELEVATION - CANOPY**


MATSUYAMA ELEMENTARY SCHOOL 7680 WINDBRIDGE DRIVE SACRAMENTO, CA 95831

MATSUYAMA ELEMENTARY SCHOOL MODERNIZATION

EXTERIOR ELEVATIONS

DSA SUBMITTAL

CLIENT PROJ NO: 3186-070-000 DATE: 01/04/2024

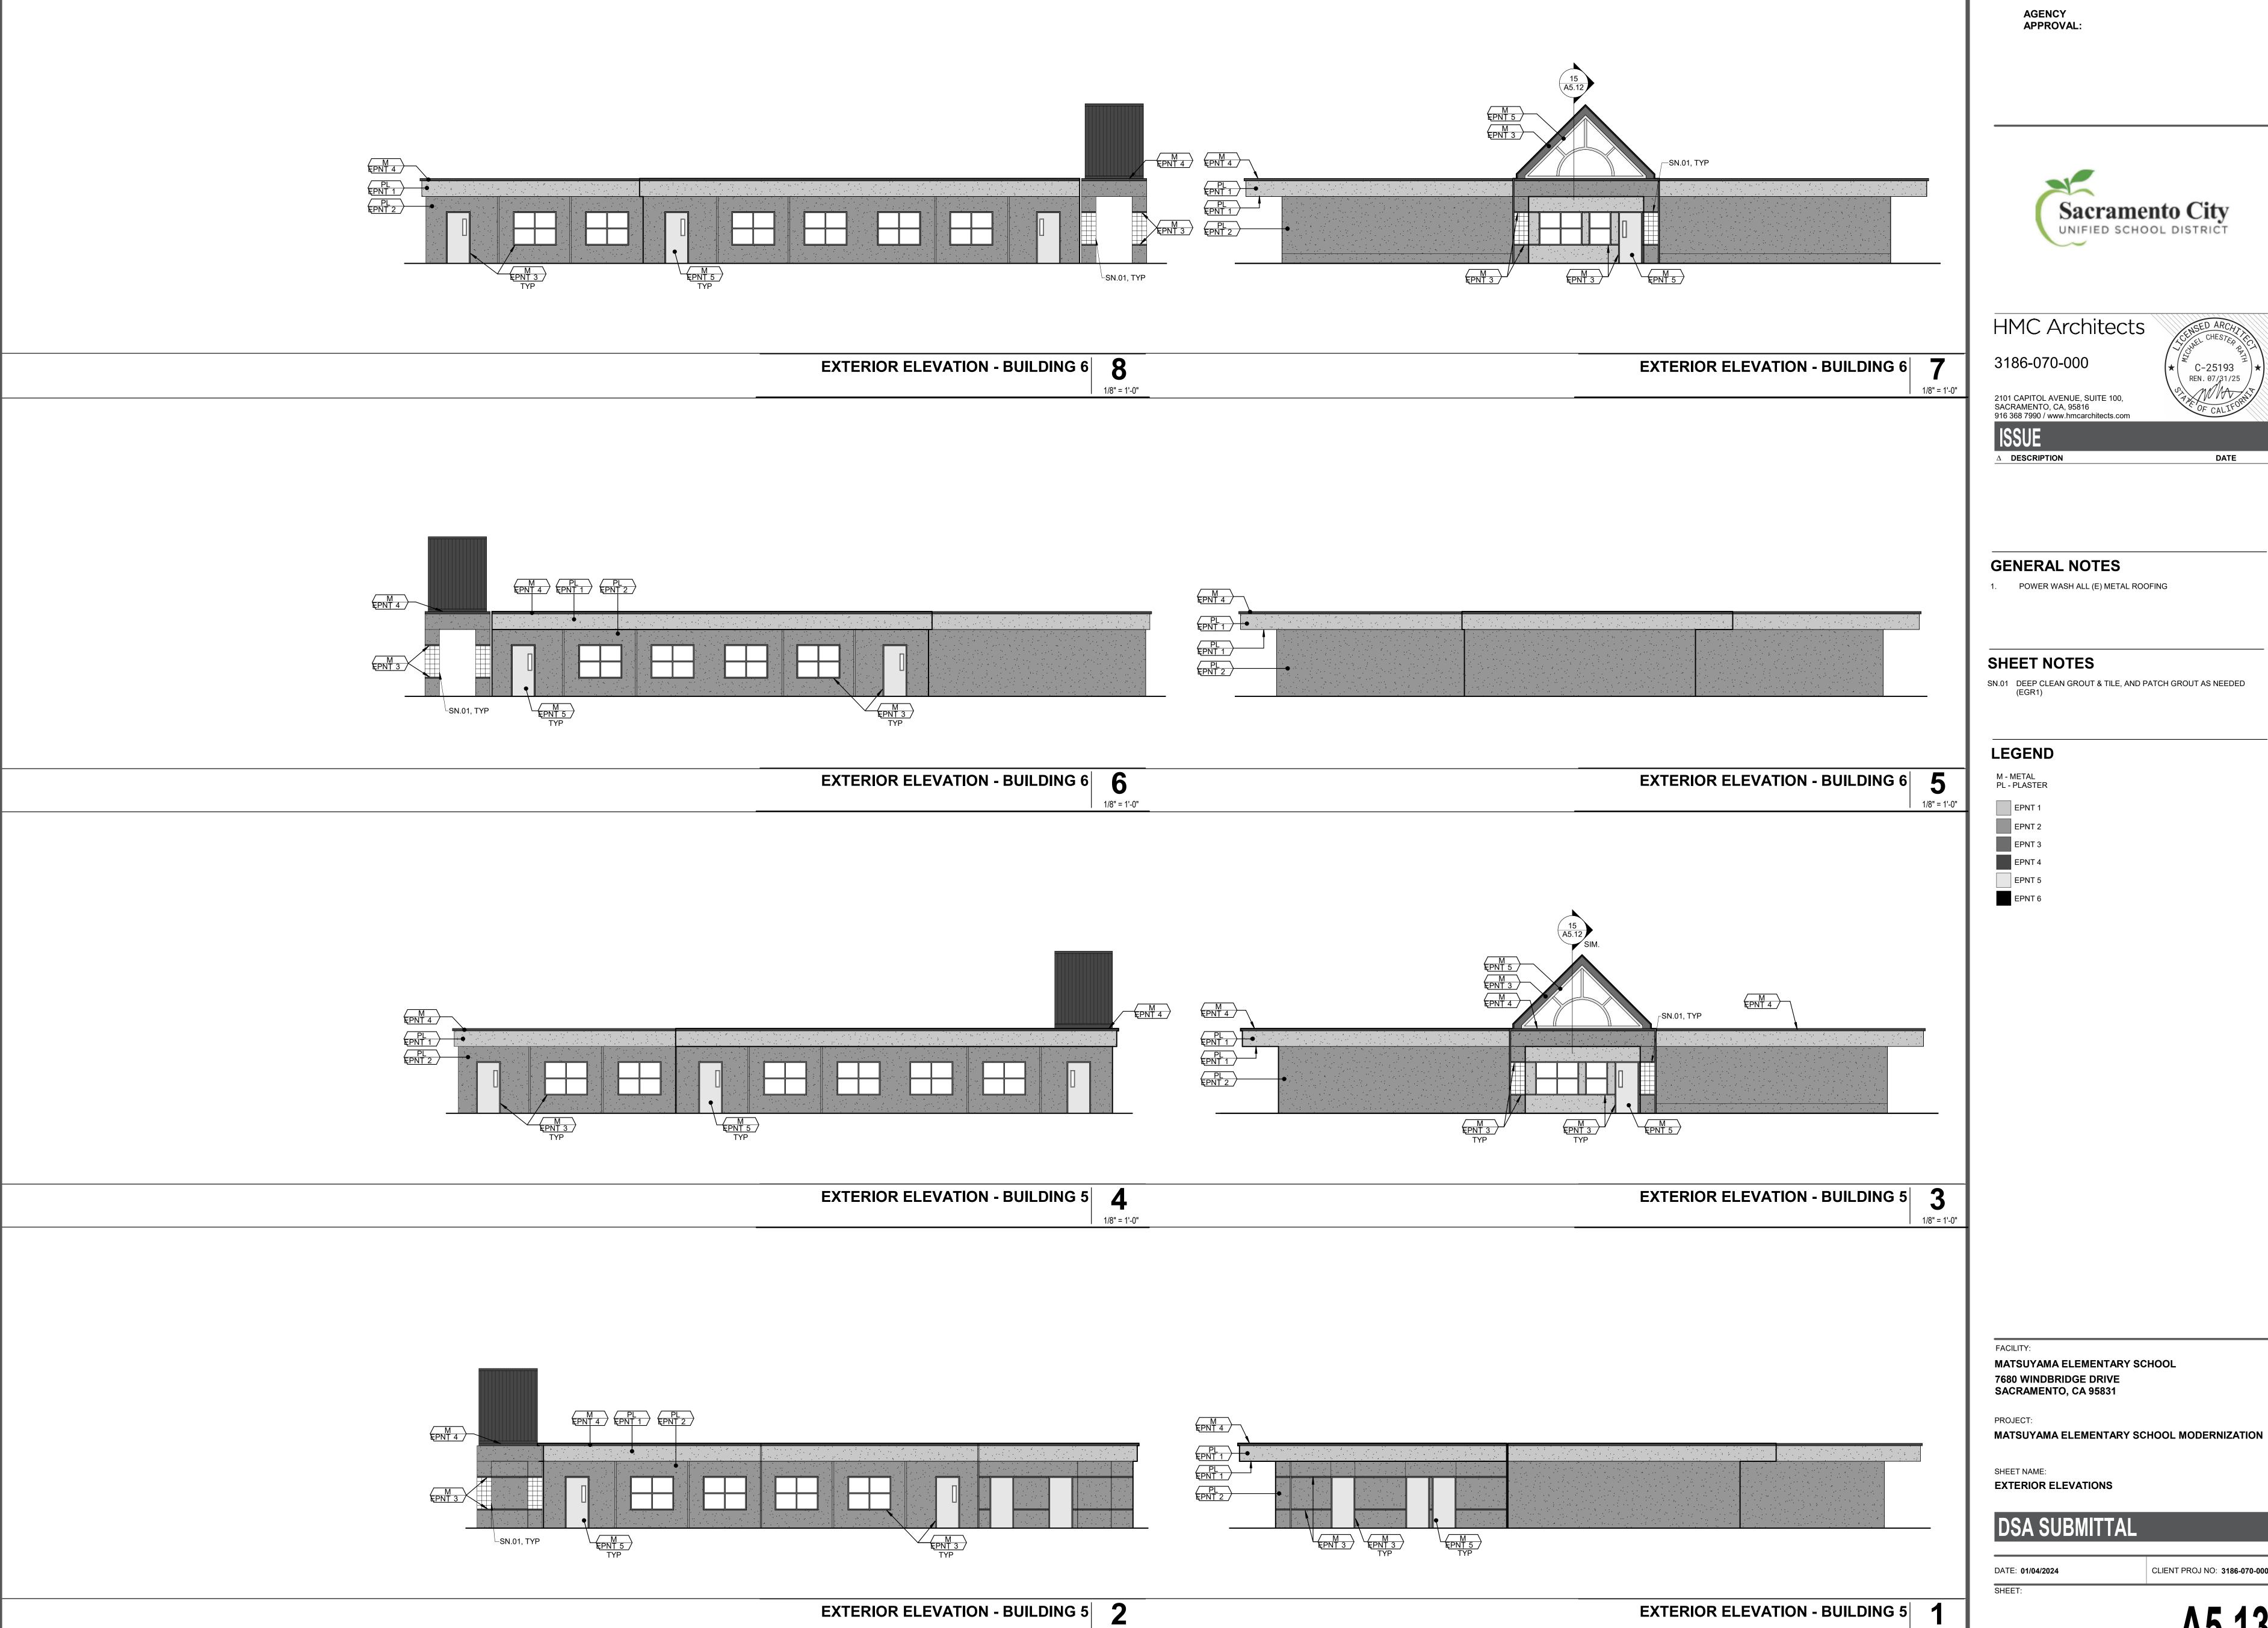

PLEASE RECYCLE

EXTERIOR ELEVATION - BUILDING 7



DATE

SN.03 DO NOT PAINT THE WINDOW SECURITY ROLL DOWNS AND THEIR HOUSING
SN.04 DEEP CLEAN GROUT & TILE, AND PATCH GROUT AS NEEDED (EGR1)

MATSUYAMA ELEMENTARY SCHOOL

EXTERIOR ELEVATION - BUILDING 7

PLEASE RECYCLE 😂


MATSUYAMA ELEMENTARY SCHOOL MODERNIZATION

AGENCY APPROVAL: Sacramento City HMC Architects 3186-070-000 2101 CAPITOL AVENUE, SUITE 100, SACRAMENTO, CA, 95816 916 368 7990 / www.hmcarchitects.com Δ **DESCRIPTION** DATE **GENERAL NOTES** 1. POWER WASH ALL (E) METAL ROOFING SHEET NOTES SN.01 DO NOT PAINT BARD UNITS SN.02 DO NOT PAINT OVER ANY BUILDING TAGS SN.03 DO NOT PAINT THE WINDOW SECURITY ROLL DOWNS AND THEIR HOUSING EPNT 3 SN.03 **LEGEND** EXTERIOR ELEVATION - BUILDING 11 8 **EXTERIOR ELEVATION - BUILDING 11** M - METAL PL - PLASTER 1/8" = 1'-0" EPNT 1 EPNT 2 EPNT 3 EPNT 4 EPNT 5 EPNT 6 EXTERIOR ELEVATION - BUILDING 11 6 5 **EXTERIOR ELEVATION - BUILDING 11** 1/8" = 1'-0" 1/8" = 1'-0" MATSUYAMA ELEMENTARY SCHOOL 7680 WINDBRIDGE DRIVE SACRAMENTO, CA 95831 M EPNT 4 M EPNT 1 M EPNT 2 SN.02 ┌─SN.01, TYP EPNT 4

M
EPNT 2

SN.02 M EPNT 4 M EPNT 2 SN.02 MATSUYAMA ELEMENTARY SCHOOL MODERNIZATION SHEET NAME: **EXTERIOR ELEVATIONS** EPNT 6 EPNT 5 DSA SUBMITTAL DATE: **01/04/2024** CLIENT PROJ NO: 3186-070-000 BLDG 10 SOUTH 3 BLDG 10 EAST 2 1/8" = 1'-0" BLDG 10 NORTH BLDG 10 WEST 4

PLEASE RECYCLE

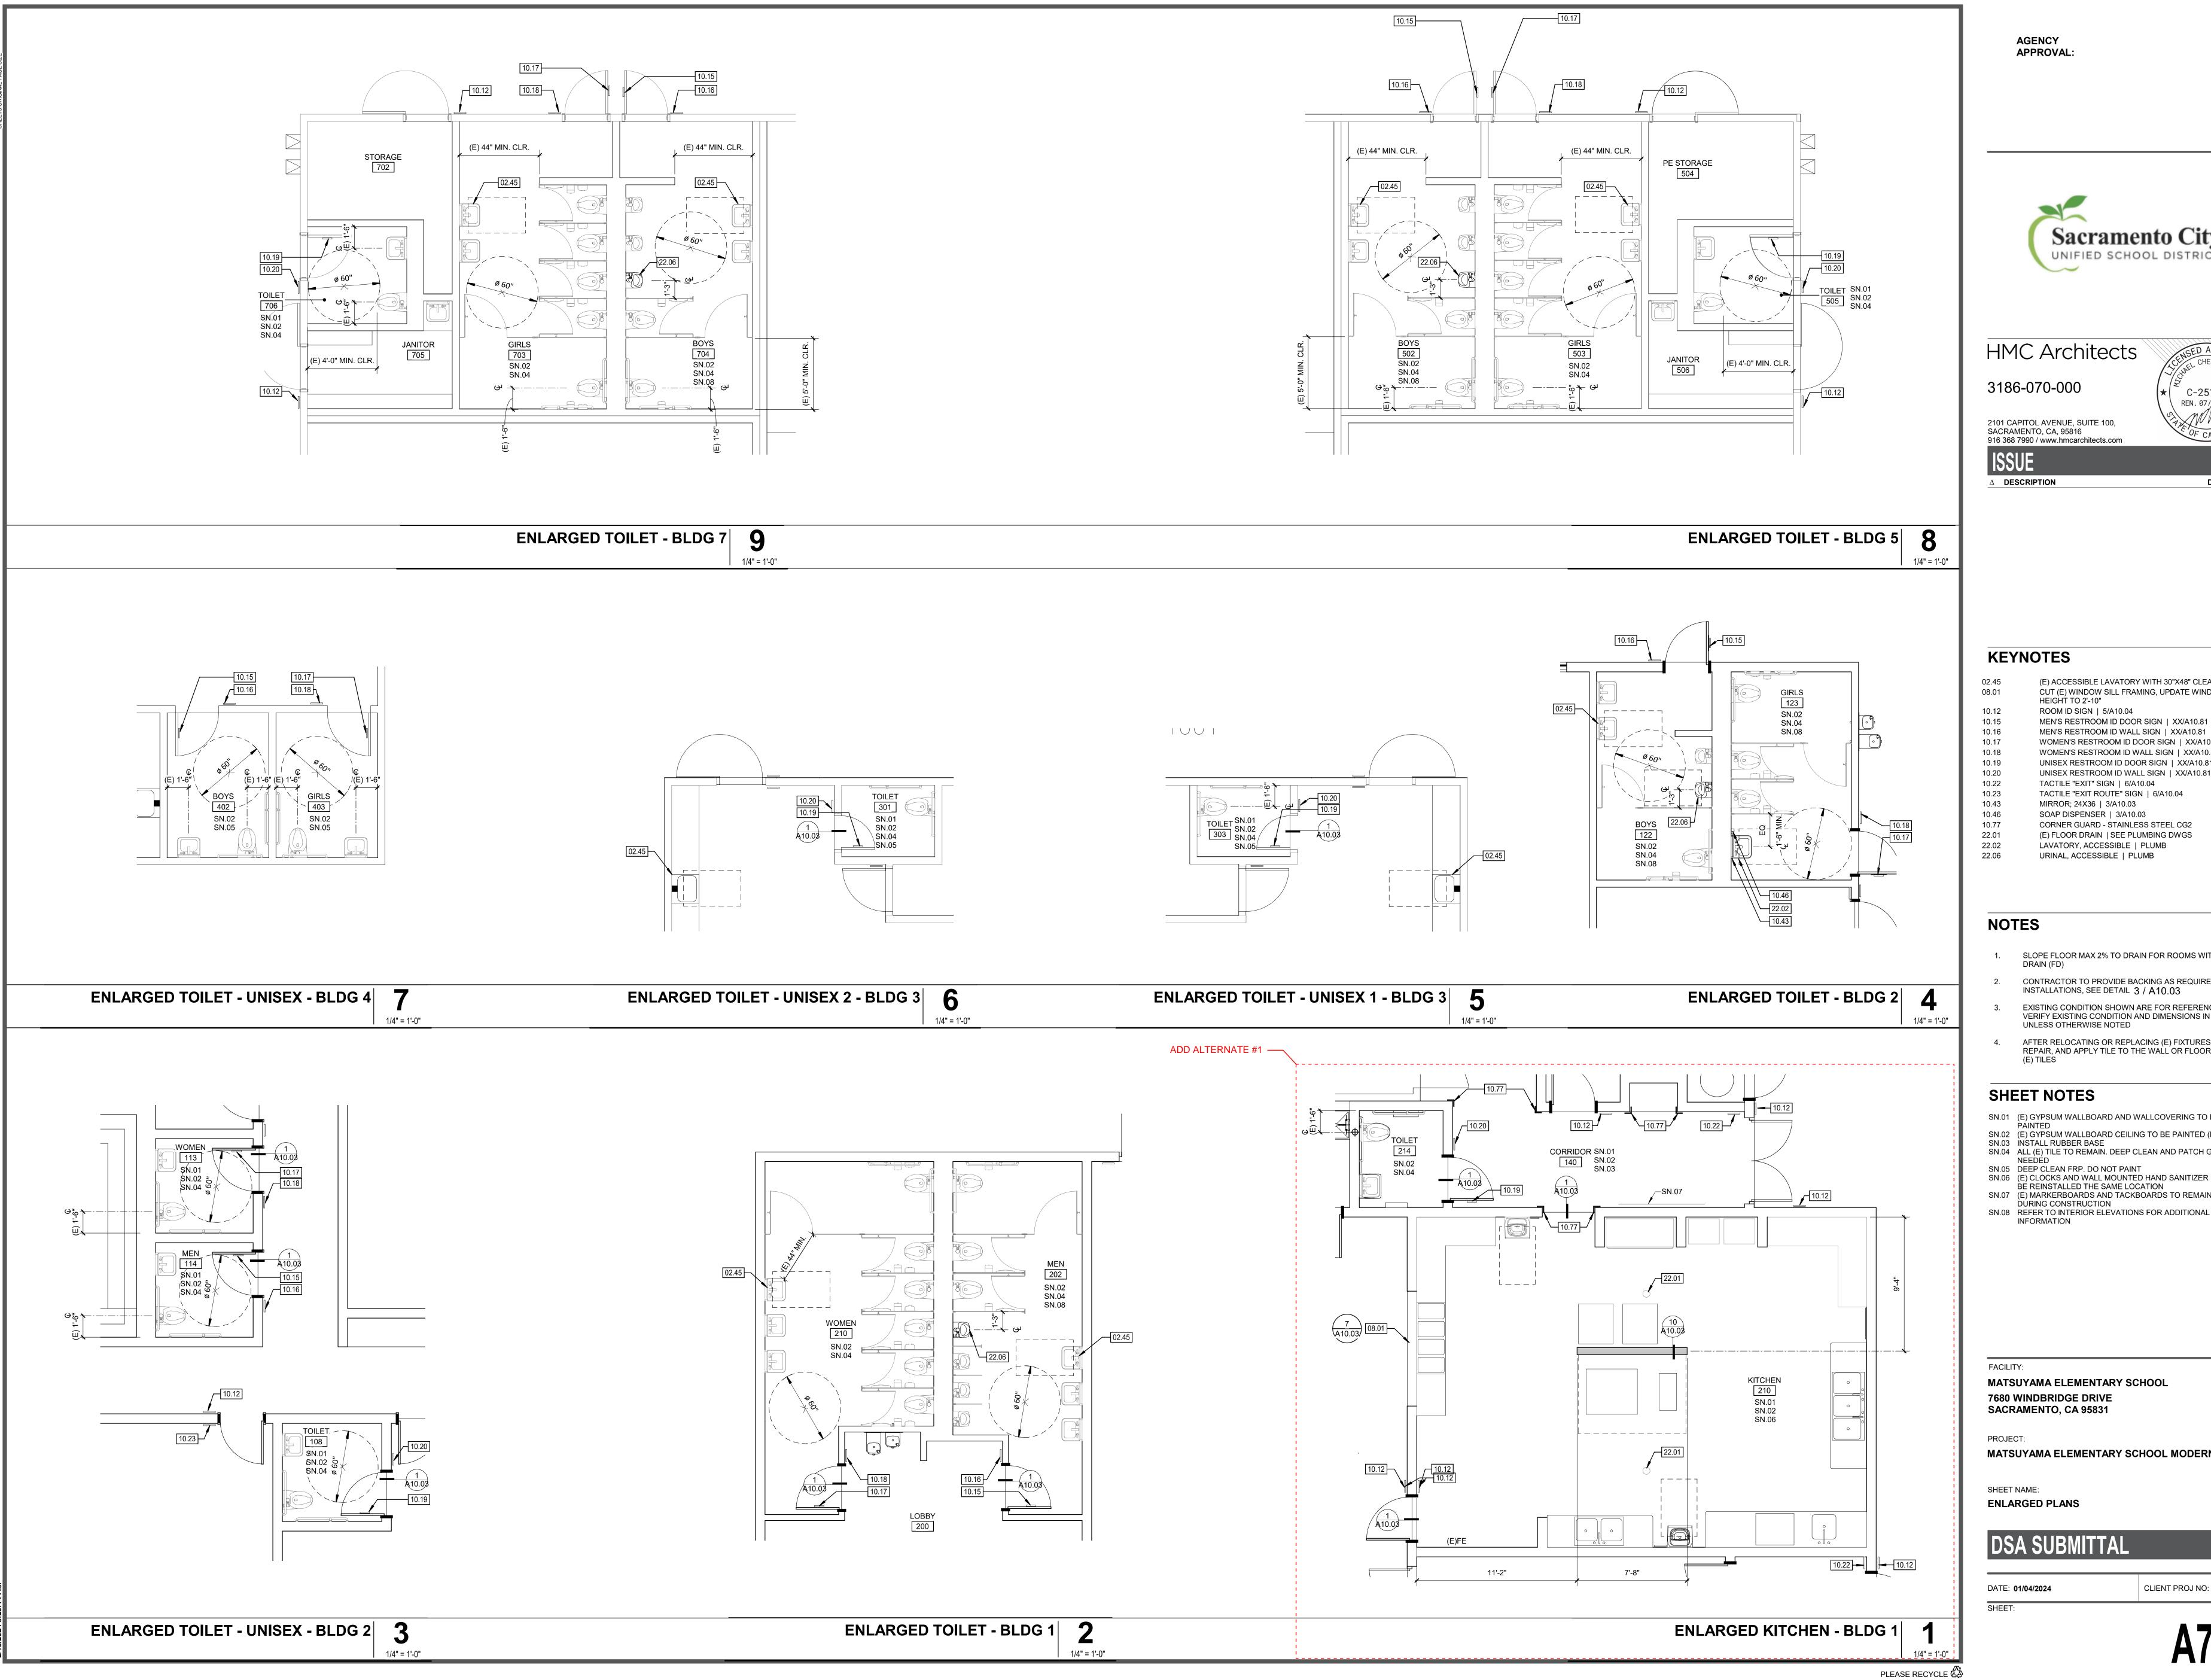



C-25193 REN. 07/31/25

DATE

HMC Architects

3186-070-000

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ISSUE

Δ **DESCRIPTION**

KEYNOTES

(E) ACCESSIBLE LAVATORY WITH 30"X48" CLEAR SPACE CUT (E) WINDOW SILL FRAMING, UPDATE WINDOW SILL ROOM ID SIGN | 5/A10.04 MEN'S RESTROOM ID DOOR SIGN | XX/A10.81 MEN'S RESTROOM ID WALL SIGN | XX/A10.81 UNISEX RESTROOM ID DOOR SIGN | XX/A10.81 UNISEX RESTROOM ID WALL SIGN | XX/A10.81 TACTILE "EXIT ROUTE" SIGN | 6/A10.04 MIRROR; 24X36 | 3/A10.03 SOAP DISPENSER | 3/A10.03

CORNER GUARD - STAINLESS STEEL CG2 (E) FLOOR DRAIN | SEE PLUMBING DWGS

LAVATORY, ACCESSIBLE | PLUMB

URINAL, ACCESSIBLE | PLUMB

- SLOPE FLOOR MAX 2% TO DRAIN FOR ROOMS WITH FLOOR
- CONTRACTOR TO PROVIDE BACKING AS REQUIRED FOR ALL INSTALLATIONS, SEE DETAIL $3\ /\ A10.03$
- EXISTING CONDITION SHOWN ARE FOR REFERENCE ONLY, VERIFY EXISTING CONDITION AND DIMENSIONS IN FIELD,
- UNLESS OTHERWISE NOTED AFTER RELOCATING OR REPLACING (E) FIXTURES PATCH,
- REPAIR, AND APPLY TILE TO THE WALL OR FLOOR MATCHING

SHEET NOTES

INFORMATION

SN.01 (E) GYPSUM WALLBOARD AND WALLCOVERING TO BE

SN.02 (E) GYPSUM WALLBOARD CEILING TO BE PAINTED (PNT1) SN.03 INSTALL RUBBER BASE

SN.04 ALL (E) TILE TO REMAIN. DEEP CLEAN AND PATCH GROUT AS

SN.05 DEEP CLEAN FRP. DO NOT PAINT SN.06 (E) CLOCKS AND WALL MOUNTED HAND SANITIZER PUMPS TO

BÉ REINSTALLED THE SAME LOCATION SN.07 (E) MARKERBOARDS AND TACKBOARDS TO REMAIN. PROTECT DÚRING CONSTRUCTION

MATSUYAMA ELEMENTARY SCHOOL **7680 WINDBRIDGE DRIVE**

MATSUYAMA ELEMENTARY SCHOOL MODERNIZATION

ENLARGED PLANS

DSA SUBMITTAL