
ROSEMONT HIGH SCHOOL 2023 FENCING

9594 Kiefer Blvd. Sacramento, CA 95827

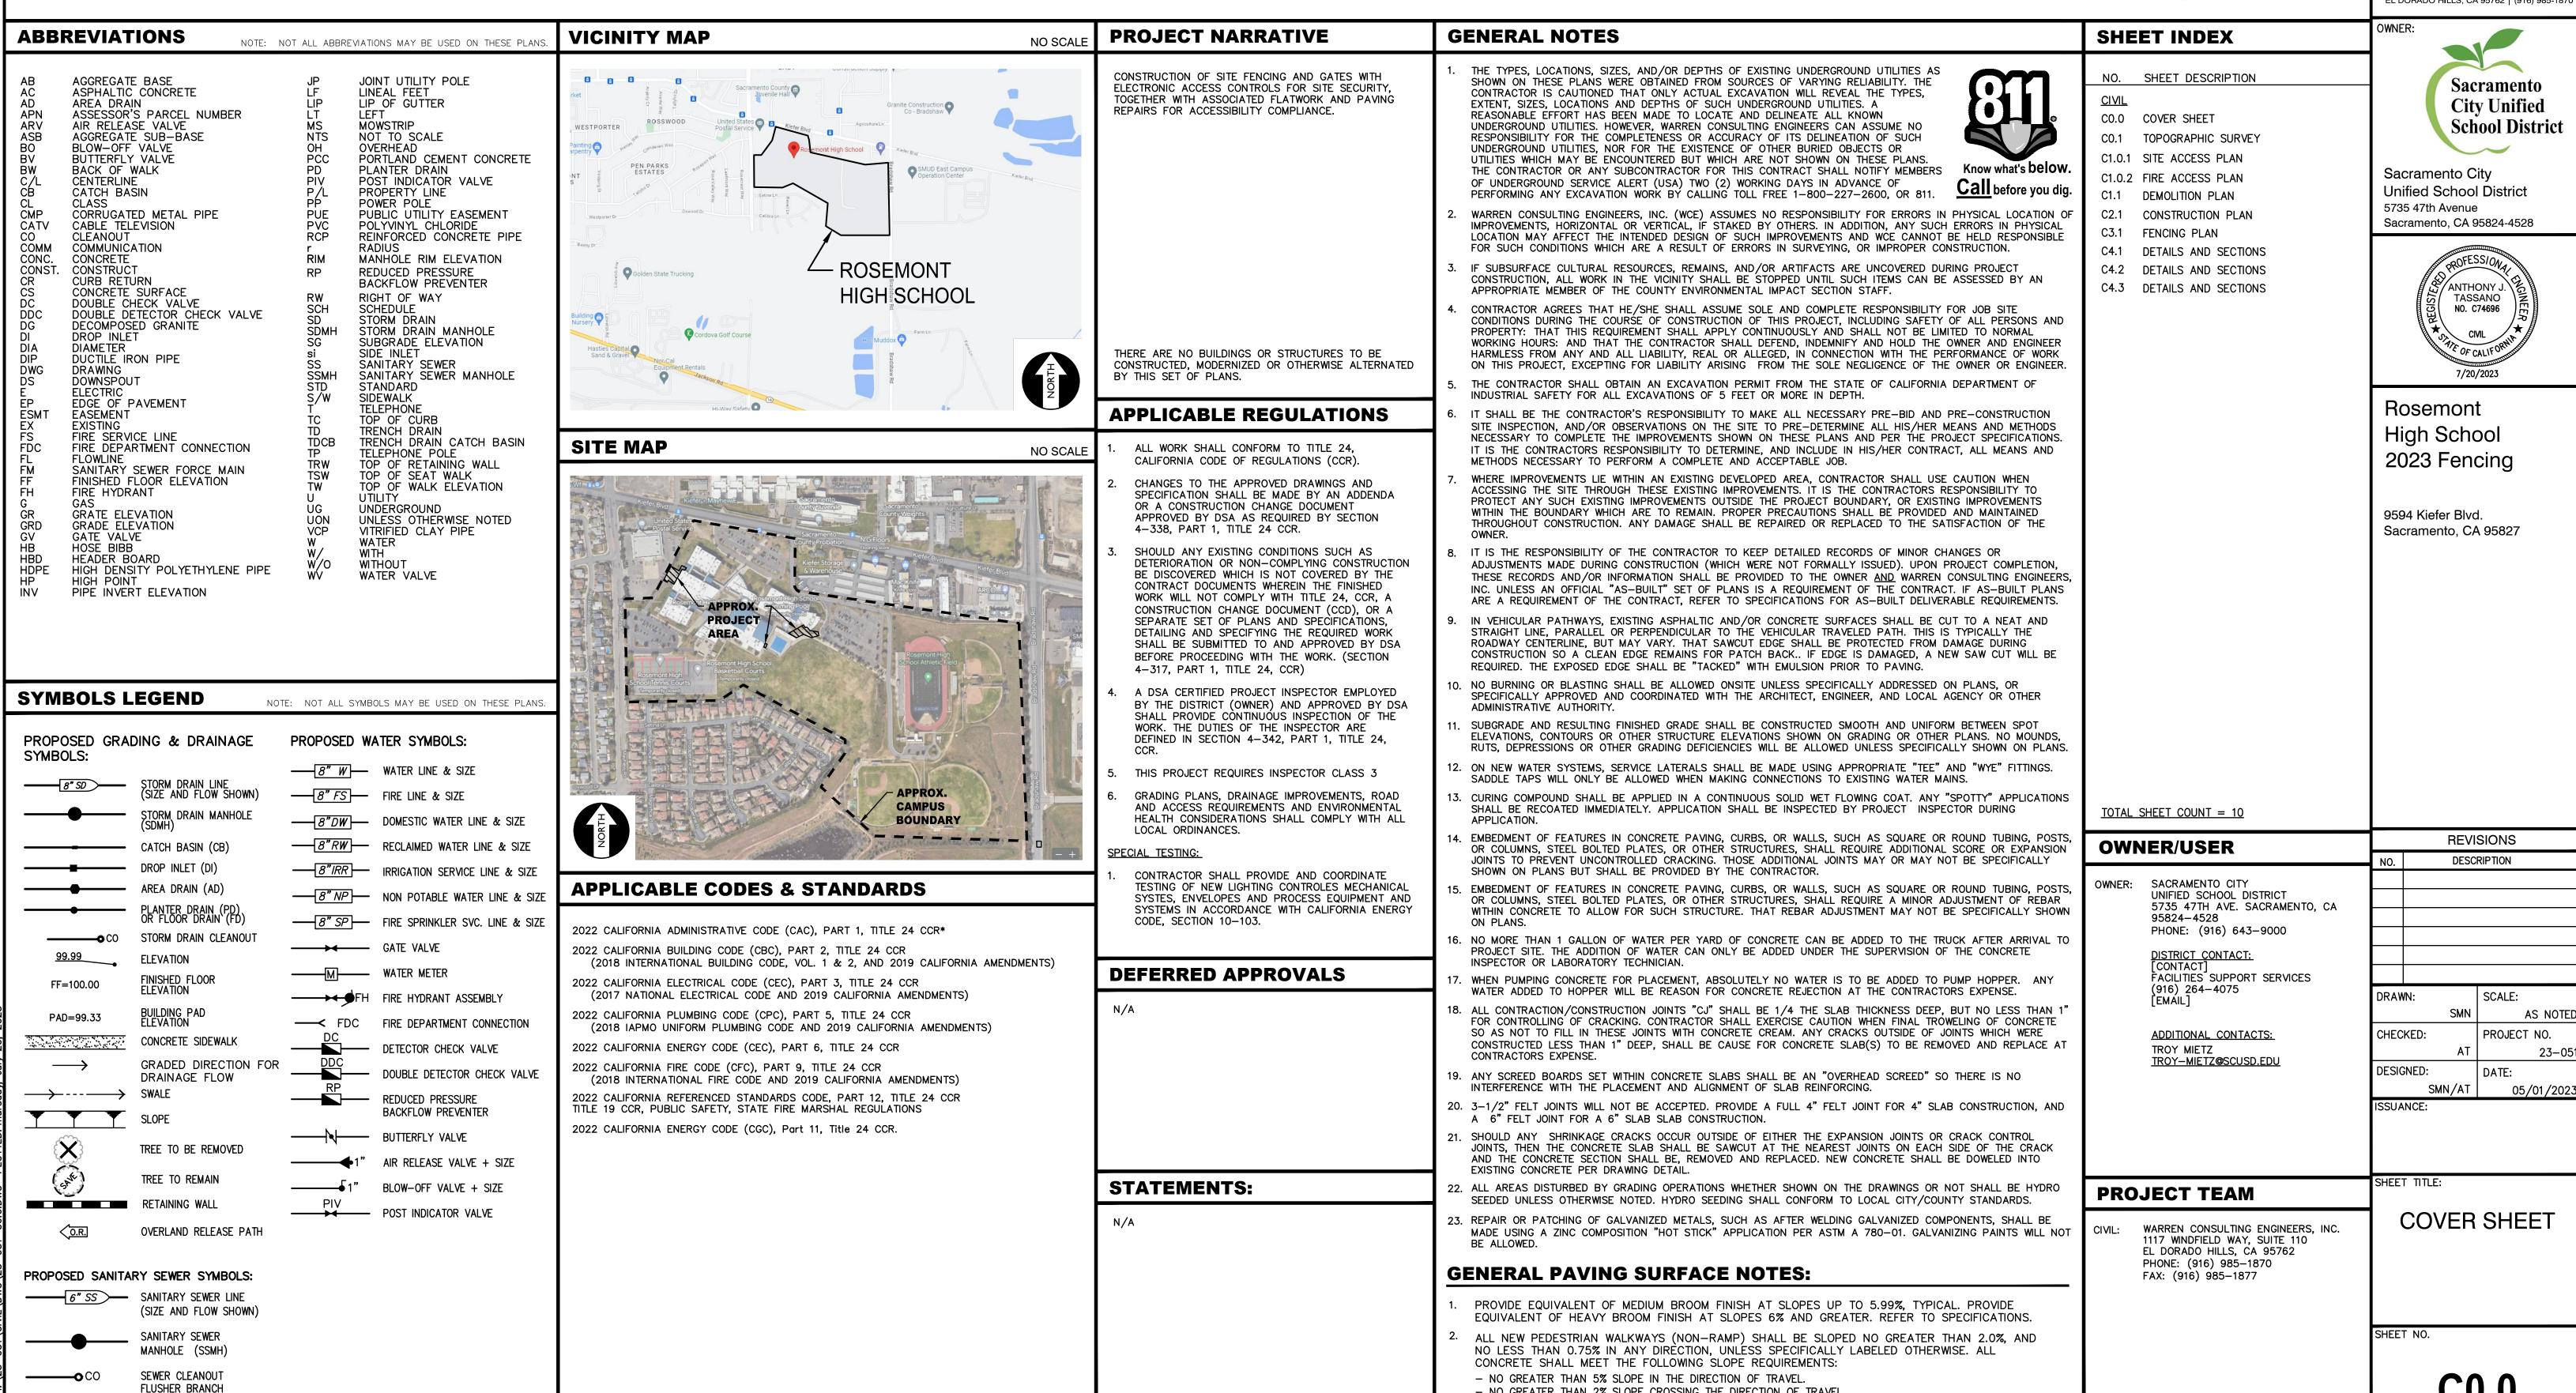






NO GREATER THAN 2% SLOPE CROSSING THE DIRECTION OF TRAVEL.

NO GREATER THAN 2% SLOPE IN ANY DIRECTION IN COURTYARD OR PLAZA AREAS.

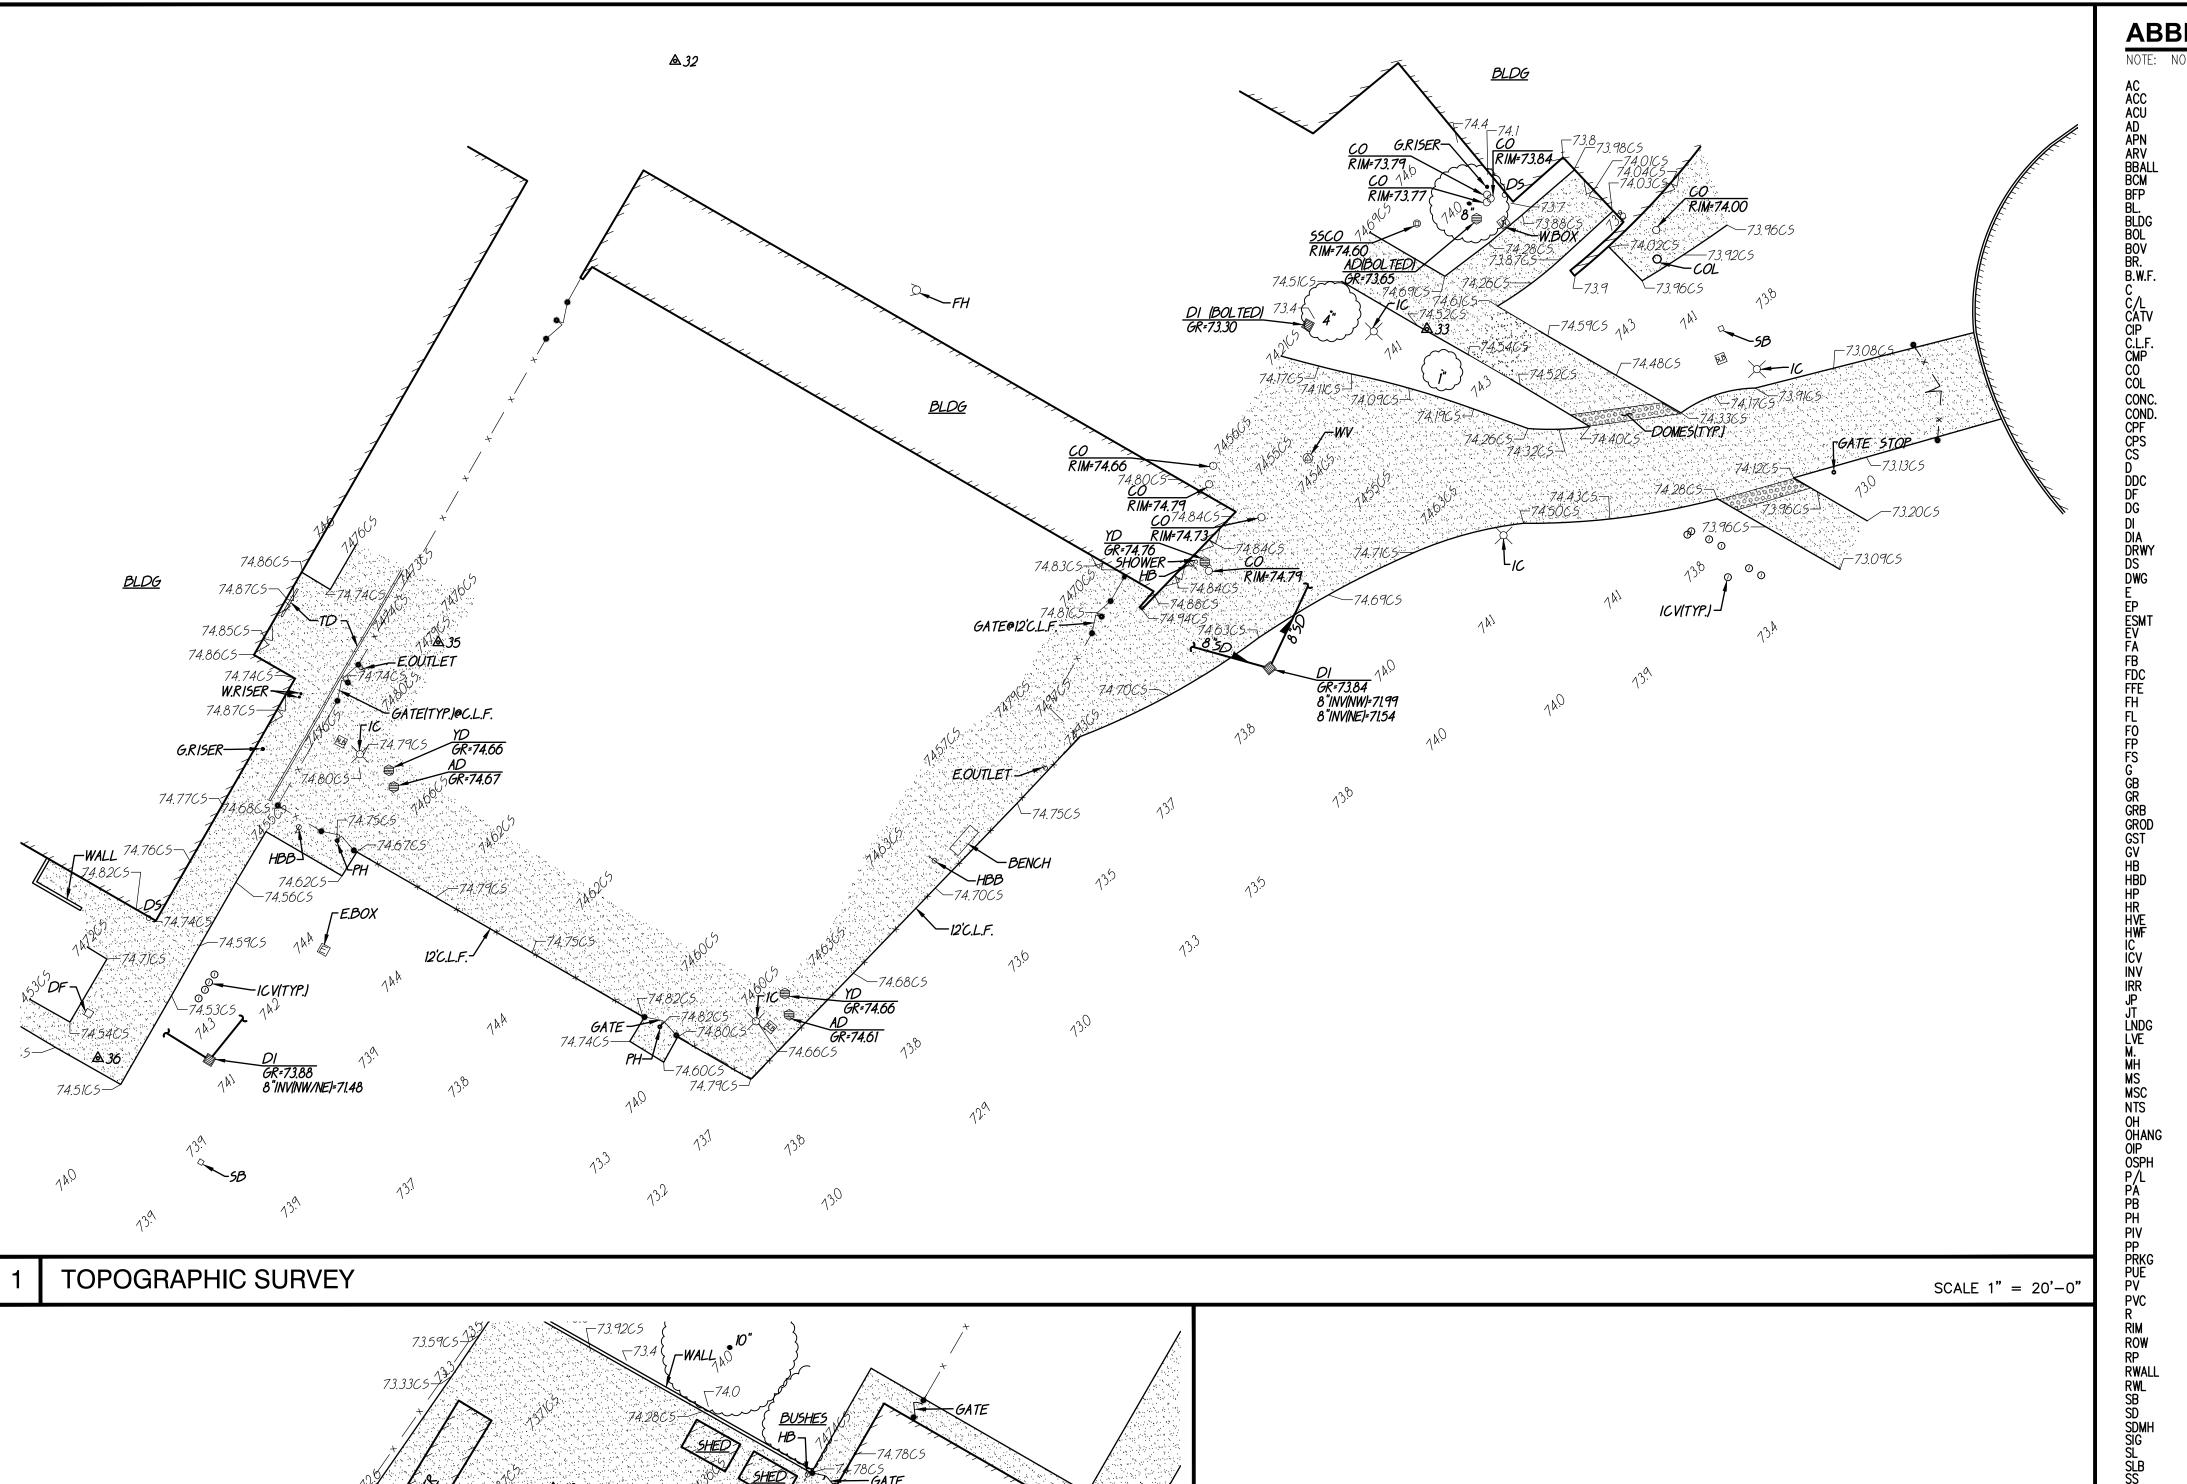

-GARAGE DOOR DUST COLLECTOR WALL + -GARAGE DOOR <u>FFE=74.76</u> -74.72C5 -BOLITYP.I <u>BLDG</u> LSIGN 74.69CS-_74.80C5 74.64C5— GATE@W.I.F.

▲42

TOPOGRAPHIC SURVEY


TBM LIST

NO. DESCRIPTION

SCALE 1" = 20'-0"

11 12 20 25 30 31 32 33 34 35 36 37 38	CPF CHISELED "+" CPF CHISELED "+" CPF CHISELED "+" CPF CHISELED "+" CPS CHISELED "+"	10159.09 10279.23 9988.34 10184.60 10600.77 10501.71 10407.04 10351.18 10538.27 10285.91 10199.28 10066.37 10296.19	9581.61 9298.57 9666.27 9733.79 8619.44 8790.86 8936.07 9092.69 9197.19 8886.73 8815.82 8549.07 8327.28	63.36 69.60 48.86 32.04 74.44 74.42 74.28 74.55 72.82 74.73 74.50 72.07 73.18
32	CPS CHISELED "+"	10407.04	8936.07	74.28
33	CPS CHISELED "+"	10351.18	9092.69	74.55
34	CPS CHISELED "+"	10538.27	9197.19	72.82
35	CPS CHISELED "+"	10285.91	8886.73	74.73
36	CPS CHISELED "+"	10199.28	8815.82	74.50
37	CPS CHISELED "+"	10066.37	8549.07	72.07
38	CPS CHISELED "+"	10296.19	8327.28	73.18
39	CPF CHISELED "+"	10229.07	8235.33	70.50
40	CPF CHISELED "+"	10229.62	8090.93	70.48
41	CPF CHISELED "+"	10498.27	8092.27	72.92
42	CPS CHISELED "+"	10602.37	8264.61	74.41
43	CPS CHISELED "+"	10727.88	8284.74	73.64

GRAPHIC SCALE

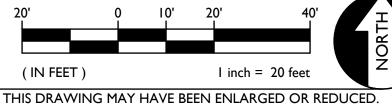

BASIS OF BEARINGS: ***ASSUMED***

ELEV

NOTE:
EXISTING UTILITIES BASED ON VISIBLE SURFACE STRUCTURES ONLY.

SCREENED PORTIONS OF THIS PLAN ARE FROM RECORD SURVEY INFORMATION AND ARE NOT PART OF THE FIELD SURVEY PERFORMED AS PART OF THIS PROJECT. ACTUAL SITE CONDITIONS MAY VARY IN THESE AREAS DUE TO AGE.

В	BREVIATIONS
<u>-</u> :	NOT ALL ABBREVIATIONS MAY BE USED ON THESE
	ASPHALTIC CONCRETE ACCESSIBLE AIR CONDITIONING UNIT AREA DRAIN ASSESSOR'S PARCEL NUMBER
T	AIR RELEASE VALVE BASKETBALL POLE BRASS CAP MONUMENT BACK FLOW PREVENTER
}	BLOCK BUILDING BOLLARD BLOW-OFF VALVE
₹.	BRICK BARBED WIRE FENCE COMMUNICATION CENTERLINE
/	CABLE TELEVISION
•	CAPPED IRON PIPE CHAIN LINK FENCE CORRUGATED METAL PIPE CLEANOUT
C. O.	COLUMN CONCRETE CONDENSATE CONTROL POINT FOUND CONTROL POINT SET CONCRETE SURFACE DEPTH DOUBLE DETECTOR CHECK VALVE
Y	DRINKING FOUNTAIN DECOMPOSED GRANITE DROP INLET DIAMETER DRIVEWAY DOWNISPOLIT
Т	DOWNSPOUT DRAWING ELECTRIC EDGE OF PAVEMENT EASEMENT
	EASEMENT ELECTRICAL VAULT FIRE ALARM FIRE BOX FIRE DEPARTMENT CONNECTION FINISHED FLOOR ELEVATION FIRE HYDRANT FLOWLINE FIBER OPTIC
	FLAGPOLE FIRE SERVICE GAS GRADE BREAK GRATE

GROUND ROD BOX

GROUND ROD

HEADER BOARD

HIGH PRESSURE

HIGH VOLTAGE ELECTRIC
HOG WIRE FENCE
IN CONCRETE
IRRIGATION CONTROL VALVE

PIPE INVERT ELEVATION

LANDING LOW VOLTAGE ELECTRIC

OPEN IRON PIPE OLD STEEL POST HOLE

POST INDICATOR VALVE

PUBLIC UTILITY EASEMENT

MANHOLE RIM ELEVATION

REDUCED PRESSURE BACKFLOW ASBLY.

POLYVINYL CHLORIDE RUBBER

RIGHT OF WAY

RETAINING WALL

SIGNAL BOX STORM DRAIN

STEEL TELEPHONE

TOP OF CURB

TELEPHONE POLE

UNDERGROUND

UNKNOWN

VENT

WATER

WITHOUT

A.P.N. 074-0020-059

KIEFER BLVD.

RAIN WATER LEADER

STREET LIGHT BOX SANITARY SEWER

STORM DRAIN MANHOLE

SANITARY SEWER CLEANOUT SANITARY SEWER MANHOLE

TETHER BALL POLE TEMPORARY BENCHMARK

TOP OF RETAINING WALL

WROUGHT IRON FENCE WOOD RAIL FENCE TRANSFORMER CROSSWALK

BENCHMARK NO. 319A1 ELEV. 64.96

PUBLIC WORKS CO. B.M. 22-90" LOCATED IN TOP NW CORNER CONC. BASE OF SIGNAL STANDARD @ SE CORNER HUNTSMAN DR. AND

2" BRASS DISC STAMPED "SAC. CO. DEPT.

METAL STORAGE CONTAINER

JOINT UTILITY POLE JOINT TRENCH

GATE STOP GAS VALVE

HANDRAIL

IRRIGATION

METAL MANHOLE

NOT TO SCALE OVERHEAD

PROPERTY LINE PLANTER AREA

POWER POLE PARKING

PAVERS

PARKING BUMPER **POSTHOLE**

= storm drain line (size & direction of flow) _____12"SD__ = storm drain line (record information) $\underline{}$ 12"SD $\underline{}$ = storm drain line (UNDERGROUND LOCATING) = storm drain manhole = storm drain cleanout = drop inlet

EXISTING UTILITIES

EXISTING TOPOGRAPHY

= TEMPORARY BENCHMARK (SEE TBM LIST FOR INFO)

= SWALE OR DRAINAGE FLOW

= TREE (SIZE/TYPE INDICATED)

= DRAINAGE FLOW

= SLOPE

= SIGN

= CONTOUR

= FENCE (TYPE NOTED)

= CONCRETE SURFACE

= EDGE OF ASPHALT

= EDGE OF BUILDING

= POST OR BOLLARD

= GROUND ELEVATION

= HARD SURFACE ELEVATION

— - - — = PROPERTY LINE

----- - - = CENTERLINE

= AREA DRAIN

= RAIN WATER LEADER = downspout

= sanitary sewer line (size & direction of flow) ____12"SS _ = sanitary sewer line (record information)

= sanitary sewer line (UNDERGROUND LOCATING) = sanitary sewer manhole

= water line (size indicated) = water line (record information)

= sanitary sewer cleanout

-----W-- - = water line (UNDERGROUND LOCATING) = water manhole = water valve

> = water meter = water box = IRRIGATION CONTROL VALVE

= FIRE HYDRANT = backflow preventer

= SPRINKLER = hose bibb

--OH-E---=OVERHEAD ELECTRIC LINE ----E --- = UNDERGROUND ELECTRIC LINE —————— = UNDERGROUND ELEÇTRIC LINE

(record information) — — E — — = UNDERGROUND ELECTRIC LINE (UNDERGROUND LOCATING)

> = ELECTRIC MANHOLE = UTILITY POLE (WITH GUY WIRE) = ELECTRIC METER

= ELECTRIC BOX = STREET LIGHTING BOX

 \Box = SIGNAL LIGHT = FLOOD LIGHT

= ELECTRICAL OUTLET

---G---=GAS LINE (record information)

= GAS MANHOLE = GAS VALVE

= GAS METER = telephone line

--- \mathcal{T} --- = telephone line (record information) — — T — = telephone line (UNDERGROUND LOCATING)

= STORM DRAIN BOX = TRAFFIC SIGNAL BOX

= PROPERTY CORNER FOUND AS NOTED = PROPERTY CORNER NOTHING FOUND OR SET





Sacramento City Unified School District 5735 47th Avenue Sacramento, CA 95824-4528



Rosemont High School 2023 Fencing

9594 Kiefer Blvd. Sacramento, CA 95827

> REVISIONS DESCRIPTION

DRAWN: SCALE: AS NOTED PROJECT NO. CHECKED: 23-051 DESIGNED: DATE: SMN/AT 05/01/2023


SHEET TITLE:


ISSUANCE:

TOPOGRAPHIC SURVEY

SHEET NO.

C0.1

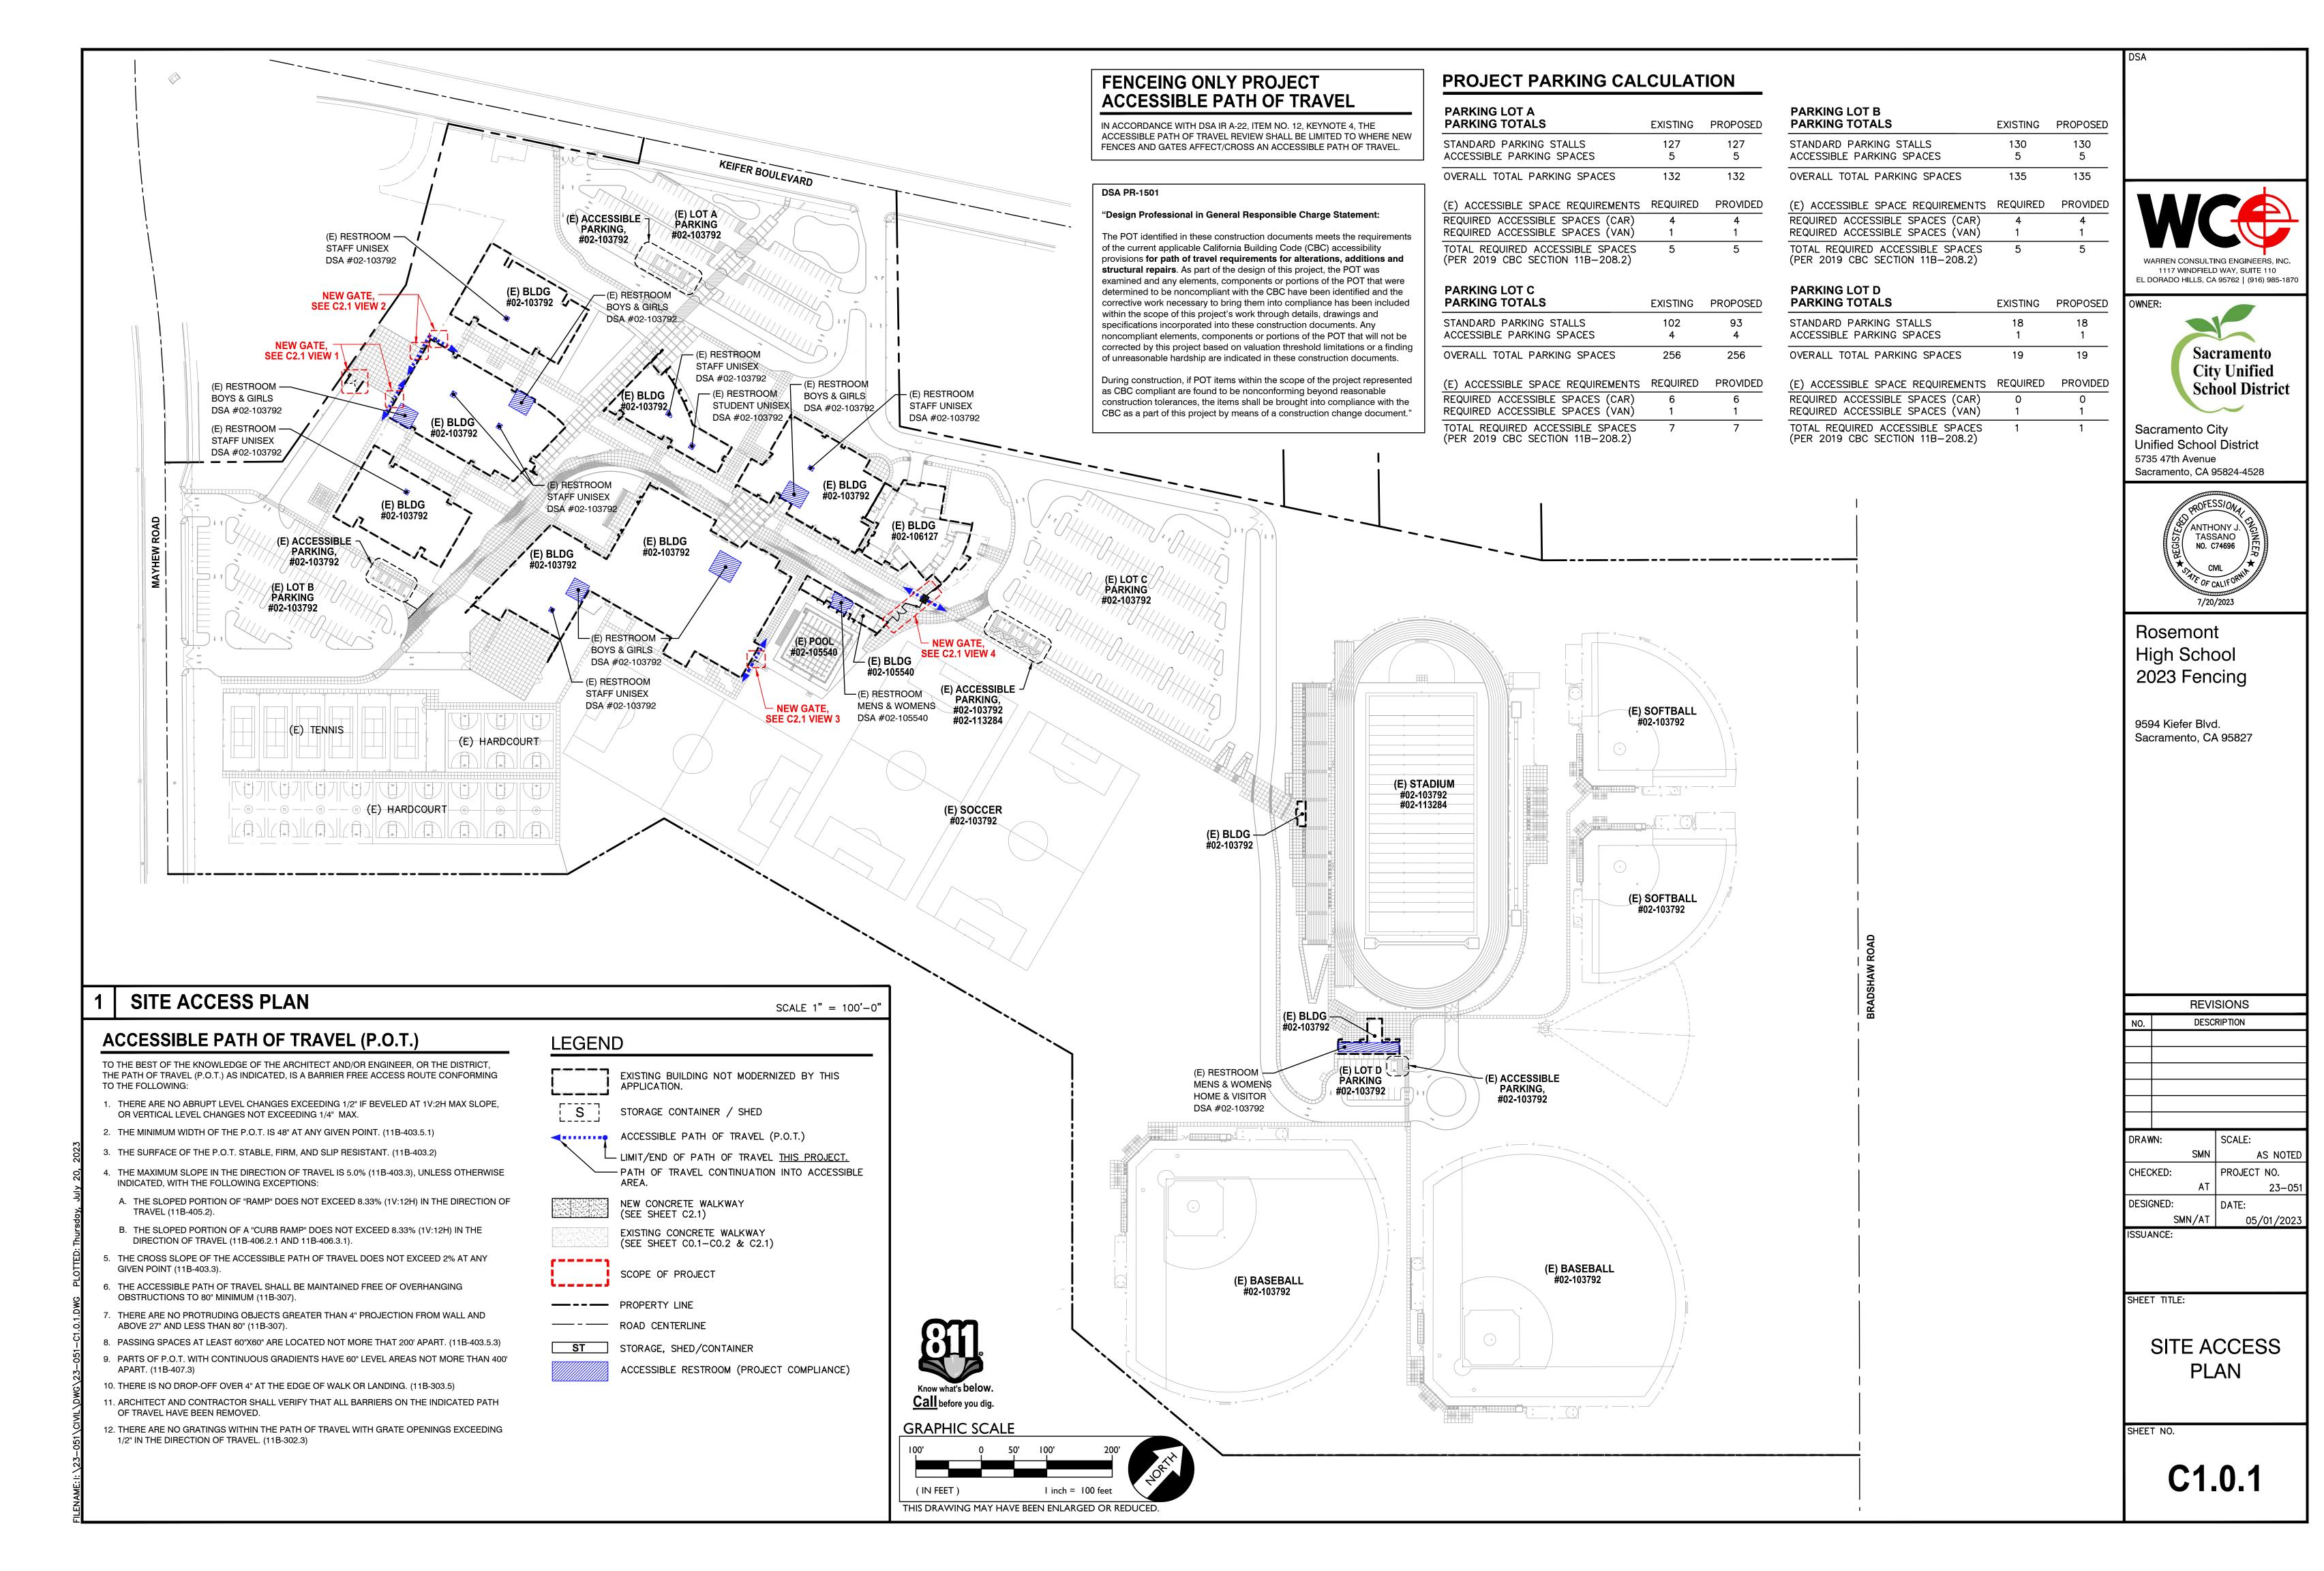

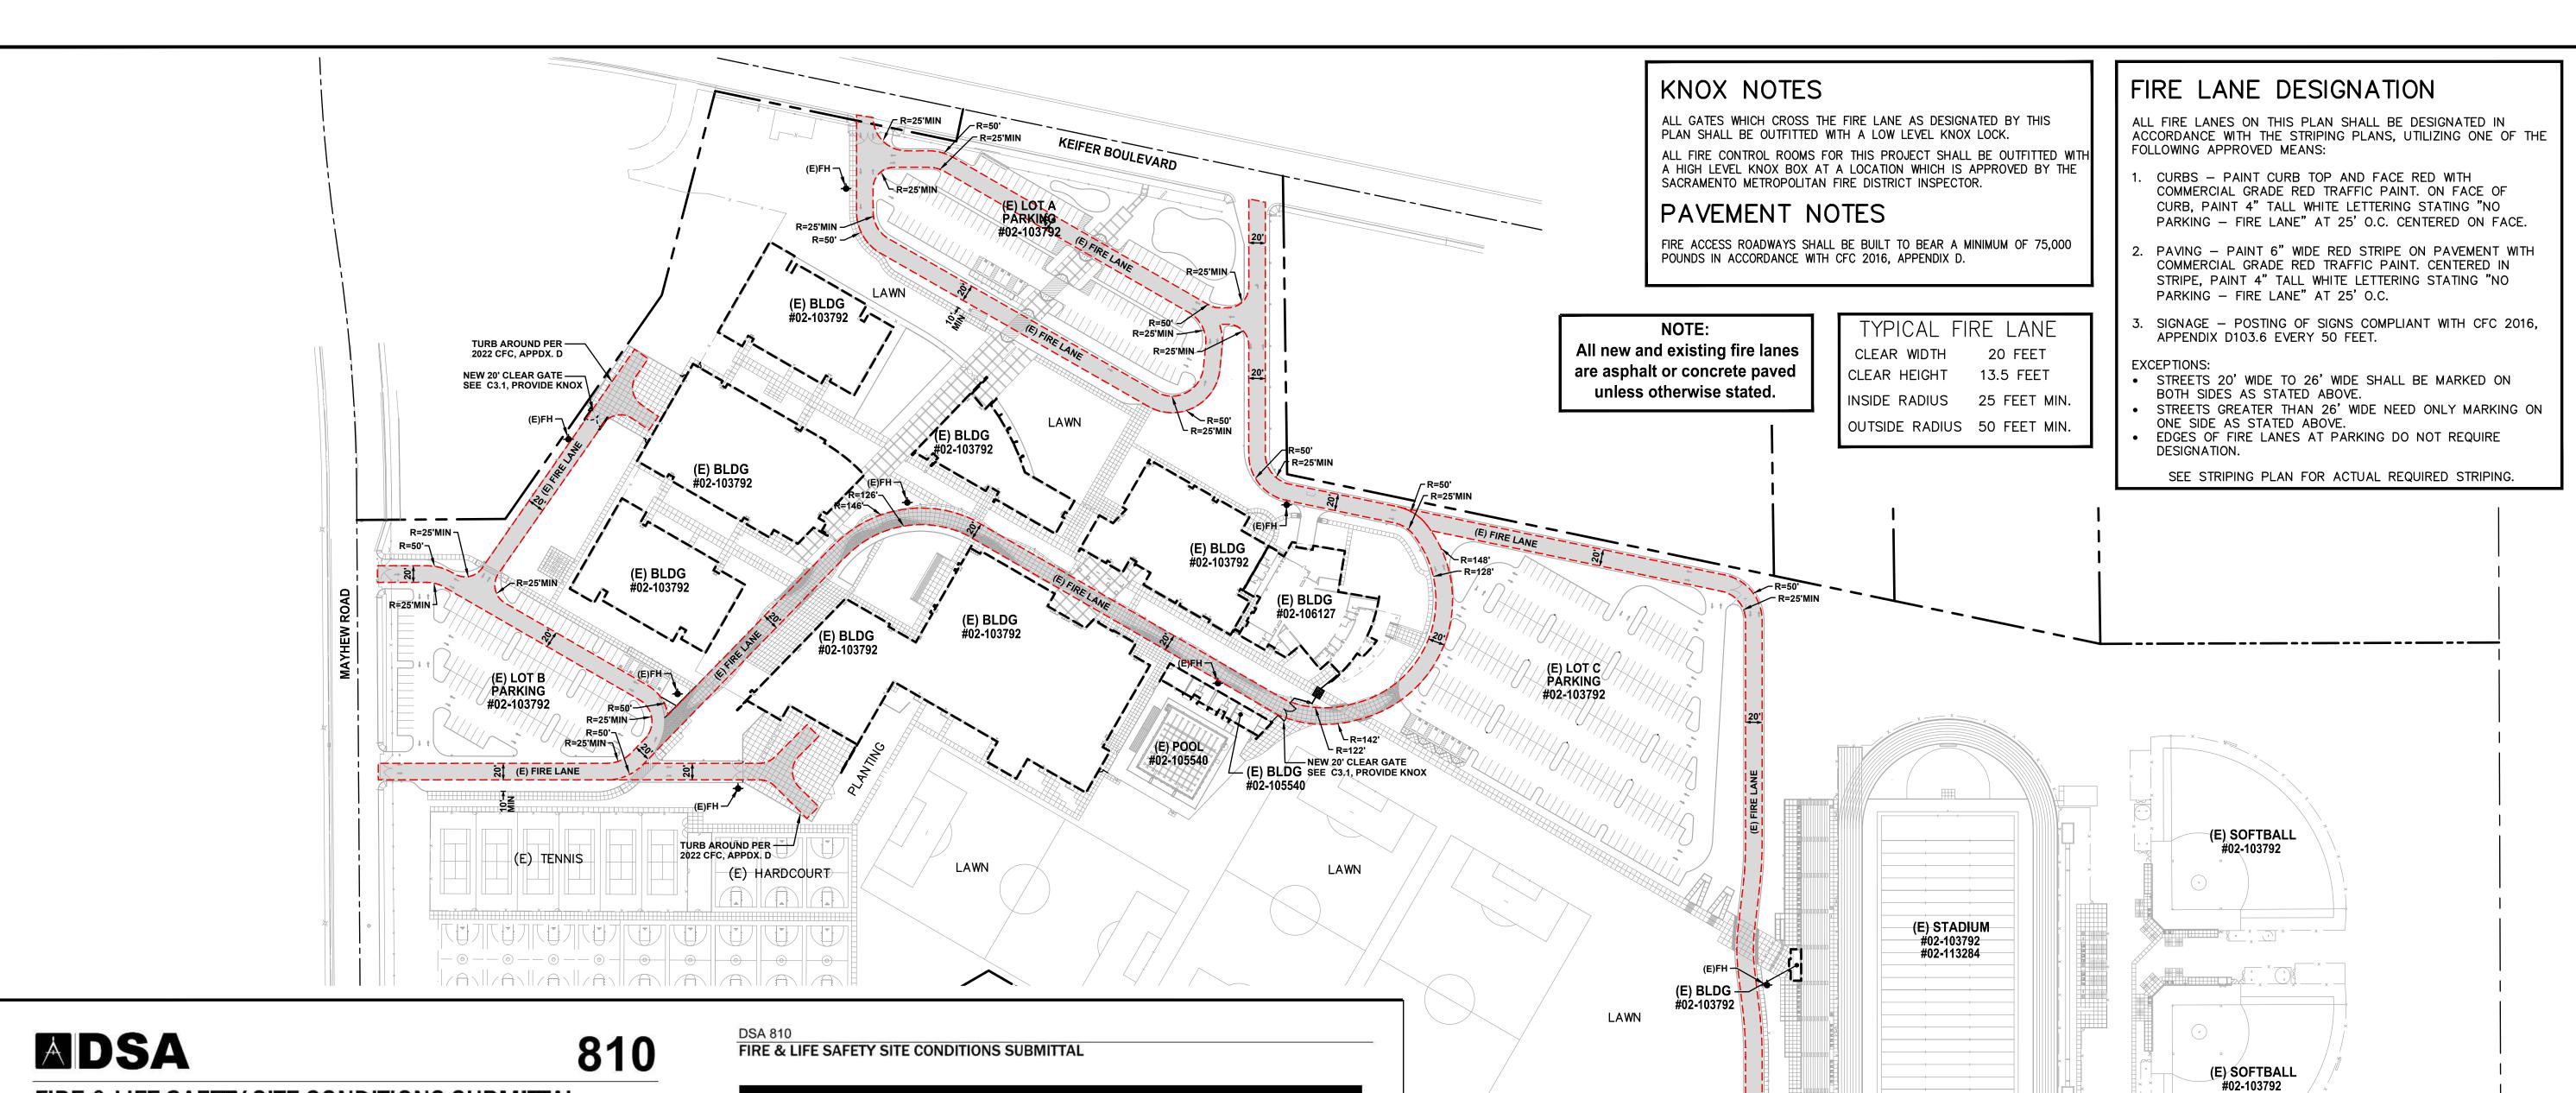

FIRE & LIFE SAFETY SITE CONDITIONS SUBMITTAL

Division of the State Architect (DSA) documents referenced within this publication are available on the DSA Forms or DSA Publications webpages.

To facilitate the Division of the State Architect's (DSA) fire and life safety plan review of project site conditions, DSA requires the design professional to provide the following information at time of project submittal for projects consisting of construction of a new campus, construction of new building(s), additions to existing buildings, and for site alternate design means for fire department emergency vehicle access, and fire suppression water supply.

Information associated with compliance items 1 through 3 below is to be provided for all project types indicated above. Information associated with items 4 through 7 is to be completed when an alternate means is utilized. Acknowledgement by the school district and signature from the Local Fire Authority (LFA) is only required when an alternate design means is being requested.

The Project Information and Fire & Life Safety Information sections are to be completed for all projects and imaged onto the fire access site plan. When an alternate design/means is proposed, all sections on pages 1 and 2 are to be completed and imaged on the fire access site plan.

For additional information refer to the instructions at the end of this form and DSA Policy PL 09-01: Fire Flow for

Buildings.				
PROJECT INFORMATION				
School District/Owner:	SACRAMENTO CITY UNIFIED SCHOOL DISTRICT			
Project Name/School:	ROSEMONT HIGH SCHOOL			
Project Address: 9594 KIEFER BLVD., SACRAMENTO, CA 95827				
FIRE & LIFE SAFETY I	NFORMATION			

1.	Has a fire hydrant flow test been performed within the past 12 months? (If yes, provide a copy of the test data.)	Yes □		No X
2.	Was the fire hydrant water flow test performed as part of this LFA review?			No 💢
3.	Is the project located within a designated fire hazard severity zone (FHSZ) as established by Cal-Fire? (If yes, indicate FHSZ classification below.)	Yes 🗆		No X
	Refer to the following website for FHSZ locations: http://eqis.fire.ca.gov/FHSZ/	Moderate	High 🔲	Very High 🗆
	Wildland Interface Area (WIFA) (If any designations are checked, project design must meet the requirements of CBC Chapter 7A.)			

DGS DSA 810 (revised 12/29/20) Page 1 of 4 STATE OF CALIFORNIA DEPARTMENT OF GENERAL SERVICES DIVISION OF THE STATE ARCHITECT

CON	IDITION MEANS AND METHODS RESOLUTION	ALTERNATE ACCEPTED			
	E 1050	Yes	No	N/A	N/R
4.	Emergency vehicle access roadways do not meet CFC requirements.			X	
4a.	Acceptable Alternate: Emergency vehicle and personnel access as proposed by the project architect is acceptable for providing fire suppression and protection of life and property.				
5.	Fire Hydrants: Number and spacing does not meet CFC requirements.			X	
5a.	Acceptable Alternate: Number of fire hydrants and spacing as proposed by the project architect is acceptable for fire suppression and protection of life and property.				
6.	Fire Hydrants: Water flow and pressure are less than CFC minimum.	ė	**	X	
6a.	Acceptable Alternate: The available flow and pressure is acceptable for providing fire suppression and protection of life and property.				
7.	Location of fire department connection(s) serving fire sprinkler systems or standpipe systems does not meet CFC requirements.			X	
7a.	Acceptable Alternate: The location of fire department connection serving the fire sprinkler system and/or standpipe system is acceptable for providing fire suppression and protection of life and property.				

School District Acceptance of Acceptable Design Alternates


By signing this form, the school district acknowledges and accepts the proposed design as an alternative to California Building Code (CBC) and California Fire Code (CFC) minimum requirements, as indicated by one or more of the conditions indicated at items 4a, 5a, 6a or 7a, for providing fire and life safety protection of life and property.

N/A - NO VARIANCE PROPOSED

LFA Agency Name:	Sacramento Metro Fire		
LFA Review Official: Janea Smith			
Title: Code Enforcement Supevisor Work Phone: (916) 859-4319			
Work Email: Smi	th.jenae@metrofire.ca.gov		
	*		

DGS DSA 810 (revised 12/29/20) Page 2 of 4 STATE OF CALIFORNIA DIVISION OF THE STATE ARCHITECT DEPARTMENT OF GENERAL SERVICES

Sacramento City

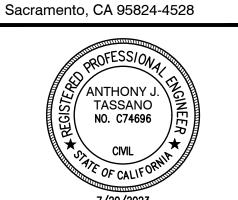

Unified School District

5735 47th Avenue

1117 WINDFIELD WAY, SUITE 110

EL DORADO HILLS, CA 95762 | (916) 985-1870

Sacramento

City Unified

School District

OWNER:

Rosemont High School 2023 Fencing

9594 Kiefer Blvd. Sacramento, CA 95827

REVISIONS DESCRIPTION

SCALE: DRAWN: AS NOTE PROJECT NO. CHECKED: 23-051 DESIGNED: DATE: SMN/AT 05/01/2023

ISSUANCE:

SHEET TITLE:

FIRE ACCESS **PLAN**

SHEET NO.

C1.0.2

FIRE ACCESS PLAN


(E) BASEBALL #02-103792

(E) BLDG #02-103792

SCALE 1" = 100' - 0"

(E) BASEBALL

#02-103792

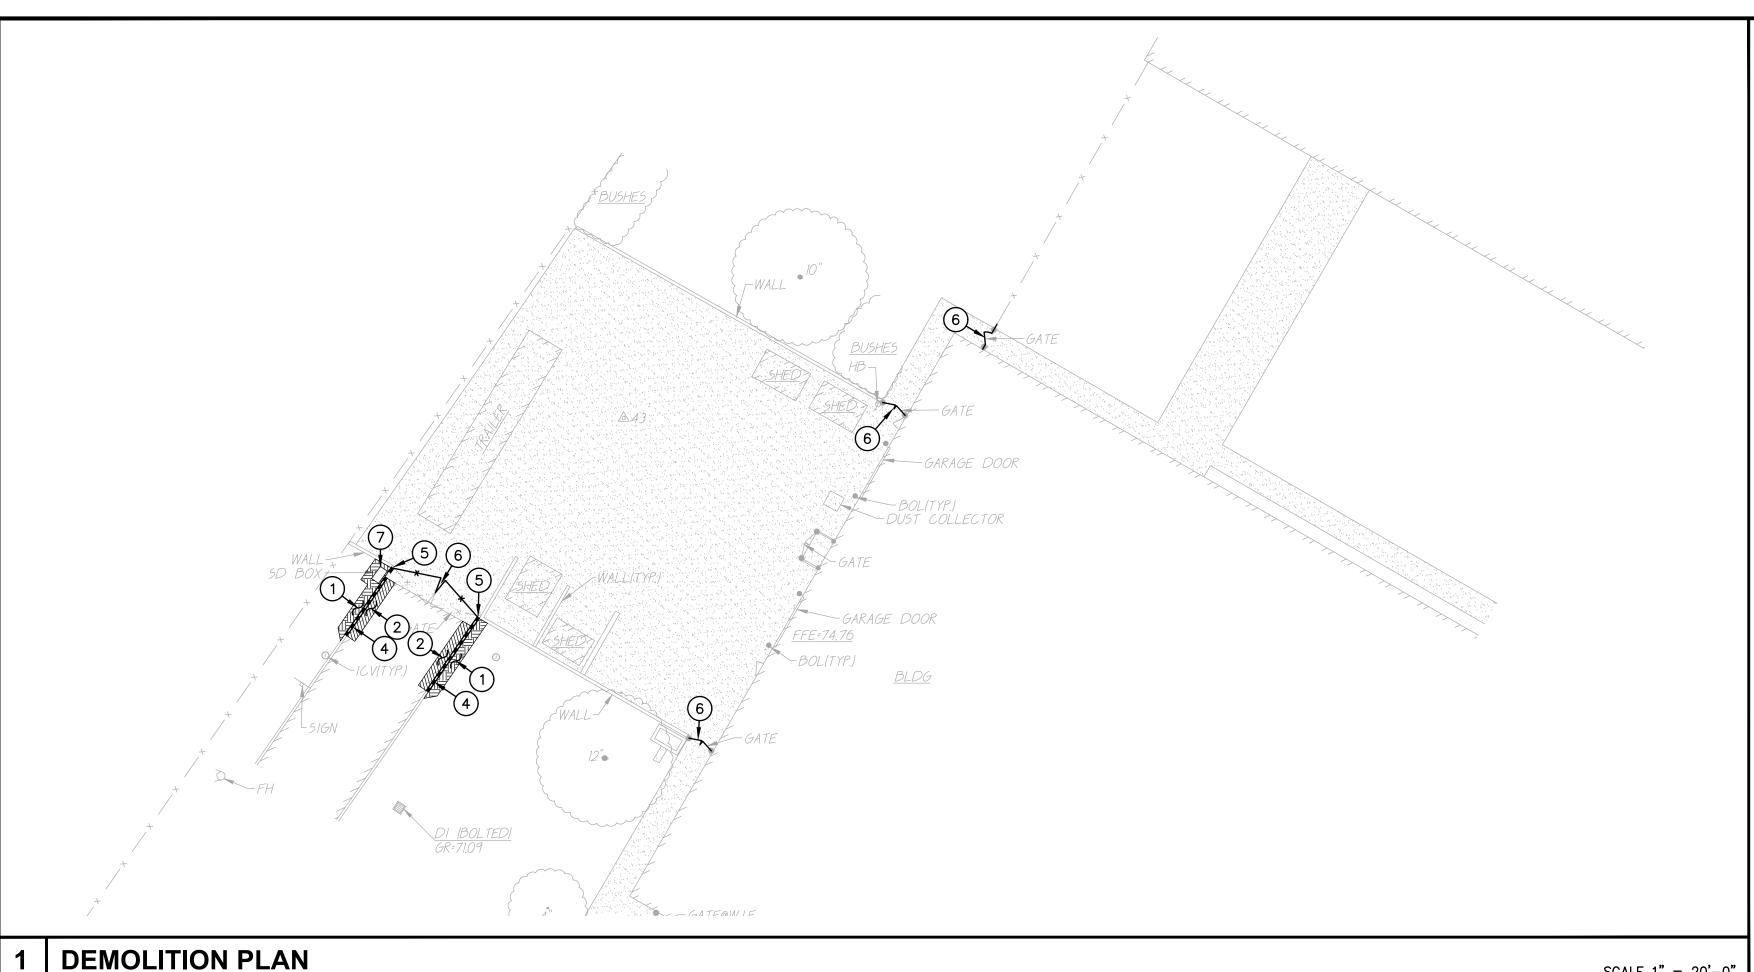

DEMOLITION PLAN

CAL-GREEN - Waste Diversion:

5.408.1 Construction waste management. Recycle and/or salvage for reuse a minimum of 65 percent of the nonhazardous construction and demolition waste in accordance with Section 5.408.1.1, 5.408.1.2 or 5.408.1.3; or meet a local construction and demolition waste management ordinance, whichever is more stringent.

5.408.1.1 Construction waste management plan. Where a local jurisdiction does not have a construction and demolition waste management ordinance that is more stringent, submit a construction waste management plan that:

- 1. Contractor shall Identify the construction and demolition waste materials to be diverted from disposal, to comply with 65% criteria listed above, by efficient usage, recycling, reuse on the project or salvage for future use or sale.
- (source-separated) or bulk mixed (single stream). Either method is the responsibility of the contractor. Contractor shall Identify diversion facilities where construction and demolition waste material collected will be taken. Transport to such facilities is contractors responsibility.

Contractor shall determines if construction and demolition waste materials will be sorted on-site

Contractor shall record and provide record of the amount of construction and demolition waste materials diverted shall be calculated by weight or volume, but not by both.

5.408.1.2 Waste management company. Utilize a waste management company that can provide verifiable documentation that the percentage of construction and demolition waste material diverted from the landfill complies with this section.

Contractor shall make the determination if the construction and demolition waste material will be diverted by a waste management company. Contractor shall make any and all arrangements with waste management company for pickup of materials.

Exceptions to Sections 5.408.1.1 and 5.408.1.2: Excavated soil and land-clearing debris.

- Alternate waste reduction methods developed by working with local agencies if diversion or recycle facilities capable of compliance with this item do not exist.
- Demolition waste meeting local ordinance or calculated in consideration of local recycling facilities and

5.408.1.3 Waste stream reduction alternative. The combined weight of new construction disposal that does not exceed two pounds per square foot of building area may be deemed to meet the 65 percent minimum requirement as approved by the enforcing agency.

CAL-GREEN - Waste Diversion Documentation Required:

Contractor shall prepare and provide documentation to the enforcing agency which demonstrates compliance with Calgreen Sections 5.408.1.1 through 5.408.1.3. The waste management plan shall be updated as necessary and shall be accessible during construction for examination by the enforcing agency.

1. Sample forms found in "A Guide to the California Green Building Standards Code (Nonresidential)" located at

- http://www.bsc.ca.gov/Home/CALGreen. aspx may be used to assist in documenting compliance with the waste management plan.
- Mixed construction and demolition debris (C&D) processors can be located at the California Department of Resources Recycling and Recovery (CalRecycle).

CAL-GREEN - Excavated Soil & Land Clearing:

soils resulting primarily from land clearing shall be reused or recycled. For a phased project, such material may be stockpiled on site until the storage site is developed.

Exception: Reuse, either on-or off-site, of vegetation or soil contaminated by disease or pest infestation.

5.408.3 Excavated soil and land clearing debris. 100 percent of trees, stumps, rocks and associated vegetation and

ENGINEER IMMEDIATELY FOR DIRECTION.

SCALE 1'' = 20' - 0''

1. If contamination by disease or pest infestation is suspected, contact the County Agricultural Commissioner and follow its direction for recycling or disposal of the material. (www.cdfa.ca.gov/exec/county/county_contacts.html) For a map of known pest and/or disease quarantine zones, consult with the California Department of Food and Agriculture. (www.cdfa.ca.gov)

DEMOLITION GENERAL NOTES

- IN THE EVENT THAT ANY UNUSUAL CONDITIONS NOT COVERED BY THE GEOTECHNICAL INVESTIGATION REPORT OR ARE ENCOUNTERED DURING GRADING OPERATIONS THE GEOTECHNICAL ENGINEER AND THE ENGINEER SHALL BE IMMEDIATELY NOTIFIED FOR
- NO BURNING OR BLASTING SHALL BE PERMITTED.
- ADDITIONAL DEMOLITION INFORMATION MAY BE SHOWN ON THE GRADING, DRAINAGE, AND UTILITY PLANS, AND THOSE PLANS PREPARED BY OTHER DISCIPLINES FOR THIS PROJECT.
- ALL DEMOLISHED ITEMS SHALL BE DISPOSED OF OFFSITE AT A SUITABLE, LEGAL, DUMP SITE OR OTHER FACILITY.
- 5. ALL DISPOSED OF MATERIALS SHALL BE RECYCLED IF POSSIBLE.
- THE TYPES, LOCATIONS, SIZES AND/OR DEPTHS OF EXISTING UNDERGROUND UTILITIES AS SHOWN IN THESE PLANS WERE OBTAINED FROM SOURCES OF VARYING RELIABILITY. THE CONTRACTOR IS CAUTIONED THAT ONLY ACTUAL EXCAVATION WILL REVEAL THE TYPES, EXTENT, SIZES, LOCATIONS, AND DEPTHS OF SUCH UNDERGROUND UTILITIES. A REASONABLE EFFORT HAS BEEN MADE TO LOCATE AND DELINEATE ALL KNOWN UNDERGROUND UTILITIES. HOWEVER, WARREN CONSULTING ENGINEERS CAN ASSUME NO RESPONSIBILITY FOR THE COMPLETENESS OR ACCURACY OF ITS DELINEATION OF SUCH UNDERGROUND UTILITIES, NOR FOR THE EXISTENCE OF OTHER BURIED OBJECTS OR UTILITIES WHICH MAY BE ENCOUNTERED BUT WHICH ARE NOT SHOWN ON THESE DRAWINGS. THE CONTRACTOR OR ANY SUBCONTRACTOR FOR THIS CONTRACT SHALL NOTIFY THE DISTRICT TWO (2) WORKING DAYS IN ADVANCE OF PERFORMING ANY EXCAVATION WORK IN ORDER TO VERIFY TO THE GREATEST EXTENT POSSIBLE THE EXISTING UTILITY LINES, CONFLICTS AND PROPOSED UTILITY CONNECTION POINTS.
- THE SCHOOL DISTRICT SHALL HAVE SALVAGE RIGHTS TO ANY DEMOLISHED ITEMS SHOWN HEREON. THE CONTRACTOR SHALL GIVE THE DISTRICT NOTICE 7 DAYS PRIOR TO THE START OF DEMOLITION. THE DISTRICT SHALL MOVE ANY RETAINED ITEMS OUT OF THE CONTRACTORS WORK AREA, UNLESS ANOTHER ARRANGEMENT IS MADE WITH THE CONTRACTOR. ANY REMAINING ITEMS BECOME THE PROPERTY OF THE CONTRACTOR AND SHALL BE REMOVED FROM THE SITE. ANY ITEMS NOT SHOWN FOR REMOVAL SHALL REMAIN AND SHALL BE
- PROTECTED FROM DAMAGE DURING CONSTRUCTION TO A REASONABLE EXTEND. EXISTING UTILITY STRUCTURES IN AREAS OF NEW PAVING SHALL BE REMOVED AND REINSTALLED AT NEW GRADE UNLESS SPECIFICALLY NOTED OTHERWISE.
- 9. ITEMS OUTSIDE THE LIMITS OF DEMOLITION SHALL REMAIN AND BE PROTECTED FROM DAMAGE DURING CONSTRUCTION..
- 10. CONTRACTOR SHALL COMPLY WITH CHAPTER 33 OF THE 2019 CFC, "FIRE SAFETY DURING CONSTRUCTION AND DEMOLITION" AT ALL TIMES DURING CONSTRUCTION.
- CONTRACTOR SHALL HIRE A UTILITY LOCATING COMPANY AND SHALL SCAN THE ENTIRE AREA WITHIN THE LIMITS OF NEW WORK. ALL UTILITIES LOCATED SHALL BE MARKED AND PROTECTED DURING THE LIMING OPERATIONS AS WELL AS ANY EXCAVATING TASKS. ANY LOCATED UTILITY DAMAGED WITHIN THE LIMITS OF WORK WILL BE THE RESPONSIBILITY OF
- 12. ALL DEMOLITION SHALL BE APPROPRIATELY SUPPORTED AND REINFORCED DURING REMOVAL TO PREVENT INJURY FROM FALLING, PROJECTILE, OR OTHERWISE MOVING DEBRIS OR OTHER DELETERIOUS MATERIAL. ONSITE SAFETY WITHIN THE LIMITS OF WORK IS THE CONTRACTORS SOLE RESPONSIBILITY.

DEMOLITION NOTES

THE CONTRACTOR TO REPAIR.

NOTE: NOT ALL NOTES MAY BE USED ON THIS SHEET LEGEND # DEMOLITION NOTES



REMOVE ALL PLANTS, SHRUBS, EXISTING VEGETATION, AND IRRIGATION SYSTEMS. REFER TO EARTHWORK SPECIFICATIONS FOR ADDITIONAL SITE CLEARING REQUIREMENTS. SEE GENERAL IRRIGATION NOTE, THIS SHEET.



- REMOVE EXISTING ASPHALT PAVING AND BASE TO ALLOW FOR NEW WORK. AC MAY BE GRINDED AND BLENDED WITH EXISTING BASE, EXCAVATED AND USED AS FILL, REFER TO EARTHWORK SPECIFICATIONS.
- 3. REMOVE EXISTING CONCRETE PAVING AND BASE ROCK, WHERE SAWCUTS ARE NECESSARY, THEY SHALL BE A NEAT STRAIGHT LINE. CUT SHALL BE MADE AT NEAREST EXISTING JOINT TO LOCATION SHOWN.
- 4. REMOVE EXISTING CONCRETE CURB, MOWBAND, APRON OR GUTTER AS
 - 5. SAWCUT EXISTING GATE POST TO GRADE. GRIND FLUSH SO NO LIP IS PRESENT. FILL WITH MORTAR TO FLUSH WITH GRADE AND TOOL SMOOTH.
- * * * 6. REMOVE EXISTING CHAIN LINK FENCING AND GATES AS SHOWN. REMOVE

7. EXISTING DRAIN INLET TO REMAIN.

POST TO INCLUDE CONCRETE FOOTINGS. REPAIR FINISHED SURFACES.

Sacramento, CA 95827

9594 Kiefer Blvd.

Rosemont

High School

2023 Fencing

1117 WINDFIELD WAY, SUITE 110

EL DORADO HILLS, CA 95762 | (916) 985-1870

Sacramento

City Unified

School District

OWNER:

Sacramento City

5735 47th Avenue

Unified School District

Sacramento, CA 95824-4528

ANTHONY . TASSANO

NO. C74696

7/20/2023

REVISIONS DESCRIPTION

DRAWN: SCALE: AS NOTE PROJECT NO. CHECKED: 23-051 DESIGNED: SMN/AT | 05/01/2023

ISSUANCE:


SHEET TITLE:

DEMOLITION PLAN

SHEET NO.

Call before you dig.


C1.1

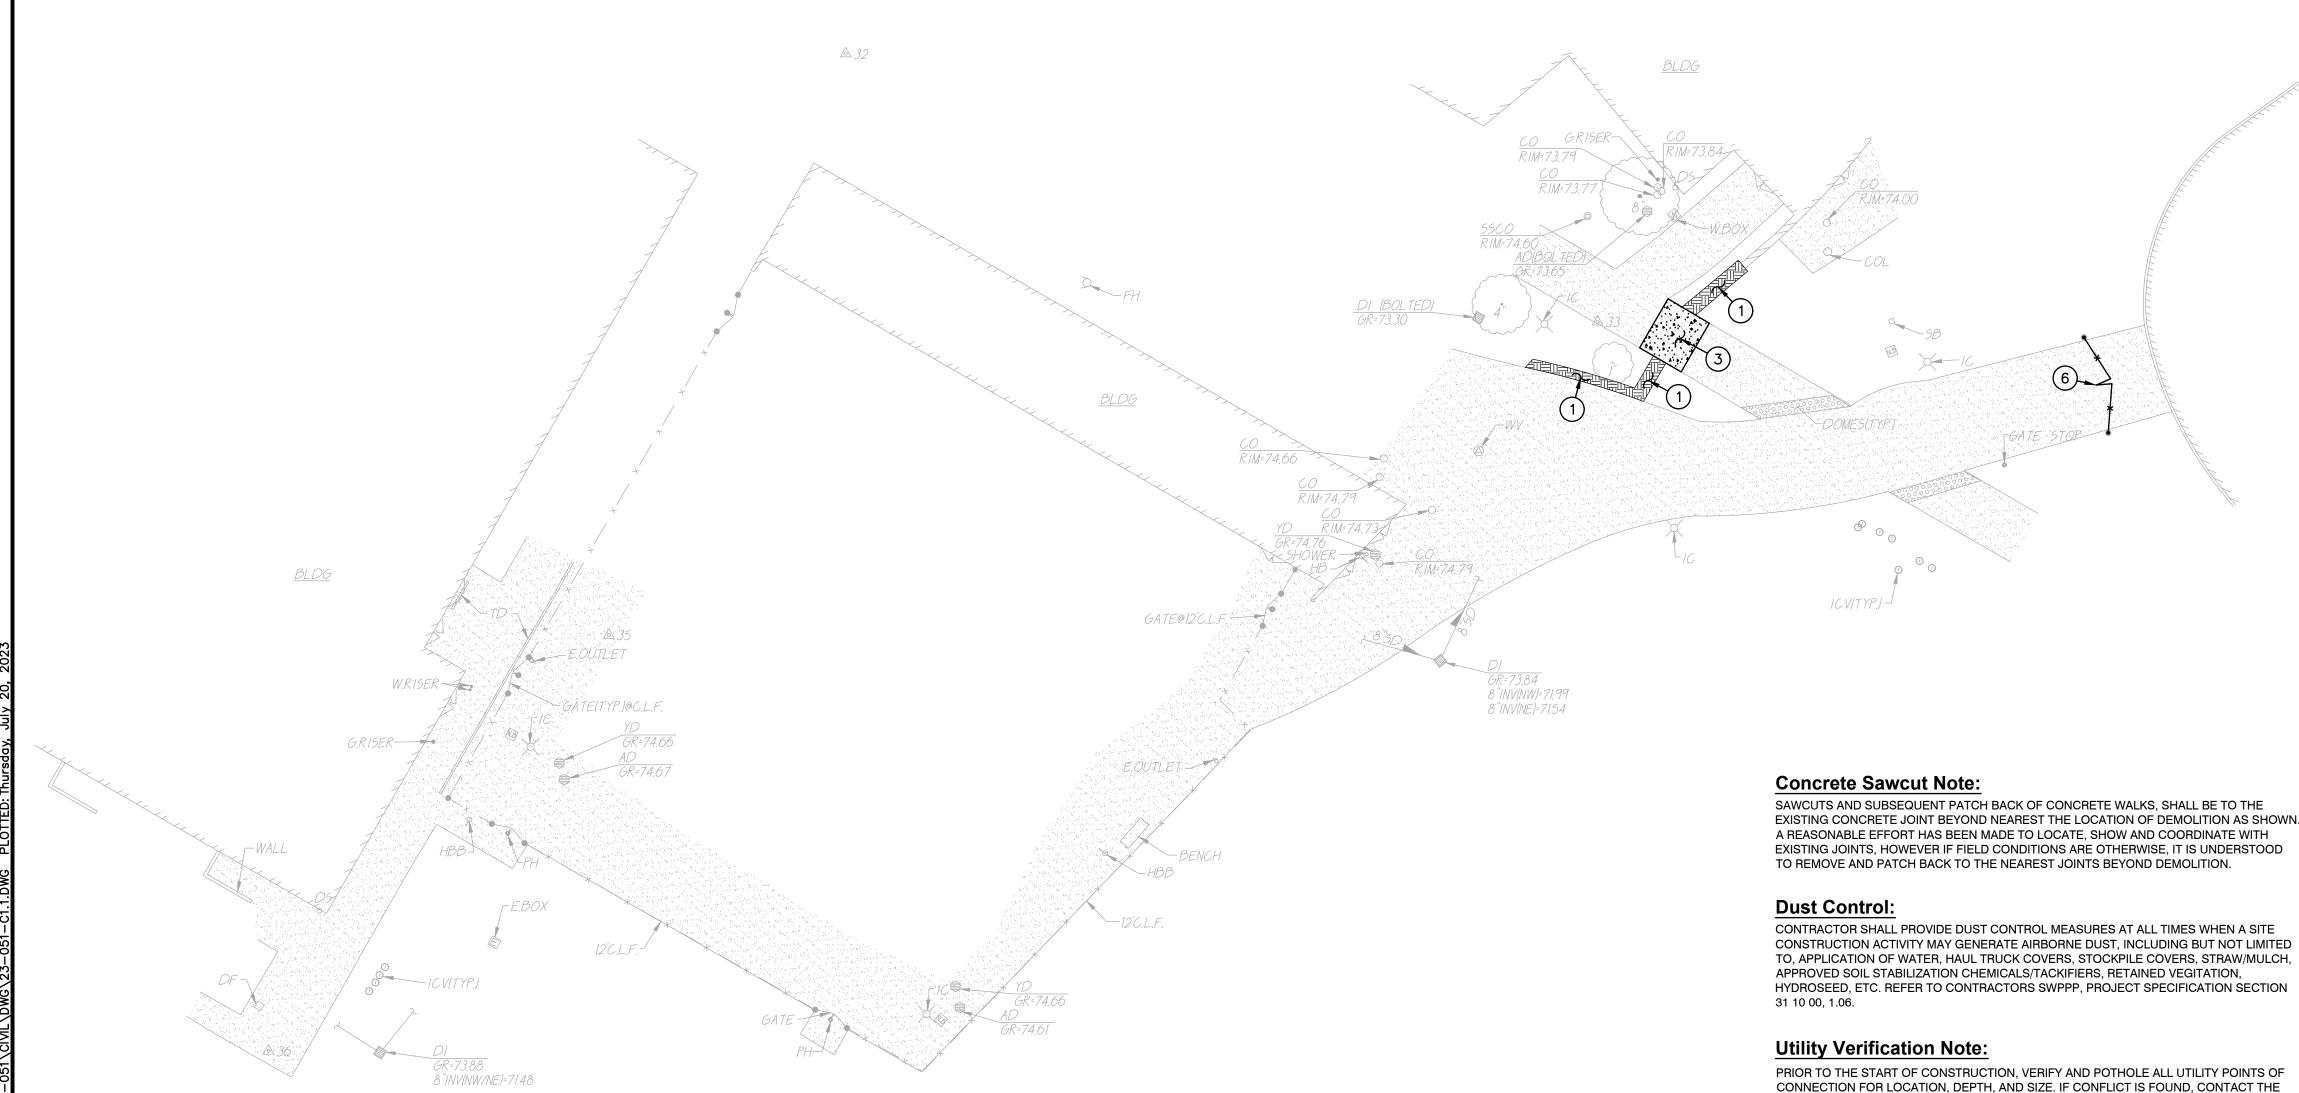

GRAPHIC SCALE

THIS DRAWING MAY HAVE BEEN ENLARGED OR REDUCED.

SCALE 1" = 20'-0"

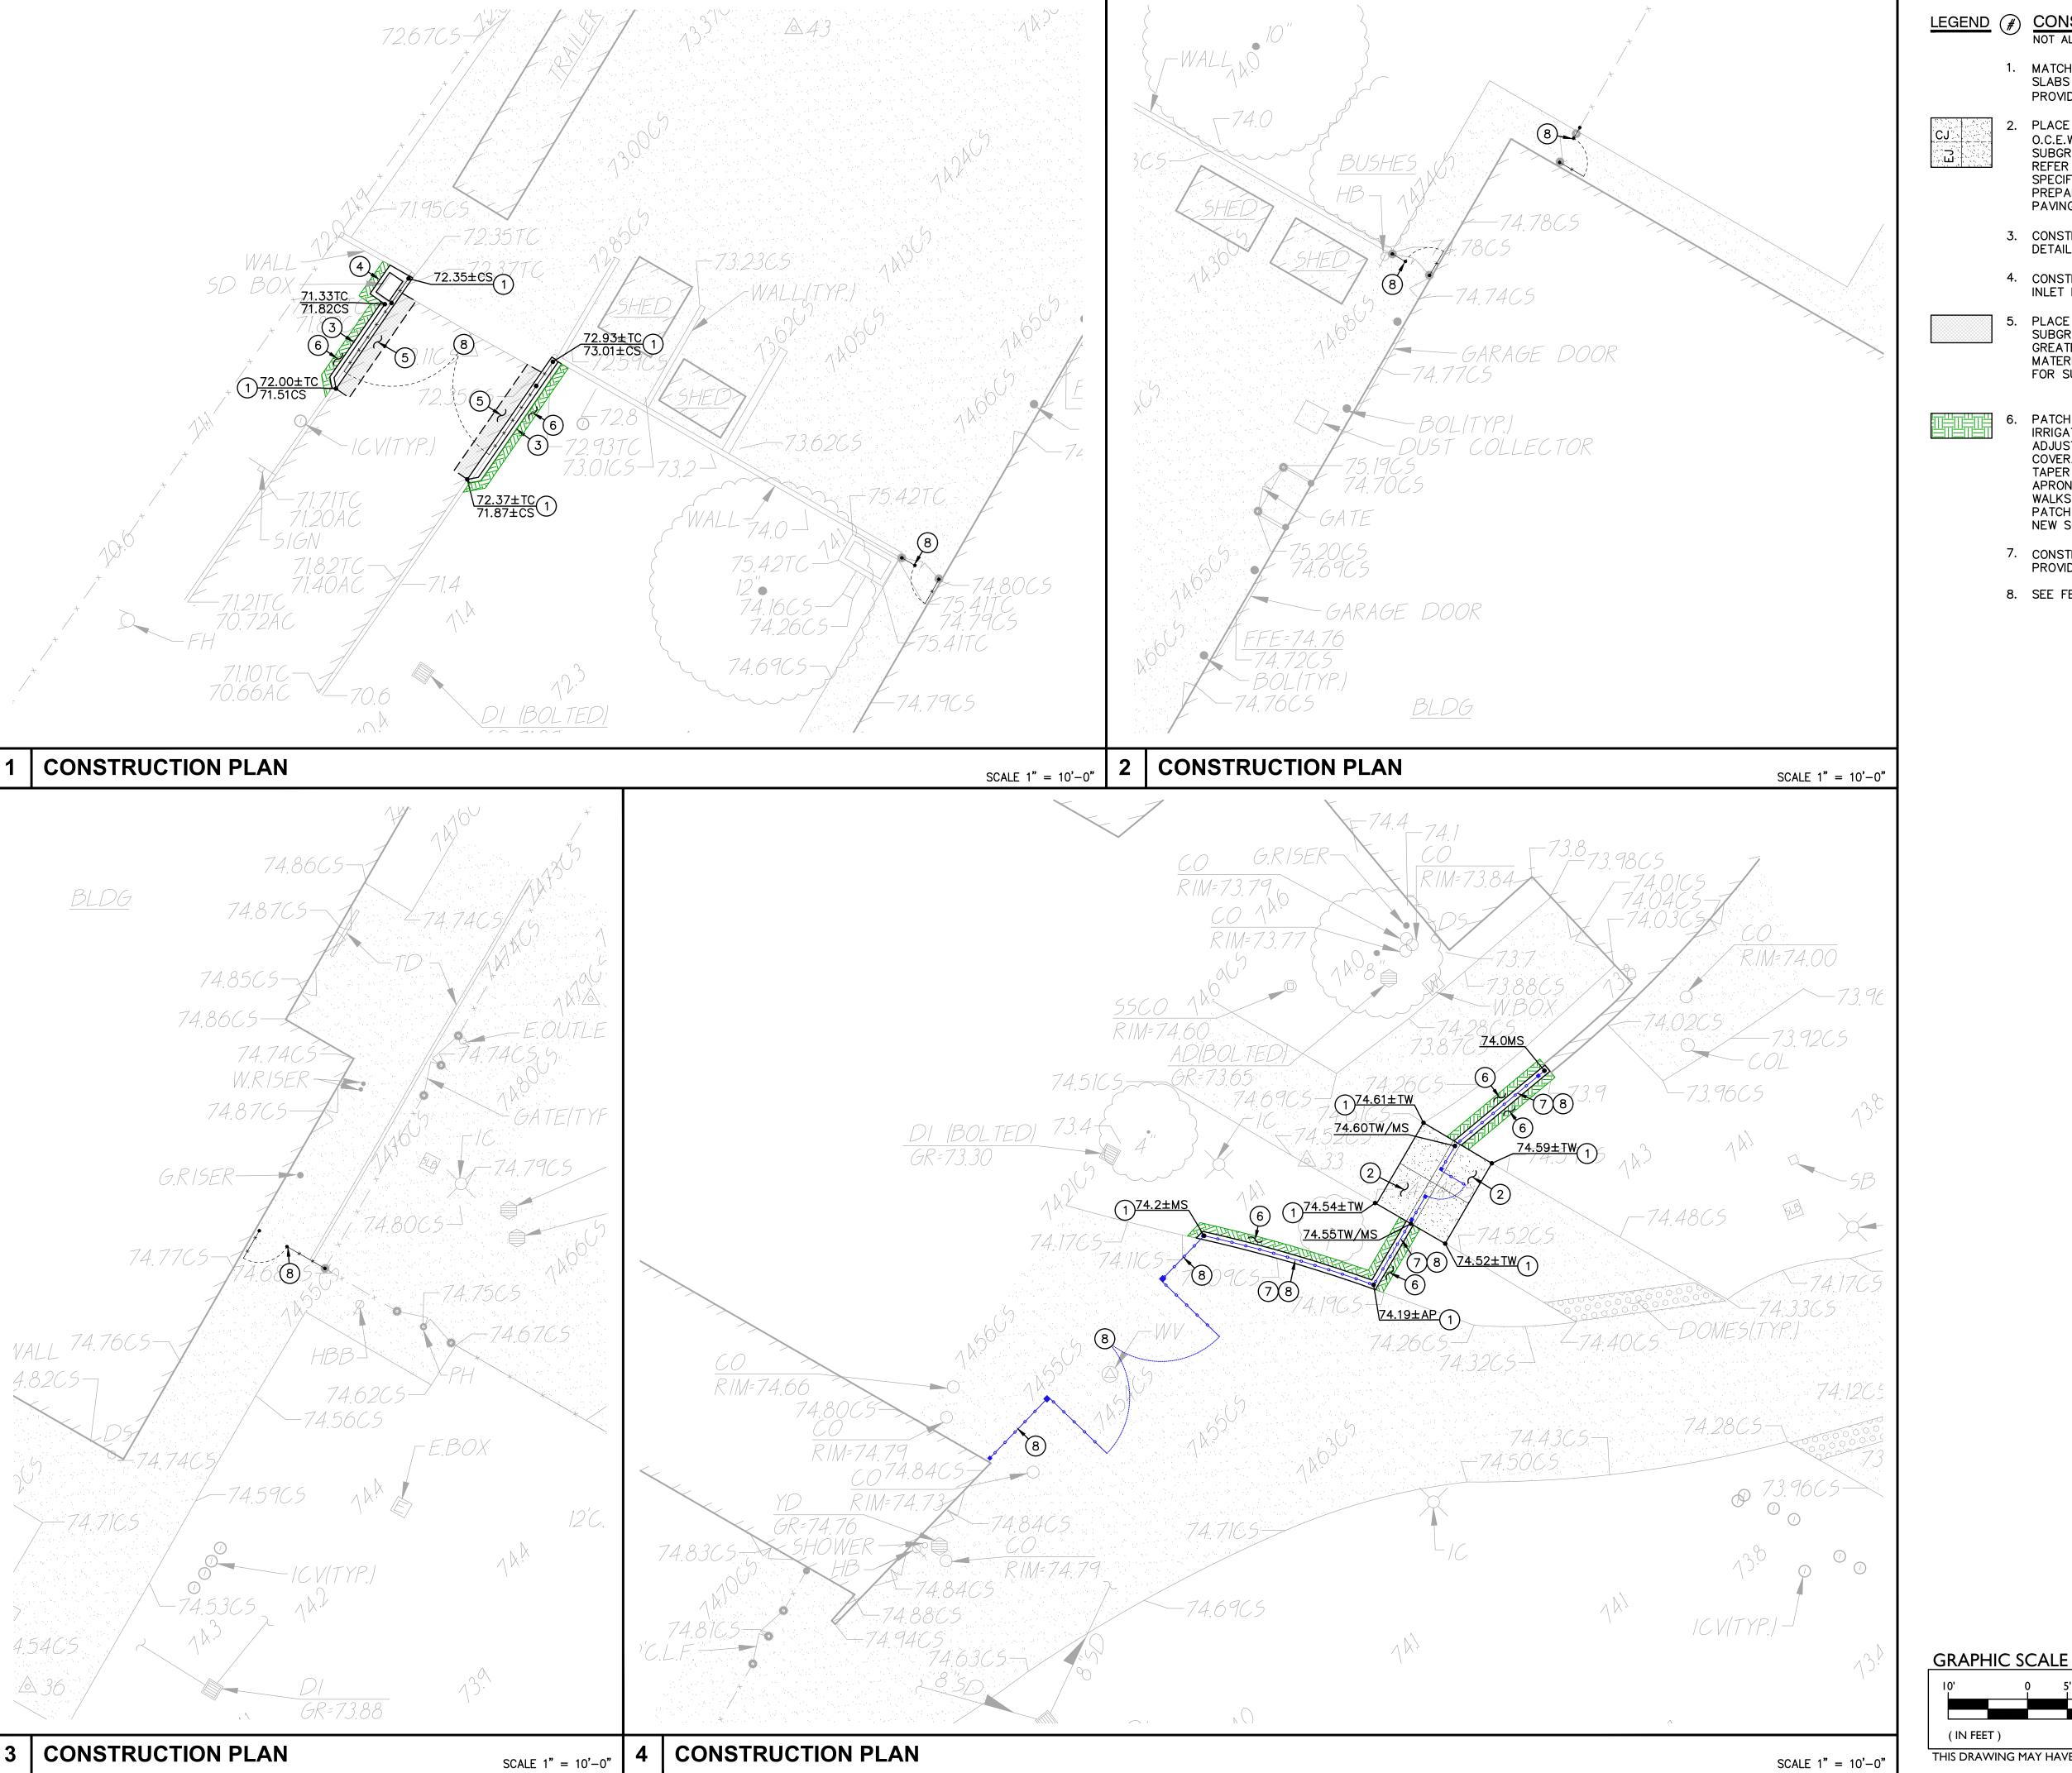

LEGEND (#) CONSTRUCTION NOTES

NOT ALL NOTES MAY BE USED ON THIS SHEET

1. MATCH EXISTING GRADE/ELEVATION. WHEN MATCHING NEW SLABS TO EXISTING, DOWEL SLABS PER THE DETAIL PROVIDED AT 24" O.C.

PLACE 5" CONCRETE PAVING WITH #4 REBAR AT 24" 1 2 O.C.E.W. OVER 6" CLASS II AB ON COMPACTED SUBGRADE PER THE TYPICAL DETAILS PROVIDED.
REFER TO PAVING PLAN FOR SECTIONS. REFER TO SPECIFICATIONS SECTION 31 00 00 FOR SUBGRADE PREPARATION, SECTION 32 16 00 FOR CONCRETE



- 4. CONSTRUCT 12" WIDE CONCRETE APRON AROUND DRAIN (C4.1)
- PLACE 3" AC PAVING OVER 12" CLASS II AB ON COMPACTED SUBGRADE, OR MATCH EXISTING SECTION, WHICHEVER IS GREATER. REFER TO SPECIFICATIONS SECTION 32 12 16 FOR MATERIALS AND CONSTRUCTION. REFER TO SECTION 31 00 00 FOR SUBGRADE PREPARATION.

PATCH AND REPAIR EXISTING LANDSCAPING AND IRRIGATION ALONG EDGE OF NEW WORK. RELOCATE AND ADJUST EXISTING HEADS AS NEEDED TO MAIAIN
COVERAGE. REPLACE ALL BROKEN HEADS RELOCATED.
TAPER ALL GRADING AWAY FROM NEW CURBS AND
APRONS AND SET GRADES BELOW APRONS, CURBS AND
WALKS TO ALLOW FOR LAWN AND OTHER PLANTING
PATCH BACK PER THE DETAILS PROVIDED. PROVIDE
NEW SOD IN DISTURBED LAWN AREAS.

- 7. CONSTRUCT 12" WIDE CONCRETE APRON PER THE DETAIL $\begin{pmatrix} 4 \\ C4.1 \end{pmatrix}$ PROVIDED.
- 8. SEE FENCING PLAN FOR NEW FENCING.



1117 WINDFIELD WAY, SUITE 110 EL DORADO HILLS, CA 95762 | (916) 985-1870

OWNER:

5 C4.1



Sacramento City **Unified School District** 5735 47th Avenue Sacramento, CA 95824-4528



Rosemont High School 2023 Fencing

9594 Kiefer Blvd. Sacramento, CA 95827

REVISIONS				
0.	DESCRIPTION			

ı	DRAWN:		SCALE:
	SMN	I	AS NOTE
	CHECKED:		PROJECT NO.
	ΑT	•	23-05
	DESIGNED:		DATE:
	CMNI /AT		OF /01 /2023


ISSUANCE:


SHEET TITLE:

GRADING PLAN

SHEET NO.

C2.1

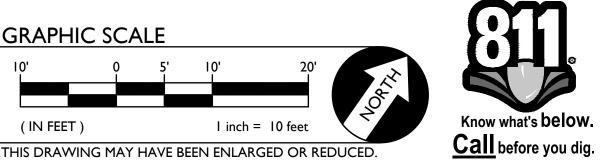

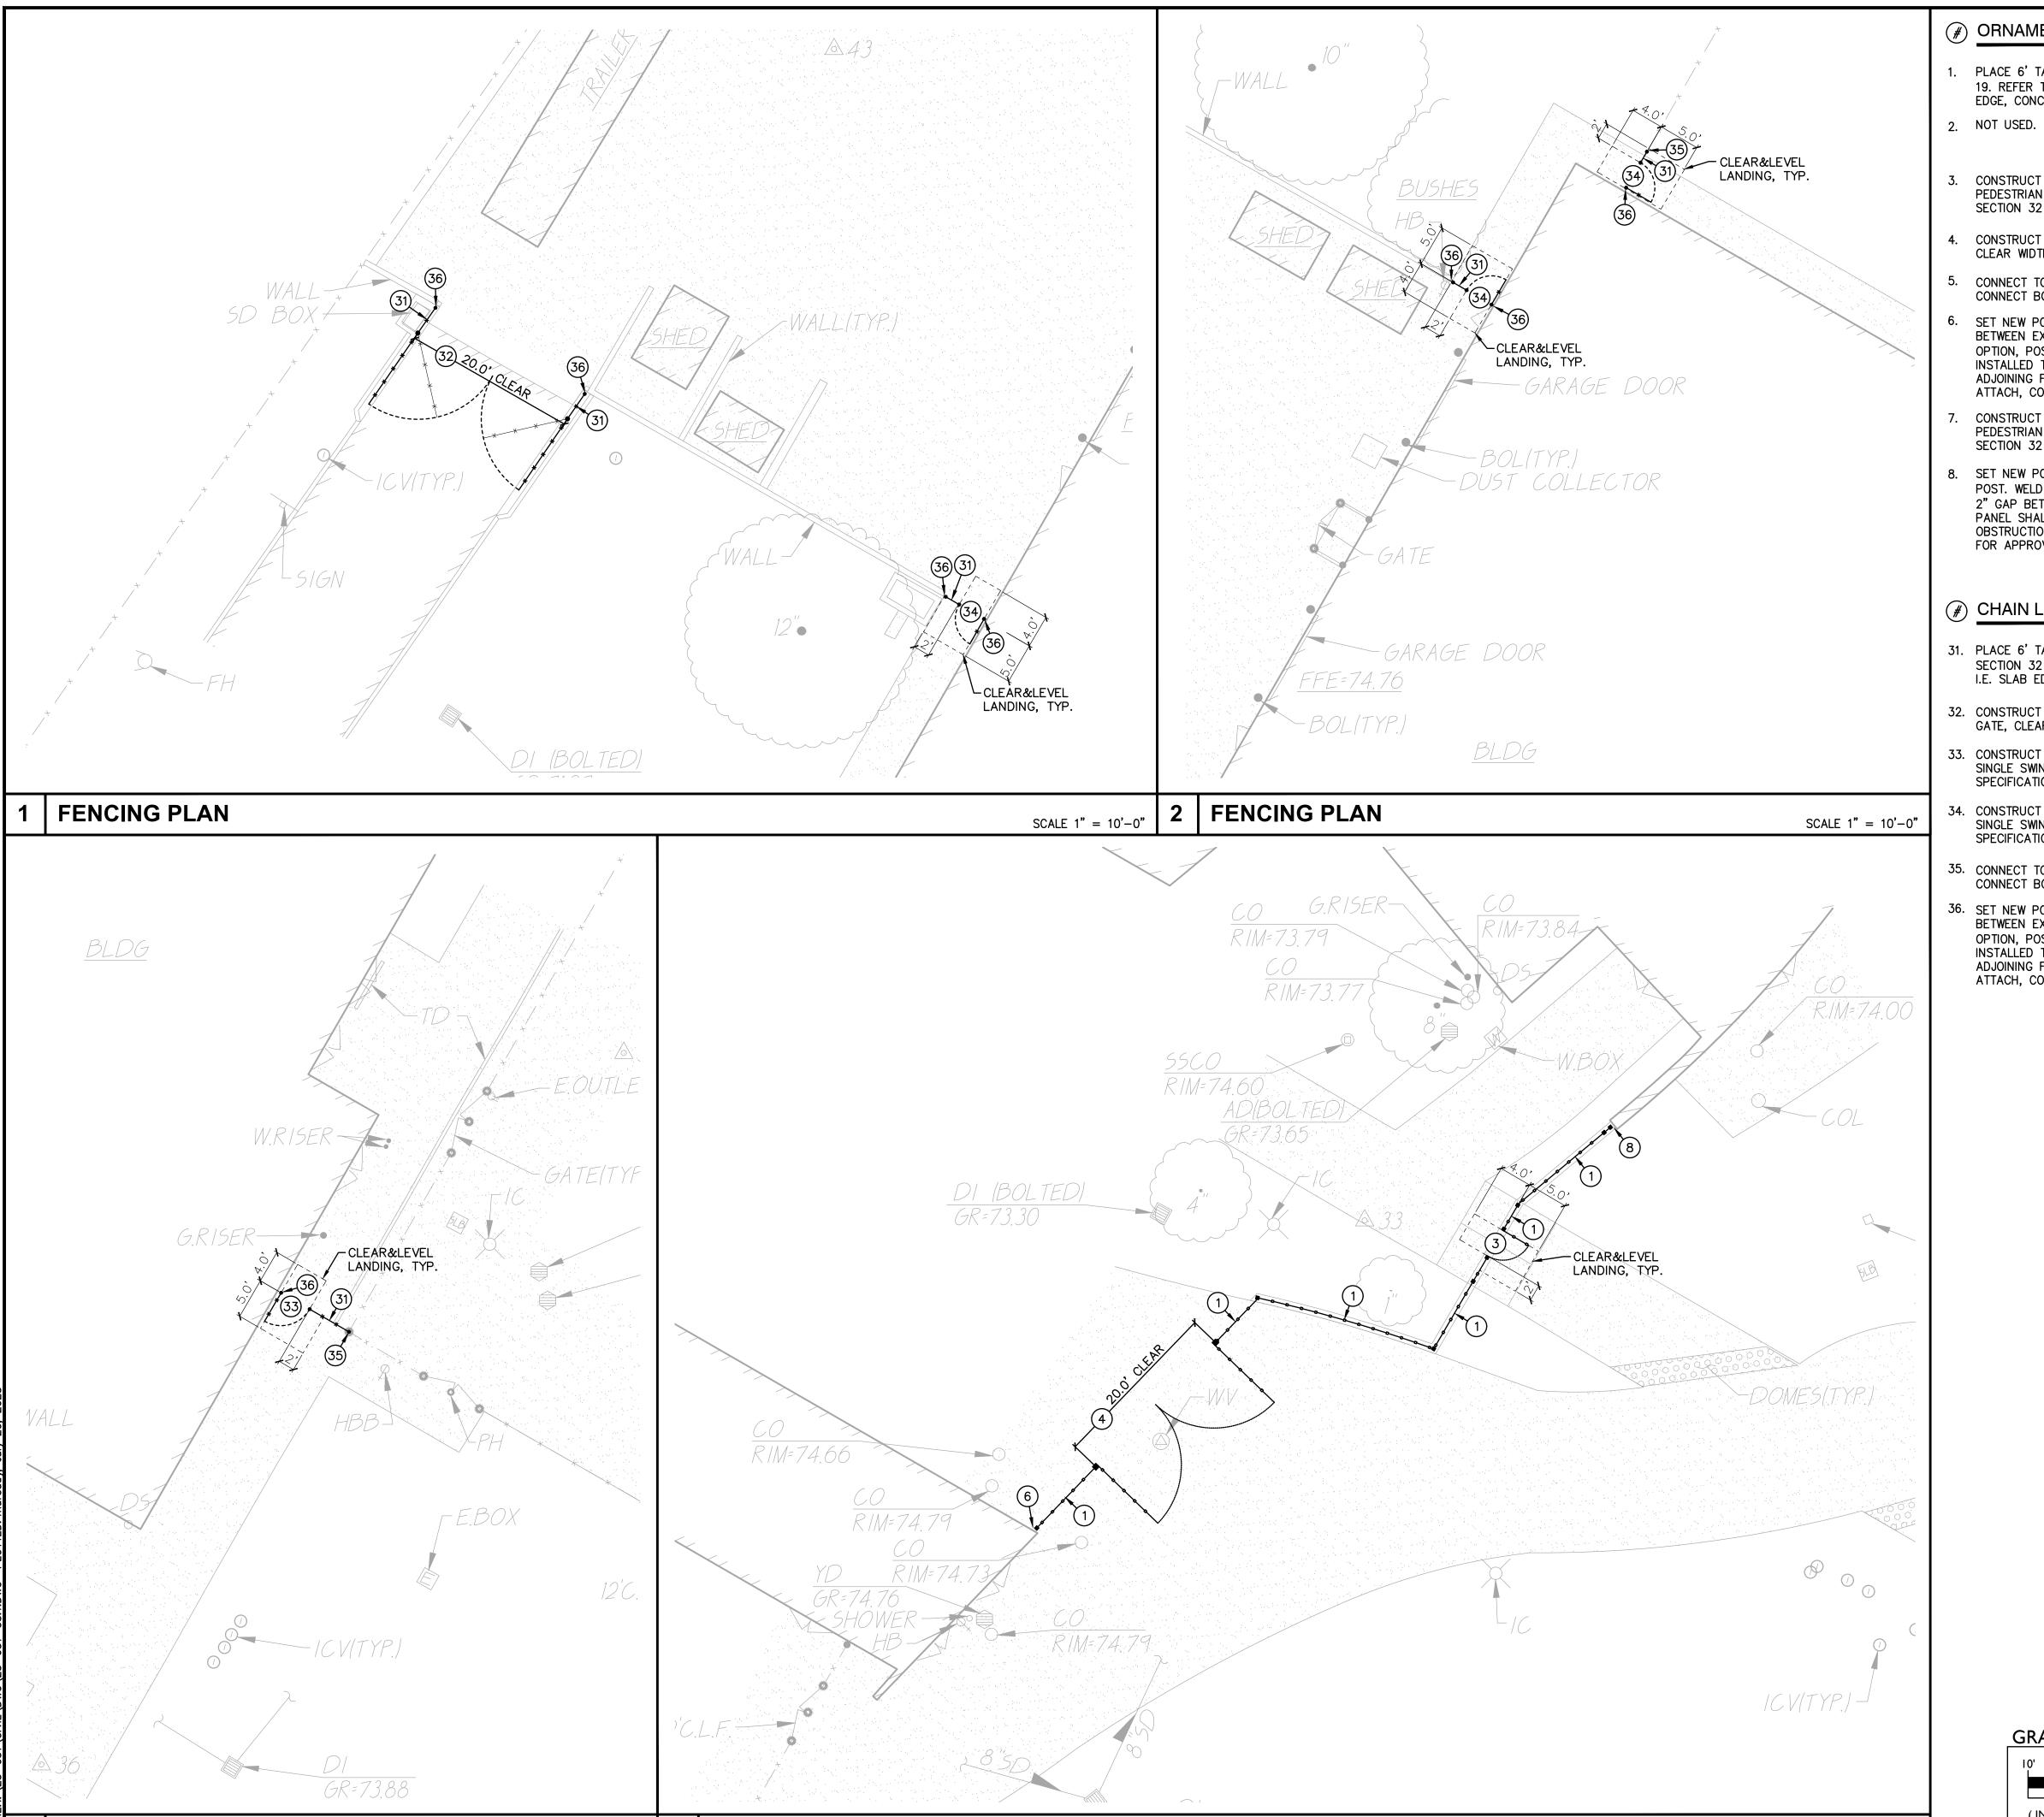

FENCING PLAN

SCALE 1" = 10'-0"

FENCING PLAN

(#) ORNAMENTAL FENCING NOTES

- 1. PLACE 6' TALL 3-RAIL ORNAMENTAL FENCING. REFER TO SPECIFICATIONS SECTION 32 31 19. REFER TO GRADING/CONSTUCTION PLAN FOR FOUNDATION CONDITION, I.E. SLAB EDGE, CONCRETE APRON, ETC. SEE ALSO TYPICAL FENCING DETAILS PROVIDED.
- 3. CONSTRUCT 6' TALL BLACK 3-RAIL ORNAMENTAL 48" WIDE (NOMINAL) SINGLE SWING PEDESTRIAN GATE WITH PANIC HARDWARE AND CLOSERS. REFER TO SPECIFICATIONS SECTION 32 31 19. AND DETAILS PROVIDED.
- 4. CONSTRUCT 6' TALL BLACK 3-RAIL ORNAMENTAL DOUBLE SWING MAINT. ACCESS GATE, CLEAR WIDTH AS NOTED, REFER TO SPECIFICATIONS SECTION 32 31 19.
- 5. CONNECT TO EXISTING FENCING/POST. IF NO EXISTING POST, SET NEW POST AND CONNECT BOTH NEW AND EXISTING FENCING TO NEW POST.
- 6. SET NEW POST SO THAT THERE IS NO MORE THAN 4" GAP BUT NO LESS THAN 2" GAP BETWEEN EXISTING WALL OR OTHER OBSTRUCTION AND EDGE OF NEW POST. AT CONTRACTORS OPTION, POST MAY BE SET AT 12" FROM OBSTRUCTION AND A WELDED CLOSURE PANEL INSTALLED TO REDUCE GAP TO THE ABOVE STATED. CLOSURE PANEL SHALL MATCH THAT OF ADJOINING FENCING AND MAY BE ATTACHED TO WALL OR OBSTRUCTION. IF PLANNED TO ATTACH, CONTRACTOR TO PROVIDE METHOD OF ATTACHMENT FOR APPROVAL.
- 7. CONSTRUCT 6' TALL BLACK 3-RAIL ORNAMENTAL 42" WIDE (NOMINAL) SINGLE SWING PEDESTRIAN GATE WITH PANIC HARDWARE AND CLOSERS. REFER TO SPECIFICATIONS SECTION 32 31 19. AND DETAILS PROVIDED.
- 8. SET NEW POST OFFSET FROM ANGLED WALL TO ALLOW 3" CLEAR FROM WALL AT THE TOP OF POST. WELD CLOSURE PANEL SO THAT THERE IS NO MORE THAN 4" GAP BUT NO LESS THAN 2" GAP BETWEEN EXISTING WALL OR OTHER OBSTRUCTION AND EDGE OF NEW POST. CLOSURE PANEL SHALL MATCH THAT OF ADJOINING FENCING AND MAY BE ATTACHED TO WALL OR OBSTRUCTION. IF PLANNED TO ATTACH, CONTRACTOR TO PROVIDE METHOD OF ATTACHMENT FOR APPROVAL.

CHAIN LINK FENCING NOTES

- 31. PLACE 6' TALL BLACK VINYL COATED CHAIN LINK FENCING. REFER TO SPECIFICATIONS SECTION 32 31 13. REFER TO GRADING/CONSTUCTION PLAN FOR FOUNDATION CONDITION, I.E. SLAB EDGE, CONCRETE APRON, ETC. SEE ALSO TYPICAL FENCING DETAILS PROVIDED.
- 32. CONSTRUCT 6' TALL BLACK VINYL COATED CHAIN LINK DOUBLE SWING MAINT. ACCESS GATE, CLEAR WIDTH AS NOTED, REFER TO SPECIFICATIONS SECTION 32 31 13. $\frac{5}{\text{C4.3}}$
- 33. CONSTRUCT 6' TALL BLACK VINYL COATED CHAIN LINK FENCING 48" WIDE (NOMINAL) SINGLE SWING PEDESTRIAN GATE WITH PANIC HARDWARE AND CLOSERS. REFER TO SPECIFICATIONS SECTION 32 31 13. AND DETAILS PROVIDED.
- 34. CONSTRUCT 6' TALL BLACK VINYL COATED CHAIN LINK FENCING 42" WIDE (NOMINAL) SINGLE SWING PEDESTRIAN GATE WITH PANIC HARDWARE AND CLOSERS. REFER TO SPECIFICATIONS SECTION 32 31 13. AND DETAILS PROVIDED.
- 35. CONNECT TO EXISTING FENCING/POST. IF NO EXISTING POST, SET NEW POST AND CONNECT BOTH NEW AND EXISTING FENCING TO NEW POST.
- 36. SET NEW POST SO THAT THERE IS NO MORE THAN 4" GAP BUT NO LESS THAN 2" GAP BETWEEN EXISTING WALL OR OTHER OBSTRUCTION AND EDGE OF NEW POST. AT CONTRACTORS OPTION, POST MAY BE SET AT 12" FROM OBSTRUCTION AND A WELDED CLOSURE PANEL INSTALLED TO REDUCE GAP TO THE ABOVE STATED. CLOSURE PANEL SHALL MATCH THAT OF ADJOINING FENCING AND MAY BE ATTACHED TO WALL OR OBSTRUCTION. IF PLANNED TO ATTACH, CONTRACTOR TO PROVIDE METHOD OF ATTACHMENT FOR APPROVAL.



EL DORADO HILLS, CA 95762 | (916) 985-1870

OWNER:



Sacramento City
Unified School District
5735 47th Avenue
Sacramento, CA 95824-4528



Rosemont High School 2023 Fencing

9594 Kiefer Blvd. Sacramento, CA 95827

REVISIONS				
0.	DESCRIPTION			

DRAWN: SCALE:
SMN AS NOTED

CHECKED: PROJECT NO.
AT 23-051

DESIGNED: DATE:
SMN/AT 05/01/2023


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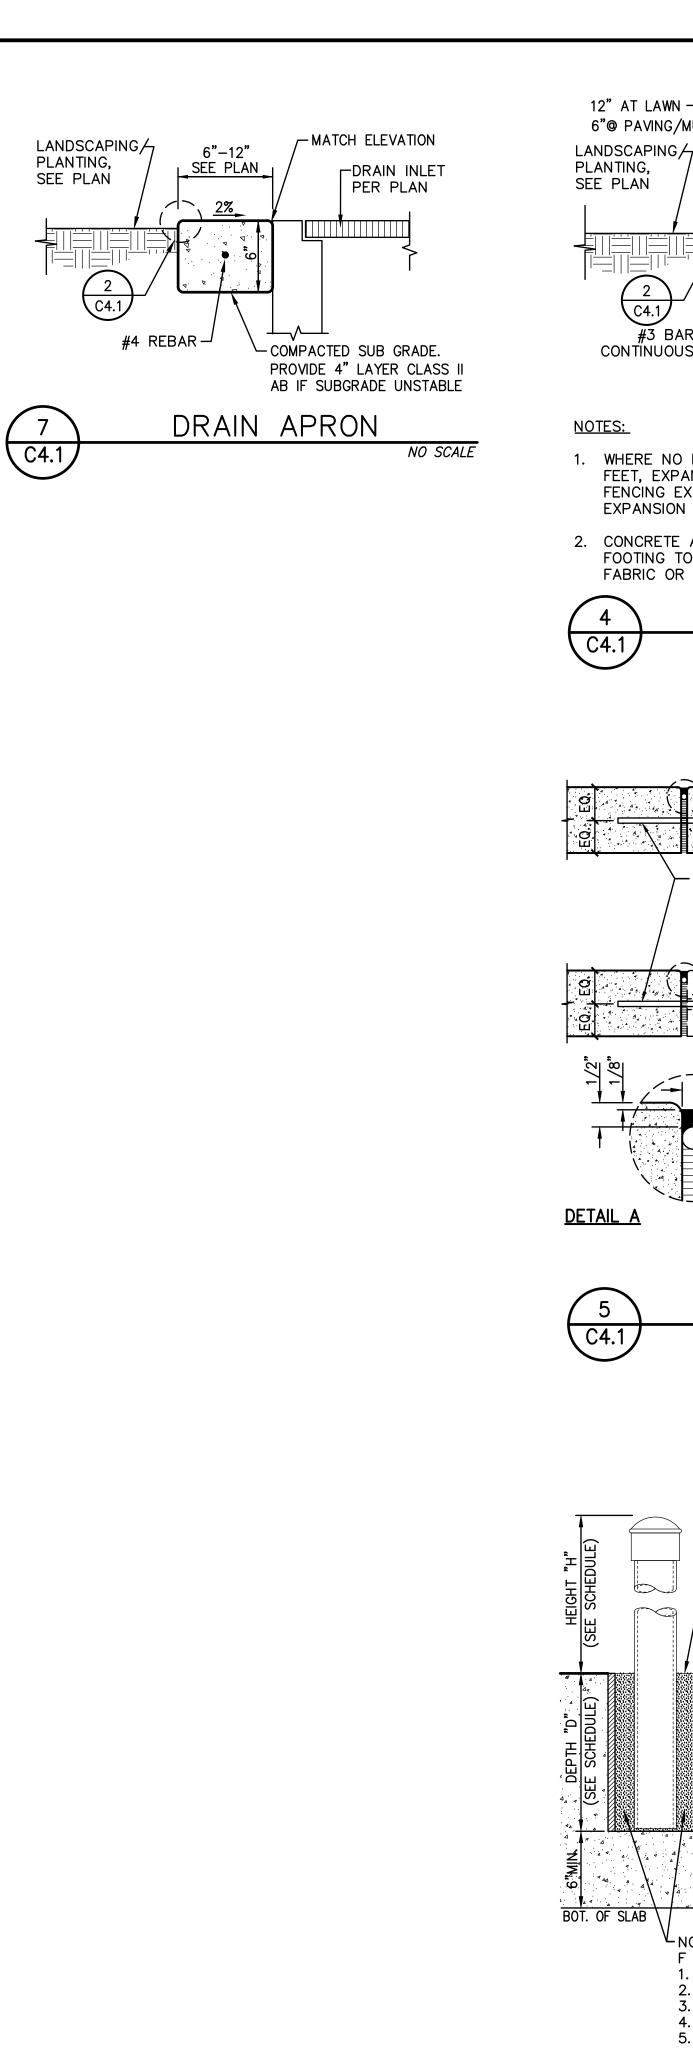
GRADING PLAN


SHEET NO.

C3.1




SCALE 1" = 10'-0"

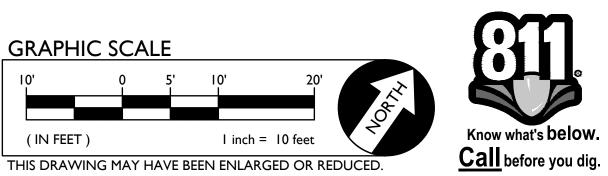

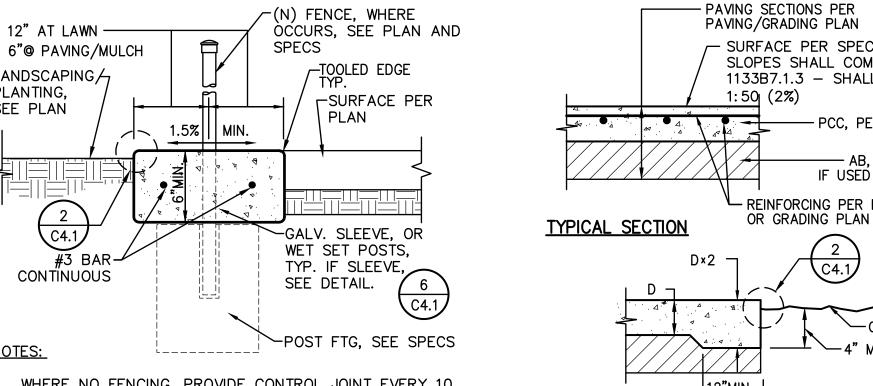


- 1. WHERE NO FENCING, PROVIDE CONTROL JOINT EVERY 10 FEET, EXPANSION JOINT EVERY 30 FEET, TYP. WHERE FENCING EXISTS, PROVIDE TOOLED JOINT EVERY POST, EXPANSION EVERY 3RD POST.
- 2. CONCRETE APRON THICKNESS MAY COUNT FOR POST FOOTING TOTAL DEPTH BUT MUST BE PLACED BEFORE FABRIC OR PANEL INSTALLATION.



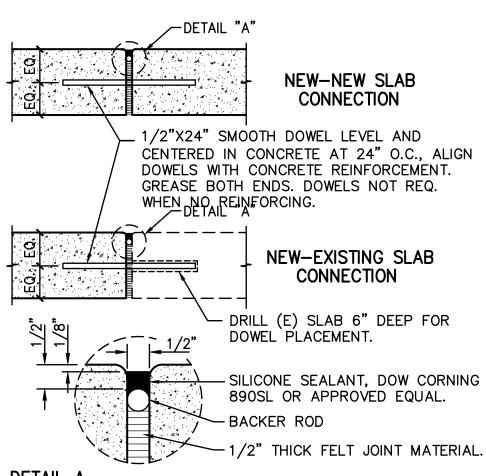



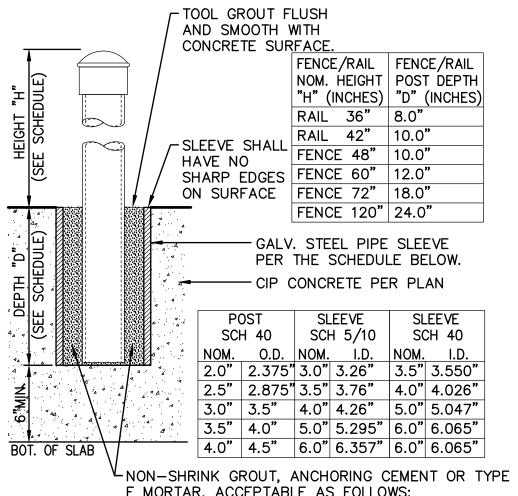


F MORTAR, ACCEPTABLE AS FOLLOWS: 1. SAKCRETE NON-SHRINK PRECISION GROUT. 2. W.R. MEADOWS SPEED-E-ROC. 3. QUICKRETE NON-SHRINK PRECISION GROUT 4. DAYTON SUPERIOR, ANCHOR-ALL 5. APPROVED EQUAL.


C4.1


POST SLEEVE DETAIL NO SCALE


- SURFACE PER SPECS. CROSS SLOPES SHALL COMPLY WITH 1133B7.1.3 - SHALL NOT EXCEED PCC, PER SPECS. - AB, PER SPECS. IF USED (SEE PLAN) REINFORCING PER PAVING OR GRADING PLAN → 12"MIN. |-TYPICAL THICKENED EDGE COLD EXTEND SLAB REINF.

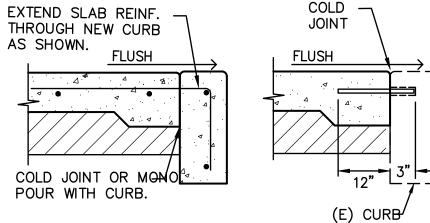


TYPICAL EXPANSION JOINT AT CURB

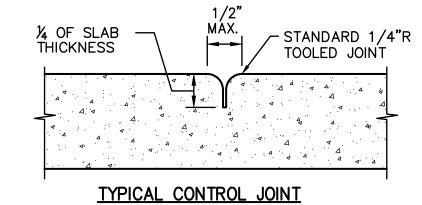


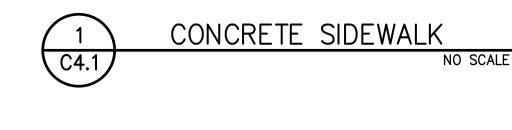

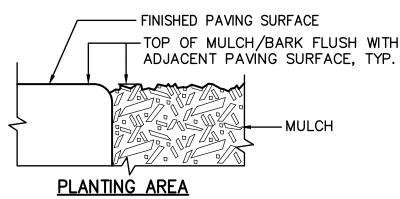


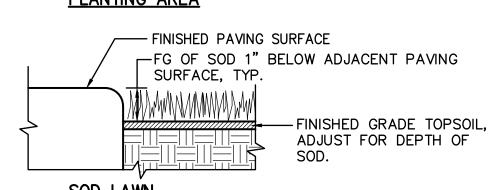

SOD LAWN

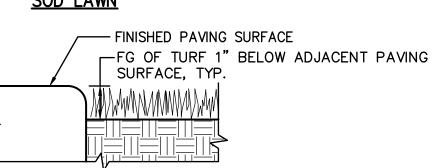



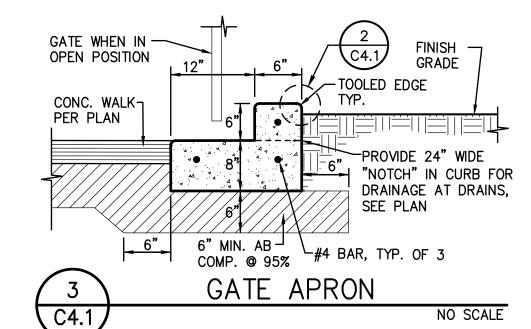

1117 WINDFIELD WAY, SUITE 110 EL DORADO HILLS, CA 95762 | (916) 985-1870

OWNER:



Sacramento City Unified School District 5735 47th Avenue Sacramento, CA 95824-4528



Rosemont High School 2023 Fencing

9594 Kiefer Blvd. Sacramento, CA 95827

REVISIONS DESCRIPTION

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	SMN	AS NOTED
HECKED:		PROJECT NO.
	ΑT	23-051
ESIGNED:		DATE:

05/01/2023

SMN/AT


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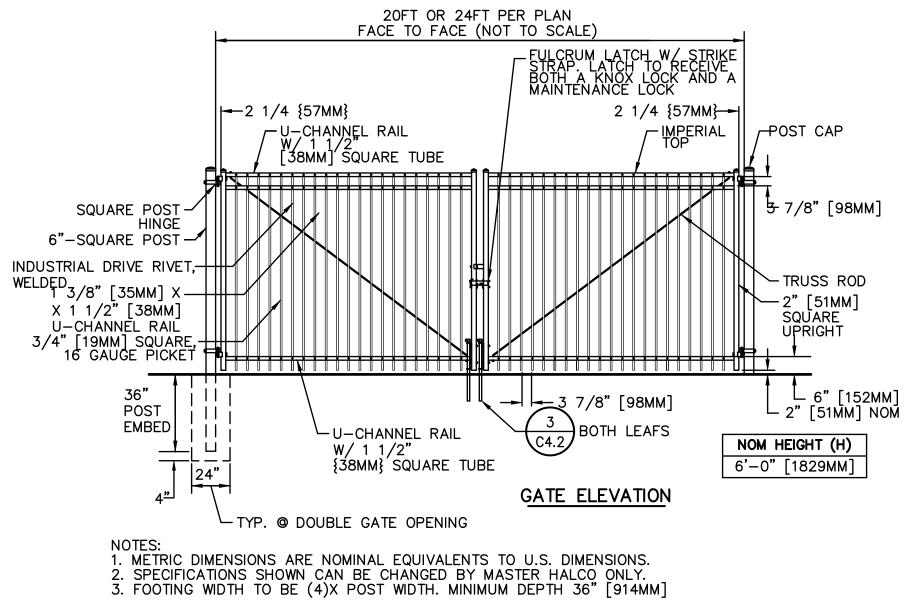
ISSUANCE:

DETAILS AND SECTIONS


SHEET NO.

C4.1



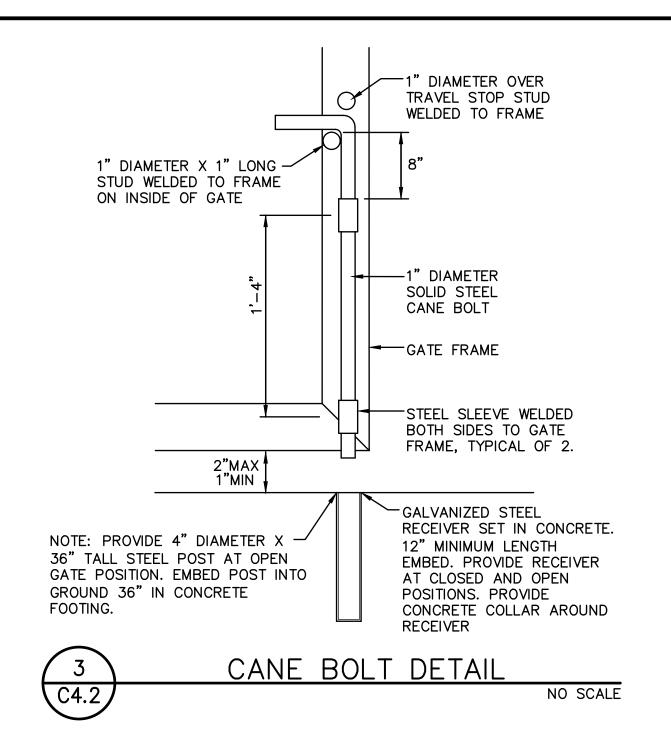

MAINTENANCE AND FIRE ACCESS ONLY, NON-ACCESSIBLE

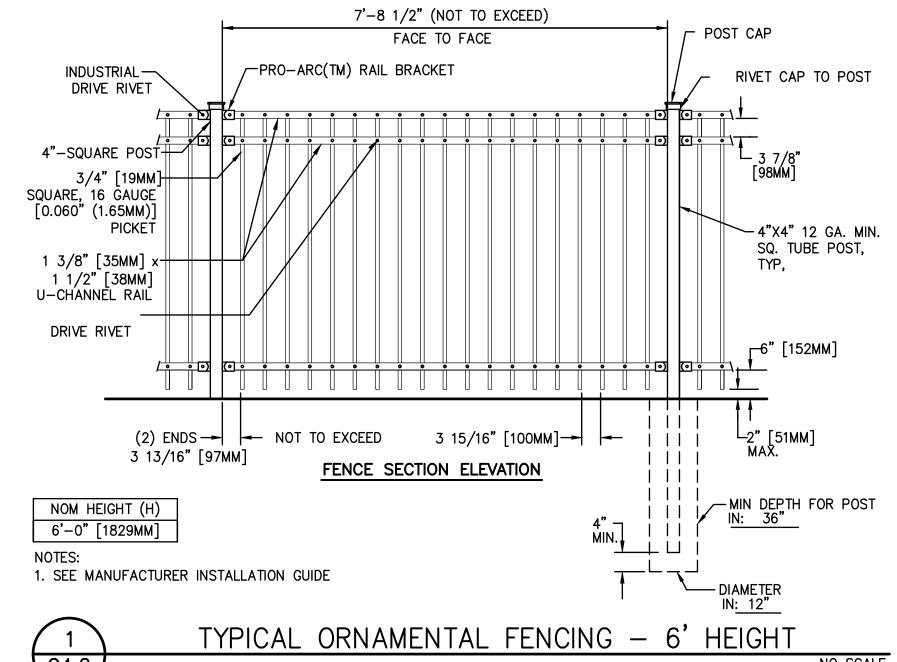

TYPICAL ORNAMENTAL ACCESSIBLE GATE - SINGLE

NO SCALE

DRAWN:

CHECKED:

DESIGNED:

ISSUANCE:

SHEET TITLE:

SHEET NO.

DSA

OWNER:

WARREN CONSULTING ENGINEERS, INC.

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1117 WINDFIELD WAY, SUITE 110

Sacramento

City Unified

Sacramento City

5735 47th Avenue

Rosemont

9594 Kiefer Blvd.

High School

2023 Fencing

Sacramento, CA 95827

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Unified School District

Sacramento, CA 95824-4528

ANTHONY . TASSANO NO. C74696

7/20/2023

School District


C4.2


DETAILS AND

SECTIONS


TYPICAL ORNAMENTAL VEHICULAR ACCESS GATE C4.2 NO SCALE NO SCALE _1"x16"x3/16" FLAT BAR. DOOR WIDTH PER PLANS WELD TO GATE FRAME WITH 3/16"x2" WELDS AT S.S. DOOR PULL, TYP.— 3" O.C. EACH SIDE, CENTER ON LATCH GORILLA HINGE SURFACE — MOUNT, WELD-ON, GREASEABLE, 2 PER GATE -ROUND CORNERS, 3/4" RADIUS 1/4", MIN.--1/4", MIN. 1/2", MAX. 1/2", MAX. SCHLAGE CYLINDER, SEE SPECS & DIST, HARDWARE STANDARDS, KEY PER DISTRICT STANDARDS. EXIT DEVICE, SEE SPECS & DIST,. ~4" X 4" X 3/16" TUBE STEEL WITH HARDWARE STANDARDS, SATIN STAINLESS STEEL TYP. PUSH FORCE JAMB POSTS, TYP. SHALL NOT EXCEED 5 LBS. L DOOR STRIKE, SEE SPECS & DISTRICT HARDWARE STANDARDS PANIC BAR CROSS SECTION SEE PLAN 39" MIN FACE TO FACE INDUSTRIAL— | 3/16 X 6" X DRIVE RIVET/ GATE WIDTH PLATE IMPERIAL 7 PROVIDE GATE -CLOSURE HARDWARE PUSH BAR AND LATCHING HARDWARE, W/ STRIKE INDUSTRIAL DRIVE RIVET -3 7/8" [98MM] 4" SQUARE POST HINGE -3 7/8" [98MM] SQUARE POST — BOTTOM TOP RAIL SCREW SCREEN TO 3/4" U CHANNEL 1/4" 9GA "FLATTENED". EXPANDED METAL WITH 3/4" 3/16 X 12" X 36" 20GA. EDGE BAND, TYP. -4"X4" FRAME 1 3/8" [35MM] X 1 1/2" [38MM] U-CHĀNNEL RAIL GORILLA HINGE -RECTANGLE **▼** TUBE UPRIGHT SPACE BETWEEN GATE AND POST— NOT TO EXCEED 1/2" — DOOR HOLD OPEN 🦳 🛚 2" SQ. UPRIGHT [51MM] — I I I I → TREMCO 16" WITH ANCHOR SET IN CONCRETE, | | | | KICK PLATE 3/16 X 3" X 36" PLATE 2" MAX. → W/STAINLESS ANCHORS EPOXY | | | | / MIN POST EMBED. DEPTH GATE ELEVATION IN CONCRETE PROVIDE 1/2" X #9 FLATTENED, EXPANDED STEEL SCREEN. EDGES SHALL BE ENCLOSED IN 20 GA. 3/4" SHAPED CAP AND EXTEND 36" FROM GATE. MM: 914 **→ →** 16" DIA 1. METRIC DIMENSIONS ARE NOMINAL EQUIVALENTS TO U.S. DIMENSIONS. 2. SPECIFICATIONS SHOWN CAN BE CHANGED BY MASTER HALCO ONLY. — GATE CLEARANCES, 3. FOOTING WIDTH TO BE (4)X POST WIDTH. NO GREATER THAN 2% 4. SEE PANEL & POST SELECTION SHEET FOR AVAILABLE POST SIZES. SLOPE ANY DIRECTION 5. ALL GATES SHALL BE WELDED AND COATED TO MATCH PANELS. WITHIN PER 11B-404.2.4.4 6. WHERE HOLD OPEN LATCH DOES NOT LAND IN CONCRETE WALK, PROVIDE 8" DIA. 12" DEEP CONCRETE FOOTING 7. PROVIDE KICK PLATE ON BOTH SIDES OF GATE. THE FULL WIDTH OF THE GATE SURFACE SHALL BE SMOOTH AND FREE OF SHARP OR ABRASIVE EDGES AT KICK PLATE (11B-404.2.10) 8. GATE AND GRAME TO BE FABRICATED OFF SITE BY THIRD PARTY. SEE - FLUSH TRANSITION THRU SPECIFICATIONS. #_____ GATE PER 11B-404.2.5 9. PROVIDE CONTINUOUS WELDS, GRIND AND SAND SMOOTH PRIOR TO POWDER COATING. TYPICAL GATE CLEARANCE

C4.2

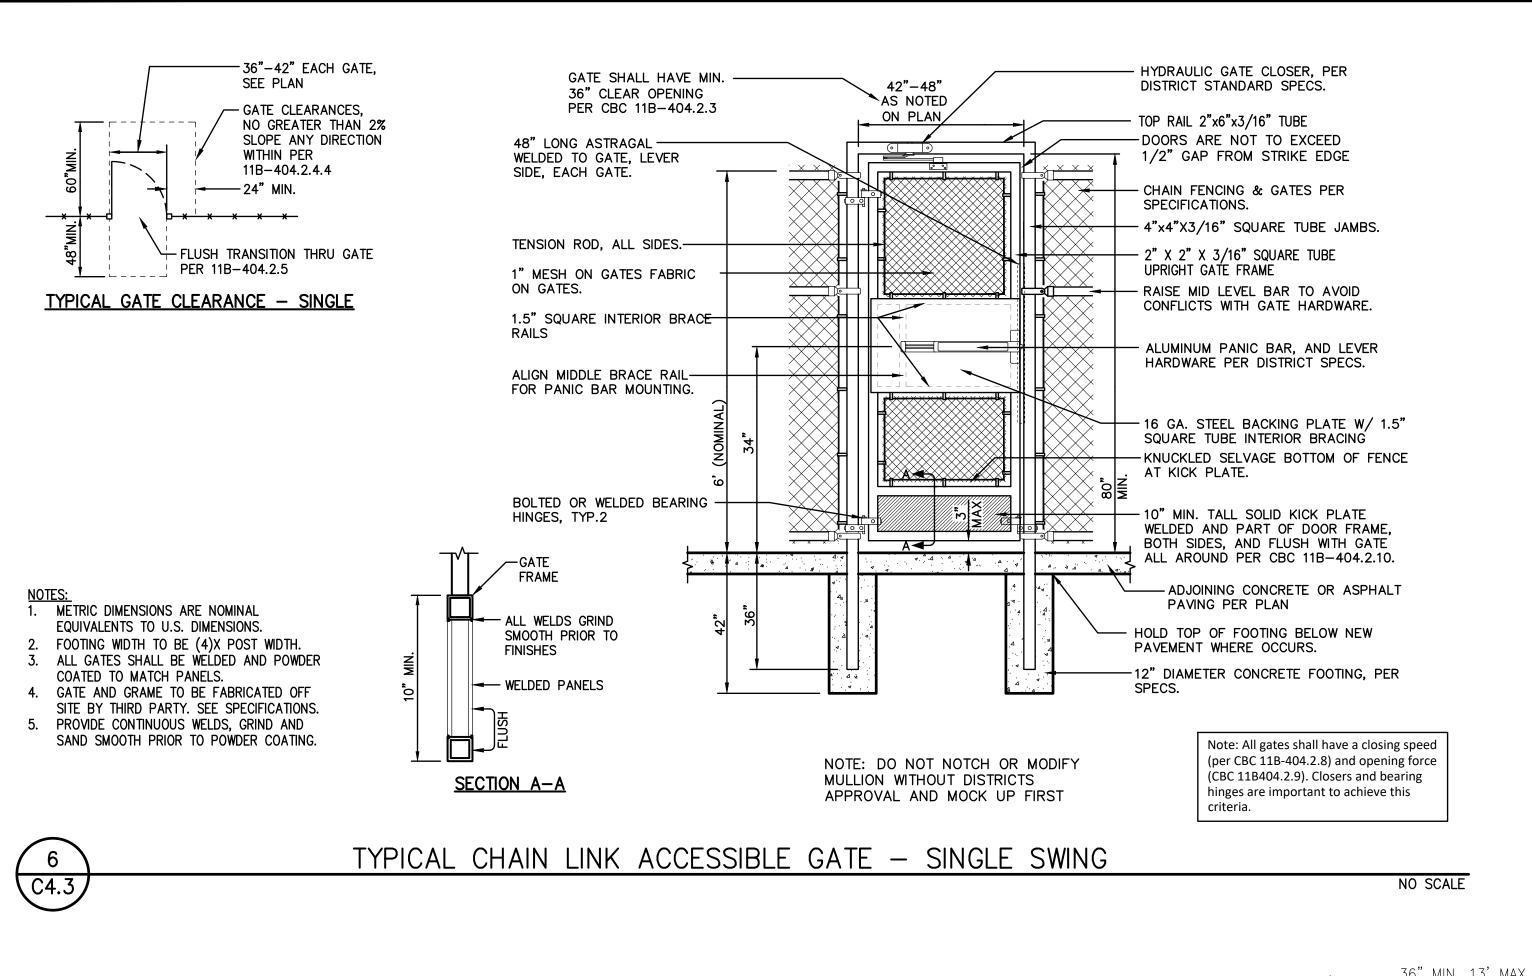

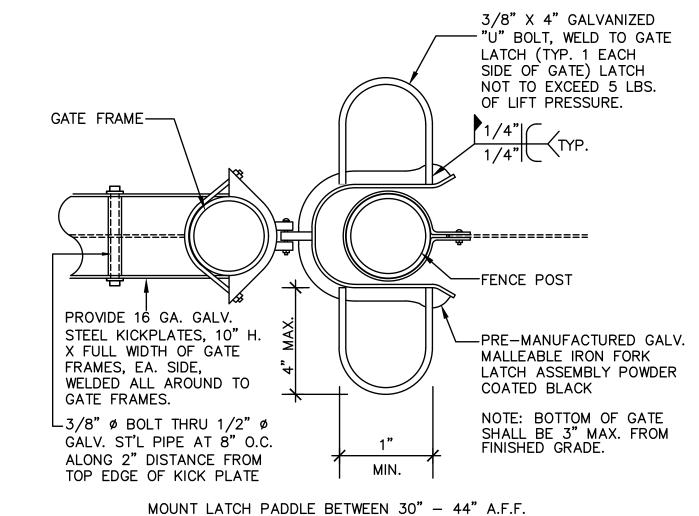



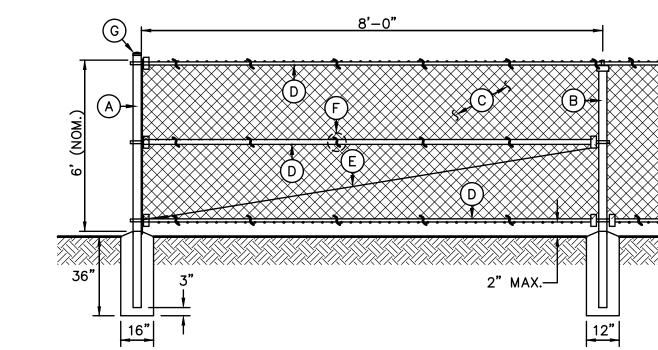

A - TERMINAL/CORNER - 4.0"OD SCH. 40 GALV. STEEL POST, POWDER COATED BLACK. B - LINE POST - 2.875"OD SCH. 40 GALV. STEEL POST, POWDER COATED BLACK.

C - 9 GA. CHAIN LINK FENCE. BLACK VINYL. MESH PER PLAN. TYPE A - 1.75" MESH - GALV. FINISH. TYPE B - 1.0" MESH - BLACK VINYL COATING


TYPE C - 2.0" MESH - BLACK VINYL COATING TYPE D - 3.5"x5" DIAMOND MESH WITH PRIVACY SLATS D - 1.66" OD SCH. 40 GALV. STEEL RAILS, POWDER COATED BLACK. TOP AND BOTTOM ALL SECTIONS, MID AT ALL CORNER AND TERMINAL POSTS.

E - 3/8" OD ADJUSTABLE INDUSTRIAL TRUSS ROD, POWDER COATED BLACK. F - 9 GA. GALVANIZED STEEL TIES AT 12" OC HORIZ. AND VERT. G - ALL CAPS AND FITTINGS HEAVY INDUSTRIAL GALV. GRADE, POWDER COATED BLACK.

6' TALL CHAIN LINK FENCING

C4.3 BLACK VINYL COATED

NO SCALE

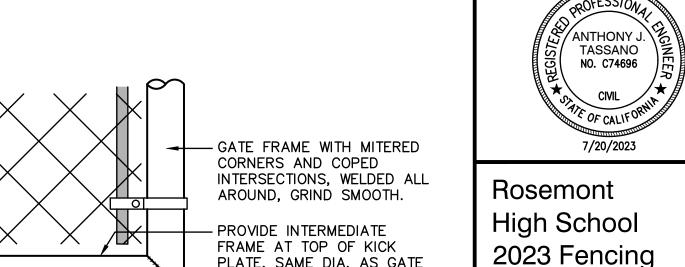

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PLATE, SAME DIA. AS GATE FRAME – PROVIDE 16 GA. GALV. STEEL KICKPLATES, 10" HIGH, FOR THE FULL WIDTH BOTH SIDES OF GATE. - WELDED TO GATE FRAME ALL AROUND - NOTE: BOTTOM OF GATE FINISHED GRADE. SHALL BE 2" MAX. FROM

ACCESSIBLE KICKPLATE C4.3

FINISHED GRADE. NO SCALE **REVISIONS** DESCRIPTION

> DRAWN: SCALE: AS NOTED CHECKED: PROJECT NO. 23-051 DESIGNED: SMN/AT 05/01/2023


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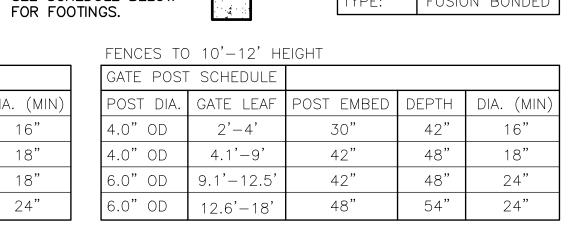
ISSUANCE:

DETAILS AND SECTIONS

SHEET NO.

C4.3



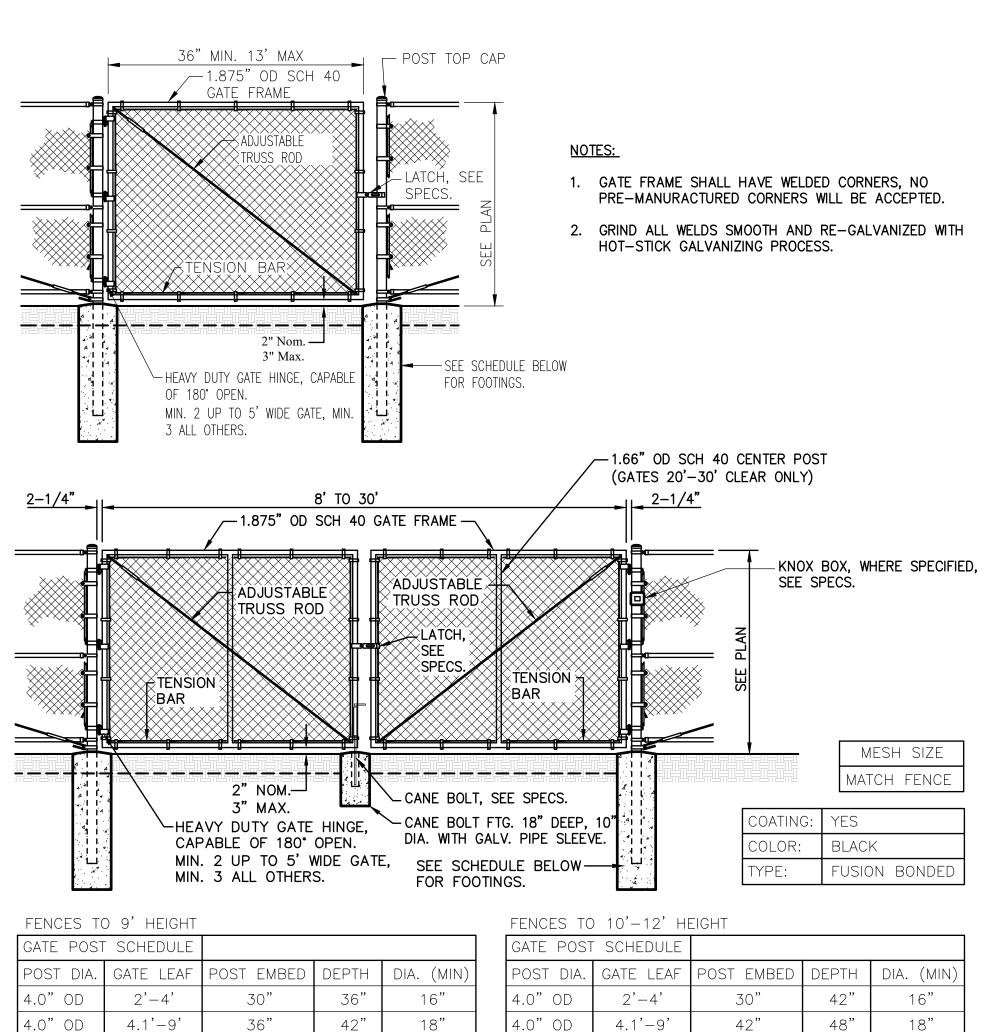

TYPICAL CHAIN LINK VEHICULAR GATE C4.3 NON-ACCESSIBLE VEHICULAR GATES ONLY

48"

48"

42"

42"

C4.3

NO SCALE

NOT USED

4.0" OD

6.0" OD

9.1' - 12.5'

12.6'-18'

NO SCALE